# TOILET ROOM RENOVATIONS FOR: WESTERN HIGH SCHOOL BAY CITY PUBLIC SCHOOLS AUBURN, MICHIGAN

# CONTACTS

# ARCHITECT

OFFICE OF THE ARCHITECT:



**WTA** ARCHITECTS 100 S. JEFFERSON AVENUE, SUITE 601 SAGINAW, MICHIGAN 48607 PHONE: (989) 752-8107 EMAIL: DESIGN@WTAARCH.COM

STRUCTURAL ENGINEER:



MACMILLAN ASSOCIATES, INC '14 E. MIDLAND STREET BAY CITY, MICHIGAN 48706 PHONE: (989) 894-4300 FAX: (989) 864-9930

CONSTRUCTION MANAGER:

WOLGAST CORPORATION 4835 TOWNE CENTER ROAD, SUITE 2023 SAGINAW, MICHIGAN 48604 PHONE: (989) 790-9120 EMAIL: WOLGAST@WOLGAST.COM

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A2.12	ENLARGED DEMOL
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ELECTRICAL

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E2.01	ELECTRICAL PLAN
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ION, ABBREVIATIONS & MOUNTING HEIGHTS

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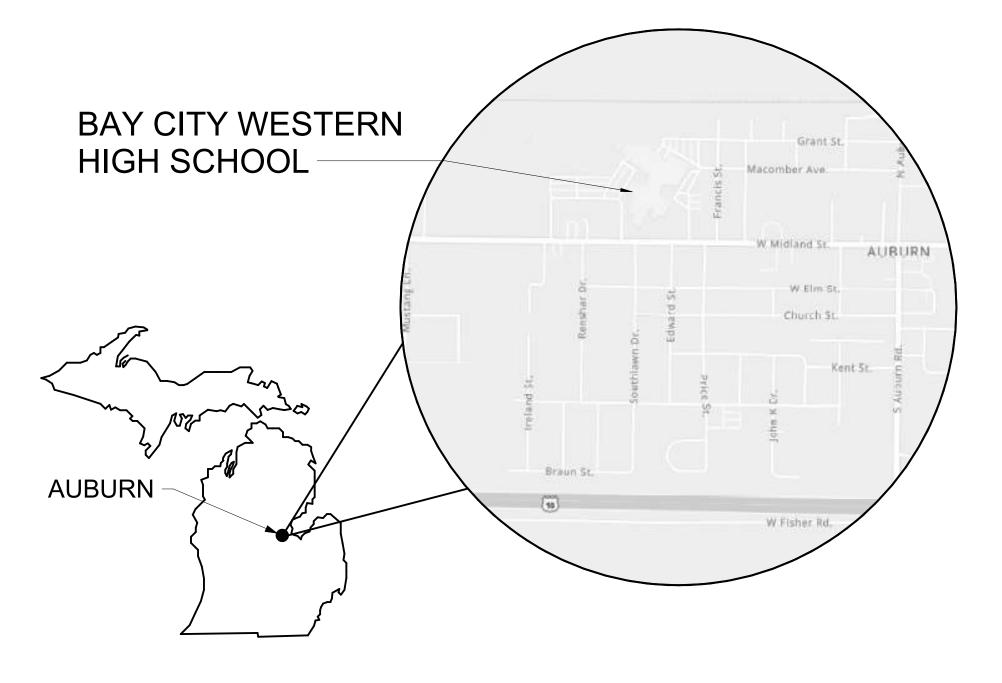
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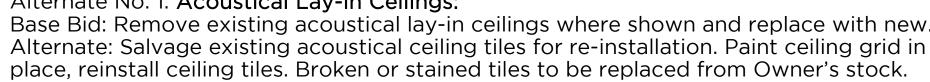
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### **ALTERNATES:**


- A. Alternate No. 1: Acoustical Lay-in Ceilings:
- B. Alternate No. 2: **Toilet Compartments**: Base Bid: Provide products manufactured by Scranton Products as specified. panel color and texture to match base bid specified panel.






Alternate: Provide products manufactured by one of listed Substitute Manufacturers in

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NORTH LOWER LEVEL MASTER PLAN SCALE: 1" = 30'-0"

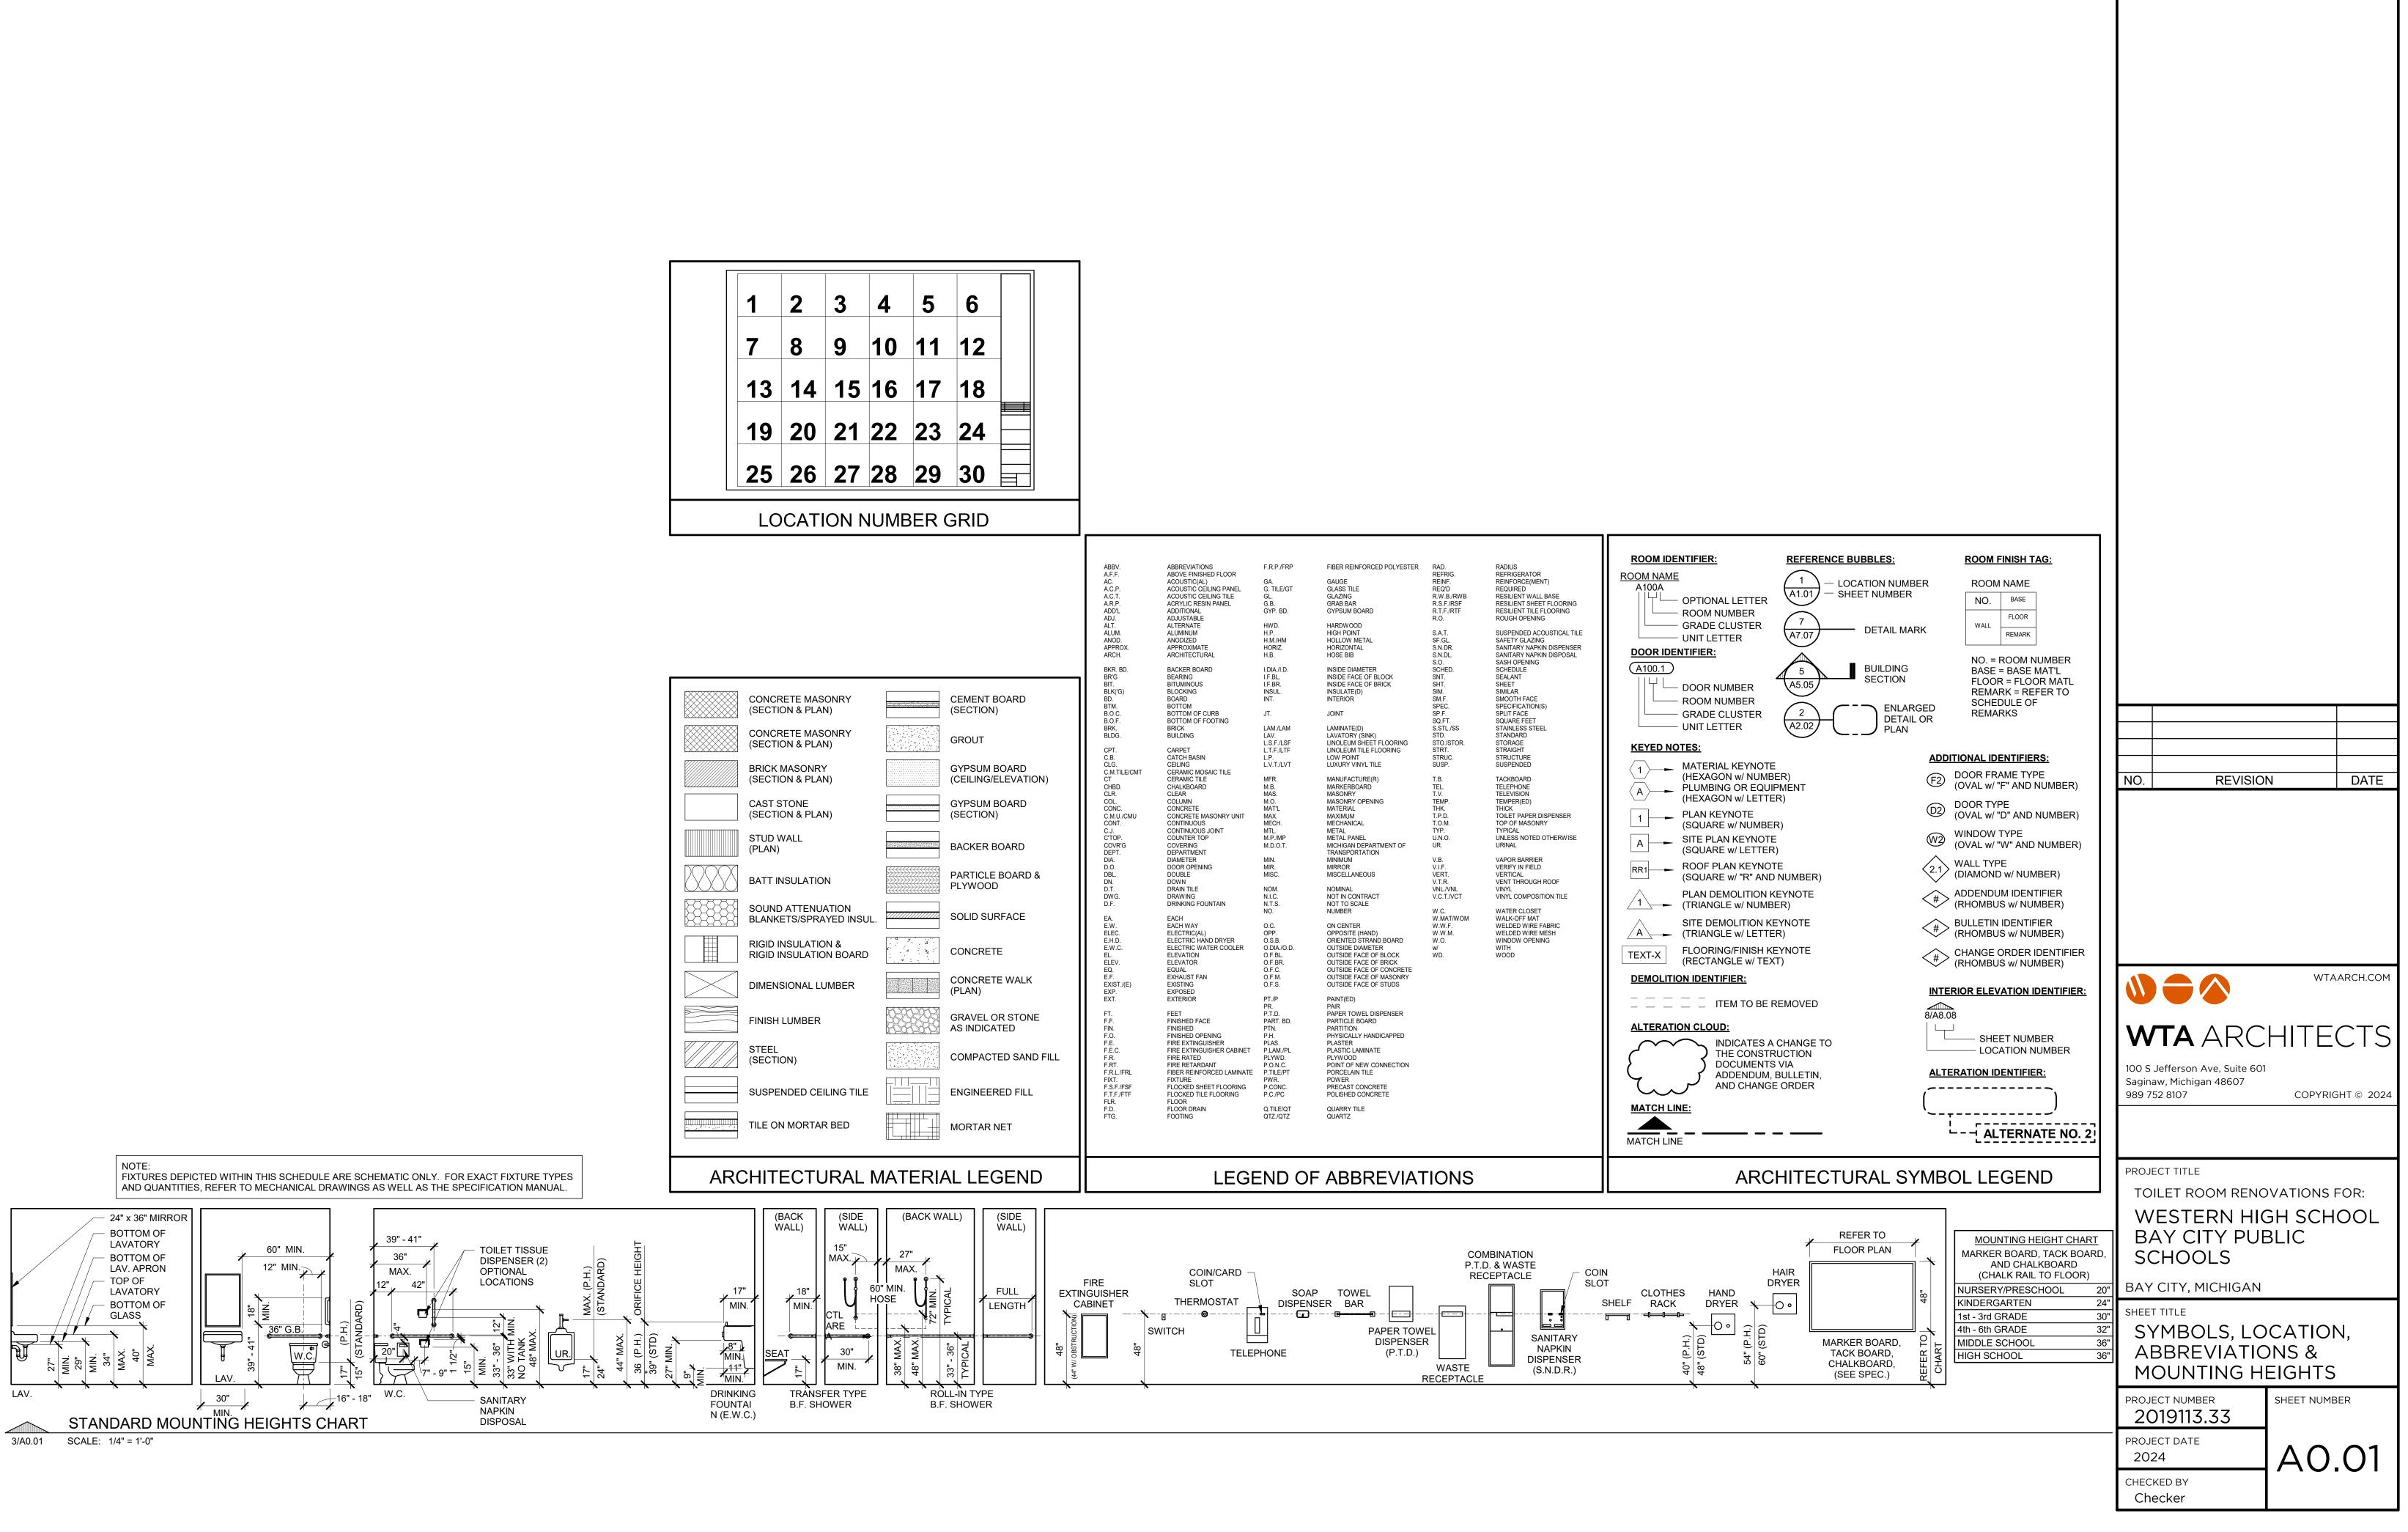- REFER TO MECHANICAL AND ELECTRICAL DRAWINGS FOR COMPLETE MEP SCOPE.
- PLAN DIMENSIONS DO NOT INCLUDE WALL THICKNESS.
- 3. ALL AREAS DAMAGED BY DEMOLITION WORK ARE TO BE PATCHED AND REPAIRED OR REPLACED TO MATCH ADJACENT SURFACES.
- 4. PATCH AND REPAIR REMAINING WALLS; AT ARCHITECTURAL, MECHANICAL, AND ELECTRICAL DEMOLITION POINTS WITH SIMILAR MATERIALS IN SIZE, COLOR AND TEXTURE.
- 5. PATCH AND REPAIR ALL EXPOSED ANCHOR HOLES AT WALLS, USING EPOXY AT GLAZED CMU AND GROUT AT PAINTED CMU.
- REFER TO FINISH MATERIAL LEGEND FOR SPECIFIC MANUFACTURER AND COLOR.
- REFER TO SPECIFICATIONS FOR COMPLETE FINISH INFORMATION.
- REFER TO REFLECTED CEILING PLANS FOR CEILING TYPES, HEIGHTS AND FINISH INFORMATION
- 9. ALL WALL MOUNTED MECHANICAL EQUIPMENT (DIFFUSERS, GRILLES, ETC) AND ELECTRICAL EQUIPMENT (PANELS, ETC) SHALL BE PAINTED TO MATCH THE ADJACENT WALL COLOR. REFER TO MECHANICAL AND ELECTRICAL DRAWINGS FOR QUANTITIES AND LOCATIONS.
- 10. WHERE REMOVAL OR MODIFICATION TO A FINISH MATERIAL IS SHOWN, BUT NEW FINISHES ARE NOT SCHEDULED, PATCH AND REPAIR TO MATCH EXISTING FINISH CONDITION AS REQUIRED.
- 11. ALL EXISTING PLUMBING FIXTURES TO BE TIGHTENED, AS NEEDED. REF. MECHANICAL.
- 12. APPLY NEW SEALANT AROUND ALL EXISTING PLUMBING FIXTURES.
- 13. ALL EXISTING PLUMBING FIXTURES TO REMAIN, UNLESS OTHERWISE NOTED.
- 14. POWERWASH ALL EXISTING TILE FLOORING.

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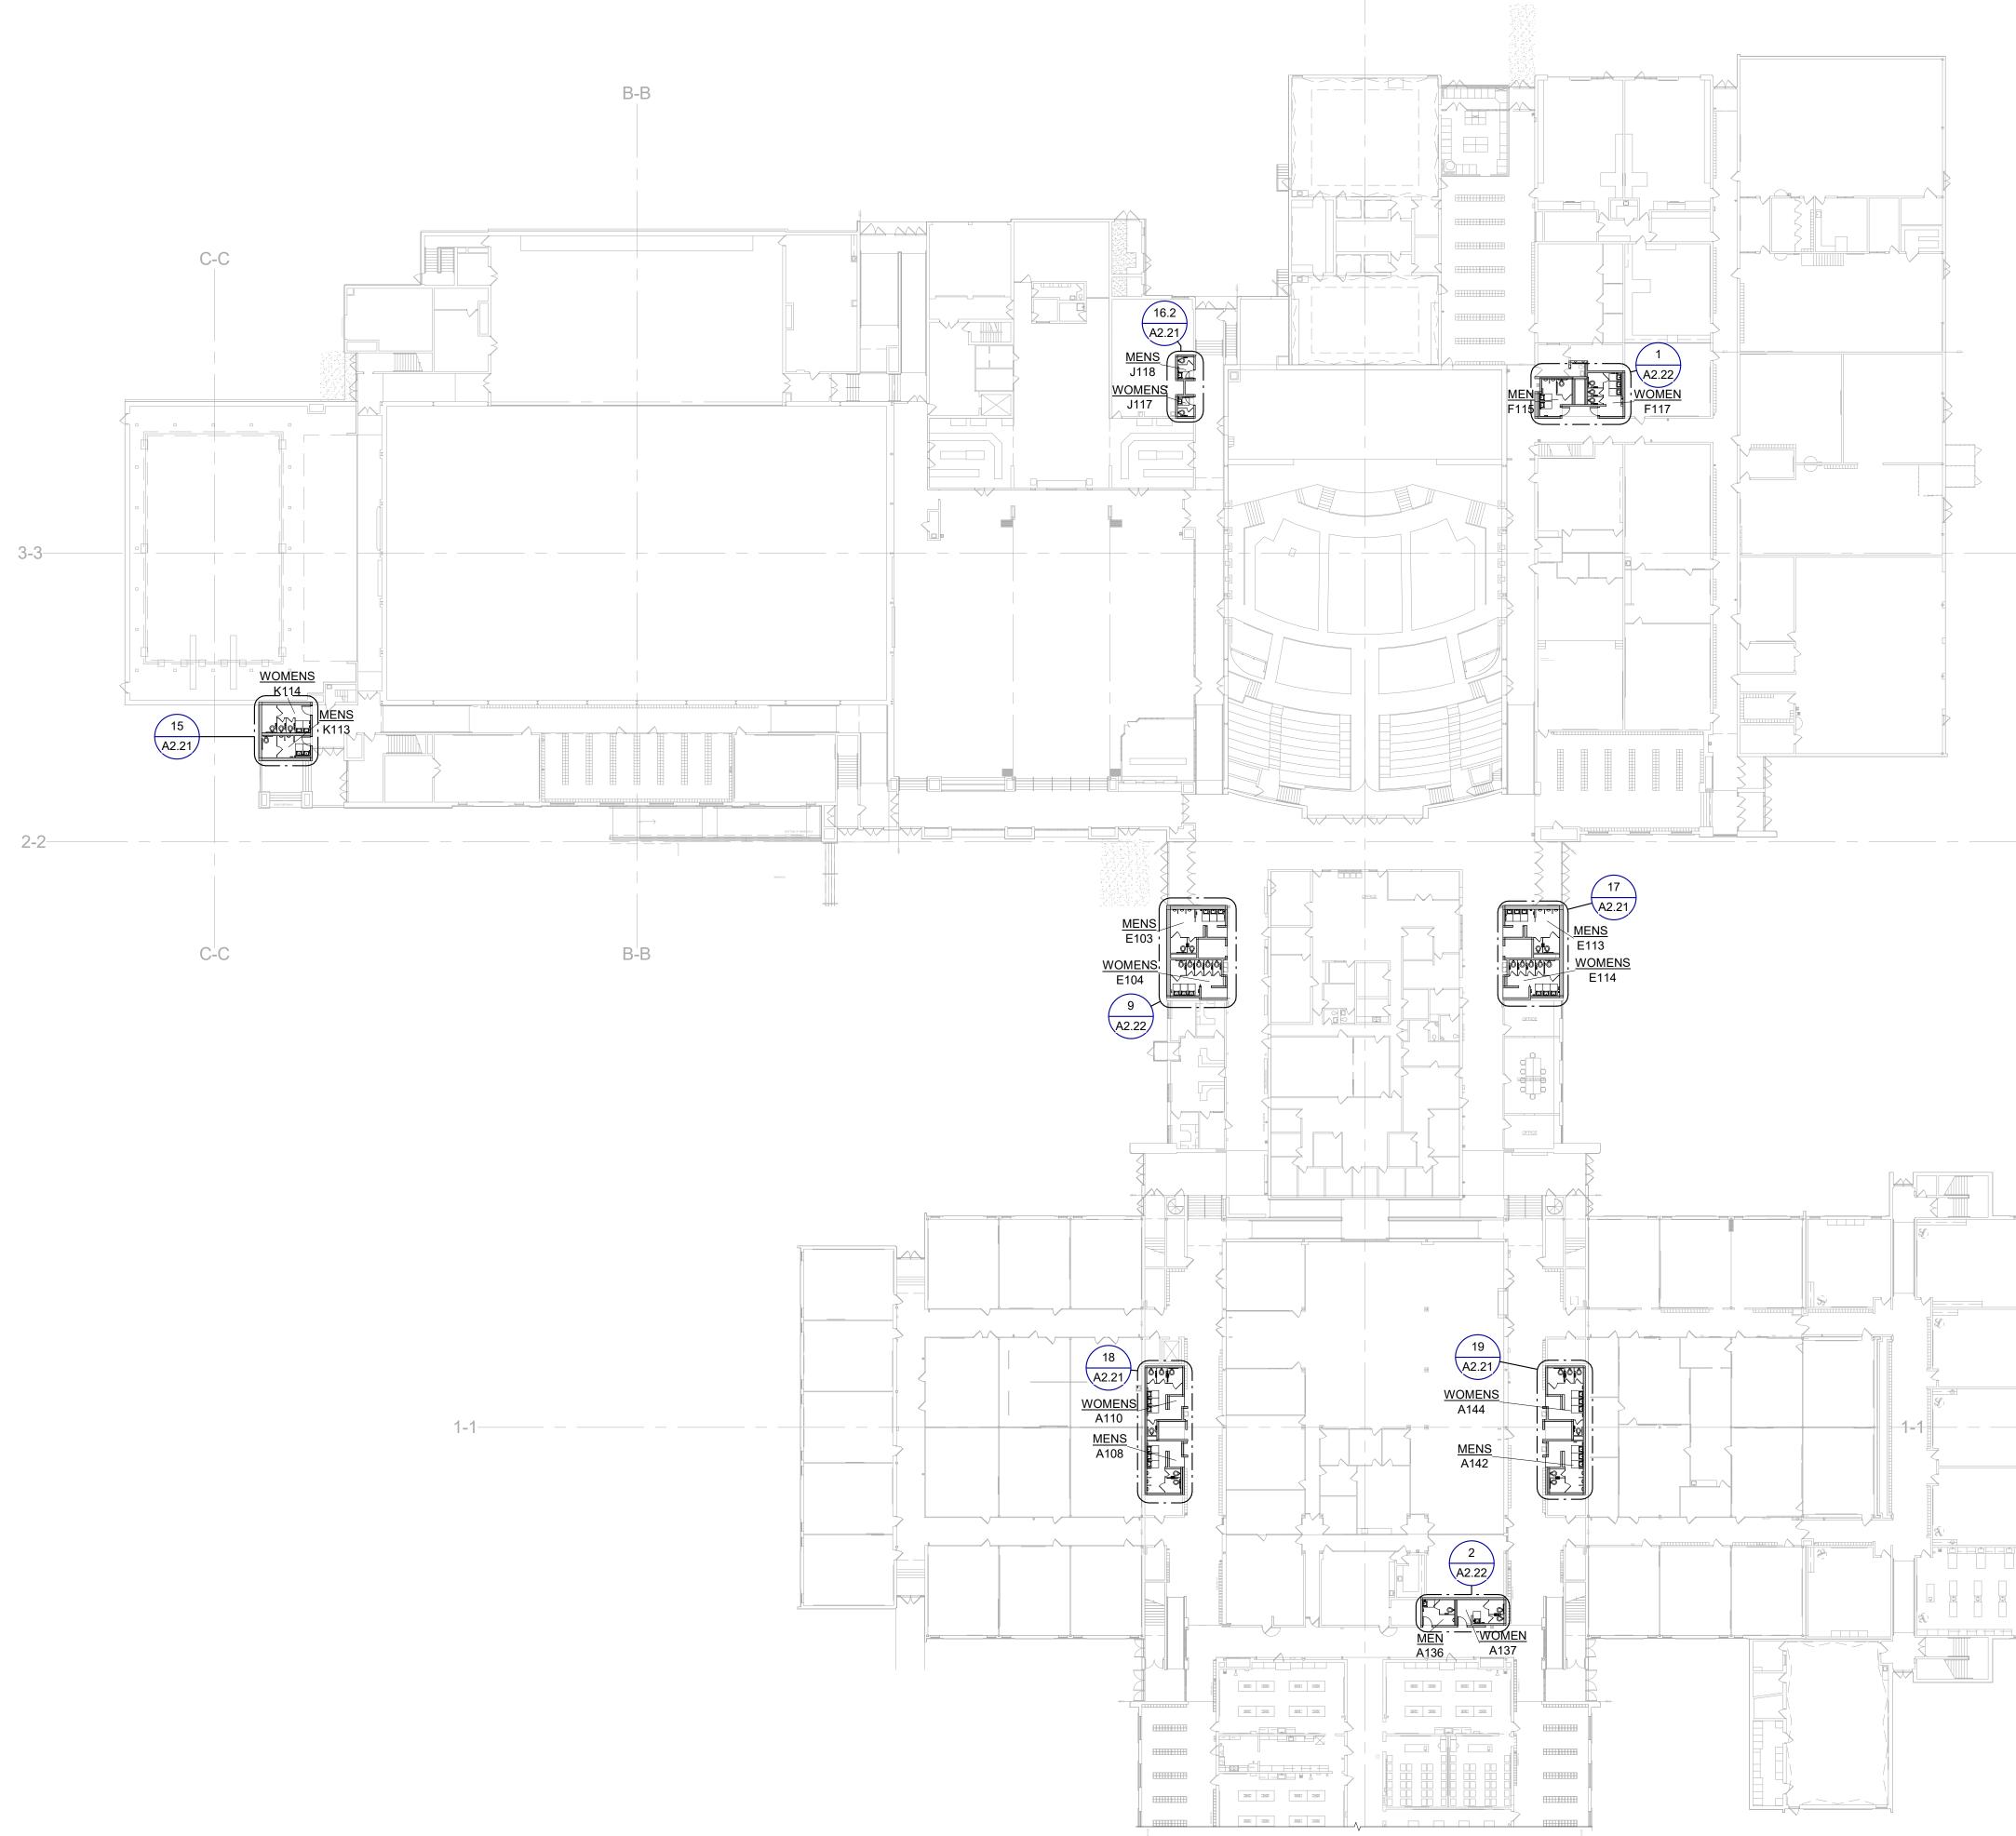
PROJECT TITLE TOILET ROOM RENOVATIONS FOR:

WESTERN HIGH SCHOOL BAY CITY PUBLIC SCHOOLS

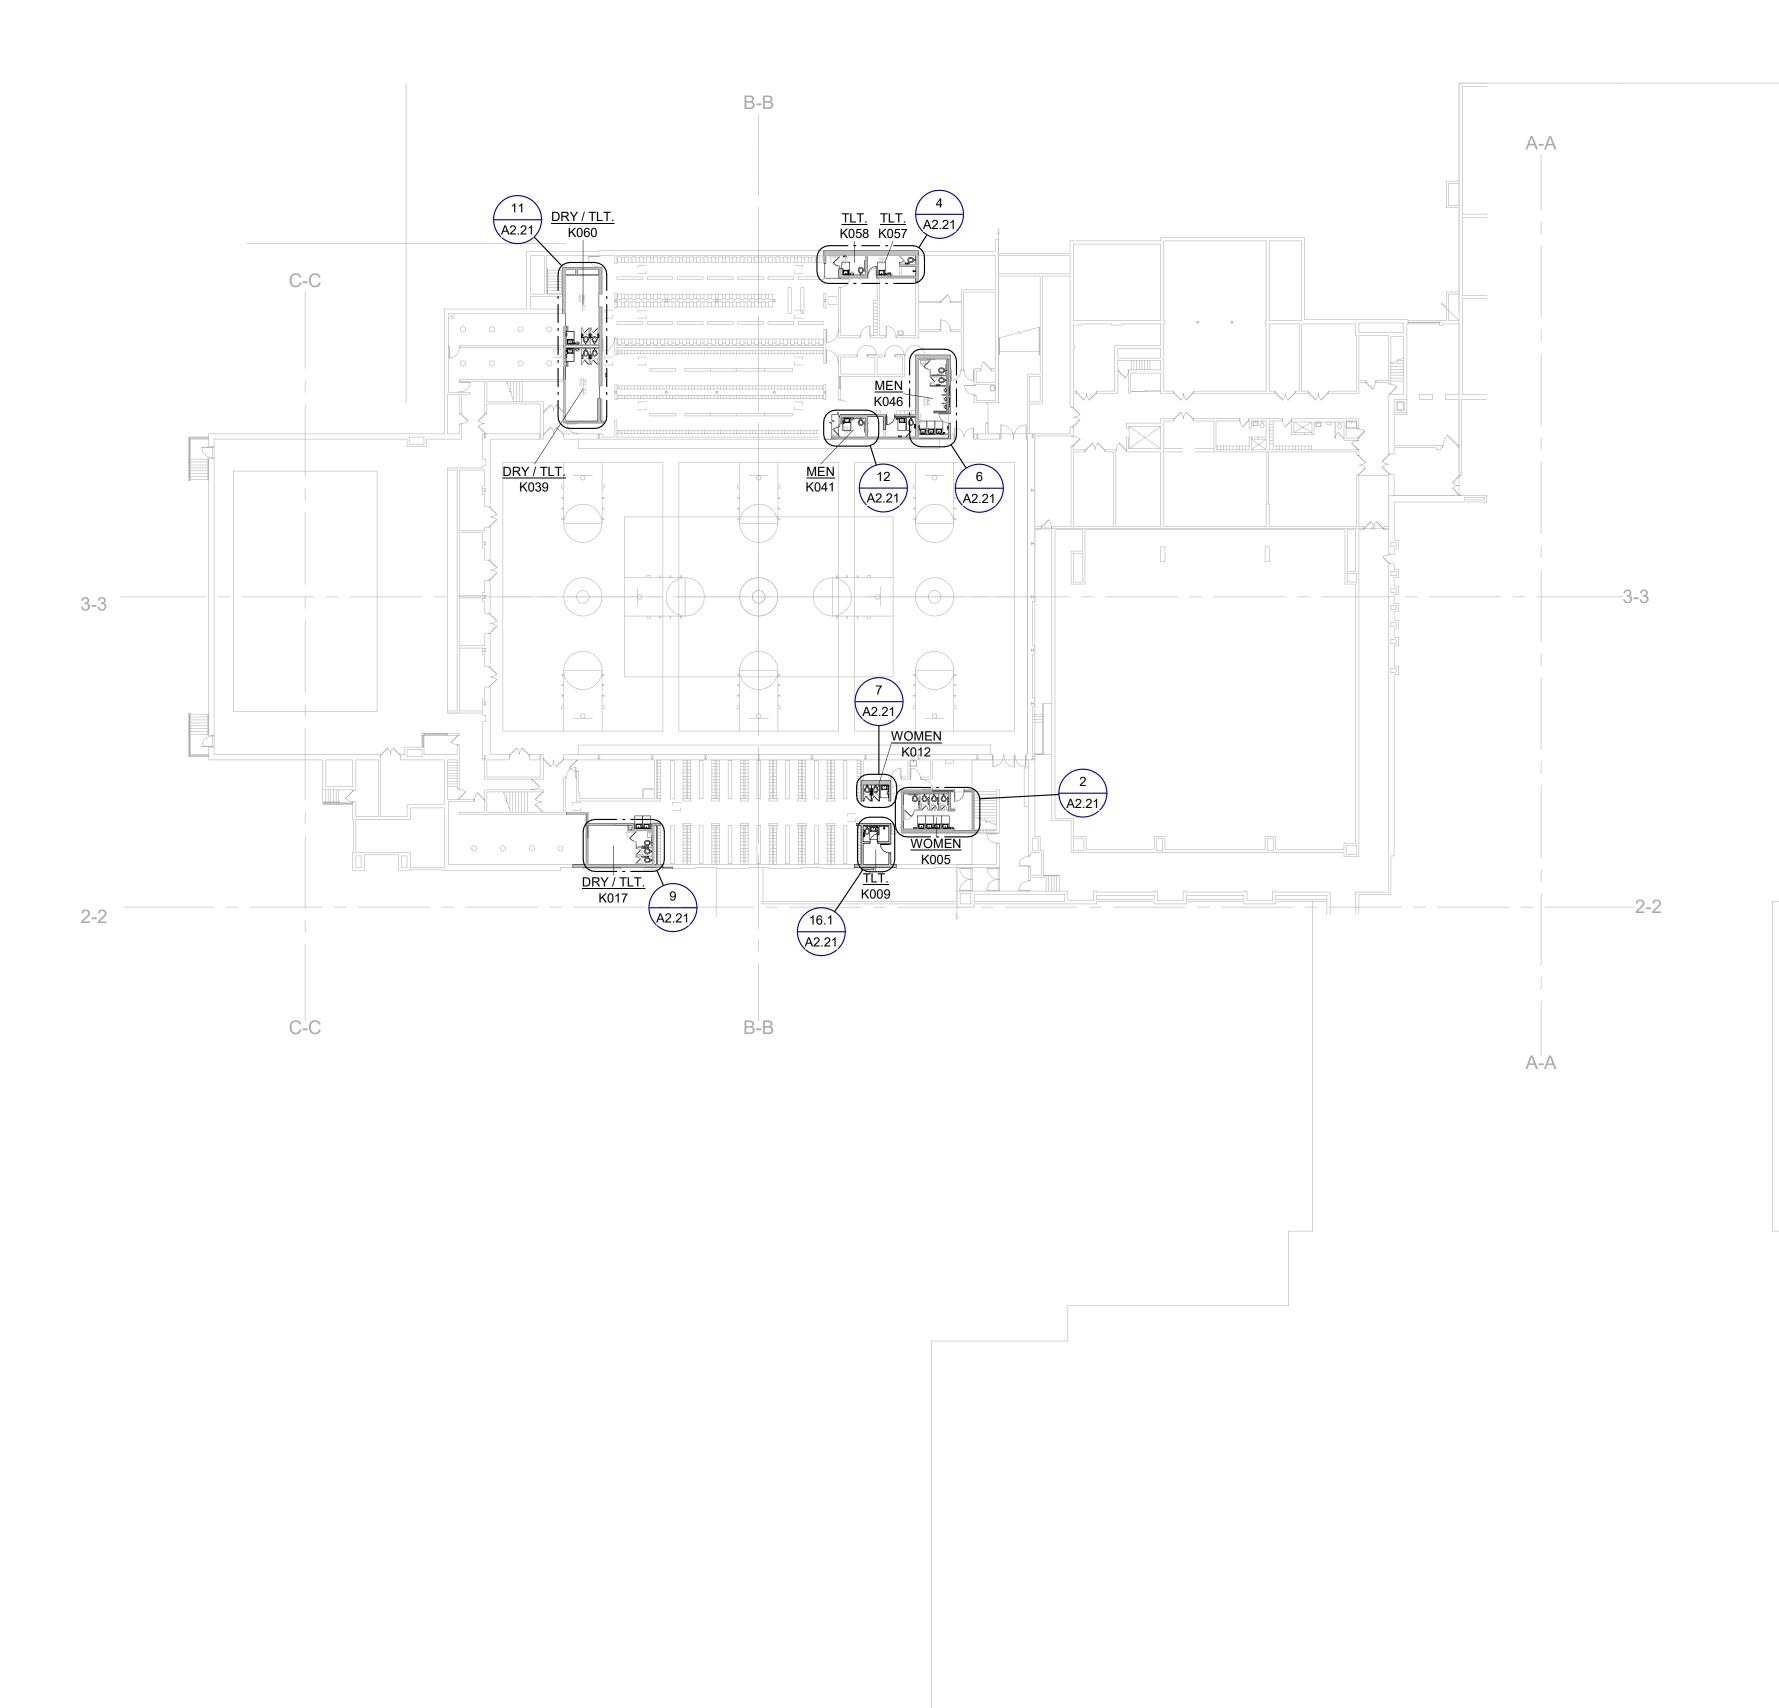BAY CITY, MICHIGAN

SHEET TITLE	
LOWER LEVEL PLAN	MASTER


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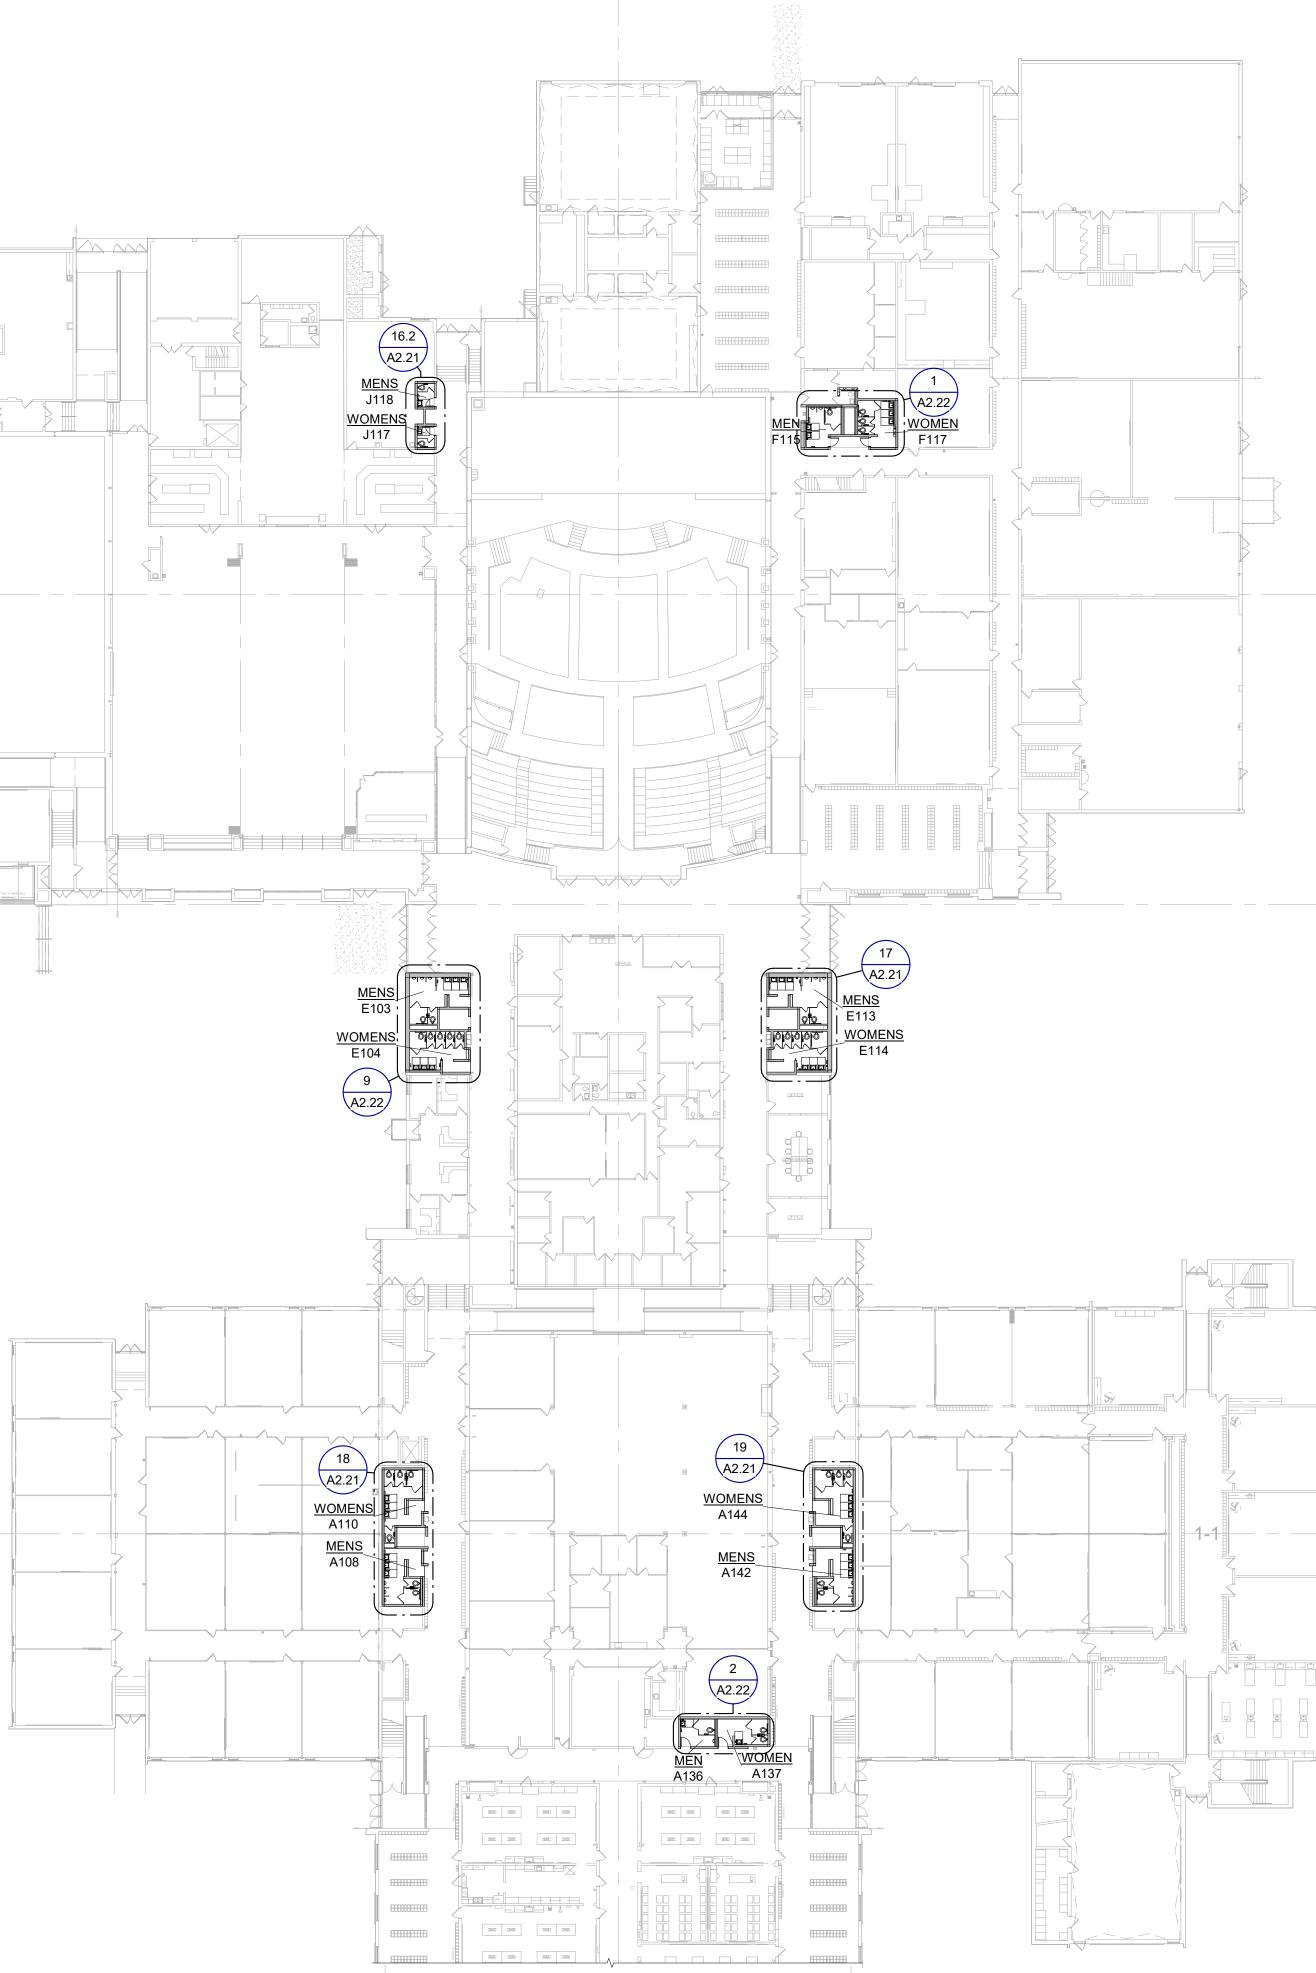










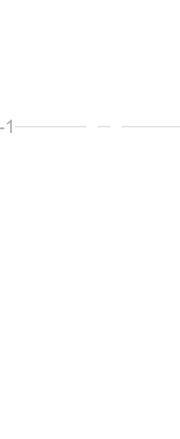




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NORTH SECOND FLOOR MASTER PLAN SCALE: 1" = 30'-0"

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SCALE: 1/4" = 1'-0"


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- 5 REMOVE EXISTING PLUMBING FIXTURE, REF.
- 7 EXISTING FLUSH VALVE TO BE REMOVED AND
- 8 EXISTING LAVATORY TO REMAIN. EXISTING THERMOSTATIC MIXING VALVE, FAUCET, GRID STRAINER, TAILPIECE, P-TRAP, AND ANGLE VALVE TO BE REMOVED AND REPLACED. REPLACE PIPING AND FITTINGS TO BE ABLE TO REPLACE
- 10 REMOVE AND DISPOSE OF EXISTING SINK, REF.
- 12 REMOVE EXISTING PAPER TOWEL DISPENSER,
- 14 REMOVE EXISTING SANITARY NAPKIN DISPOSAL.

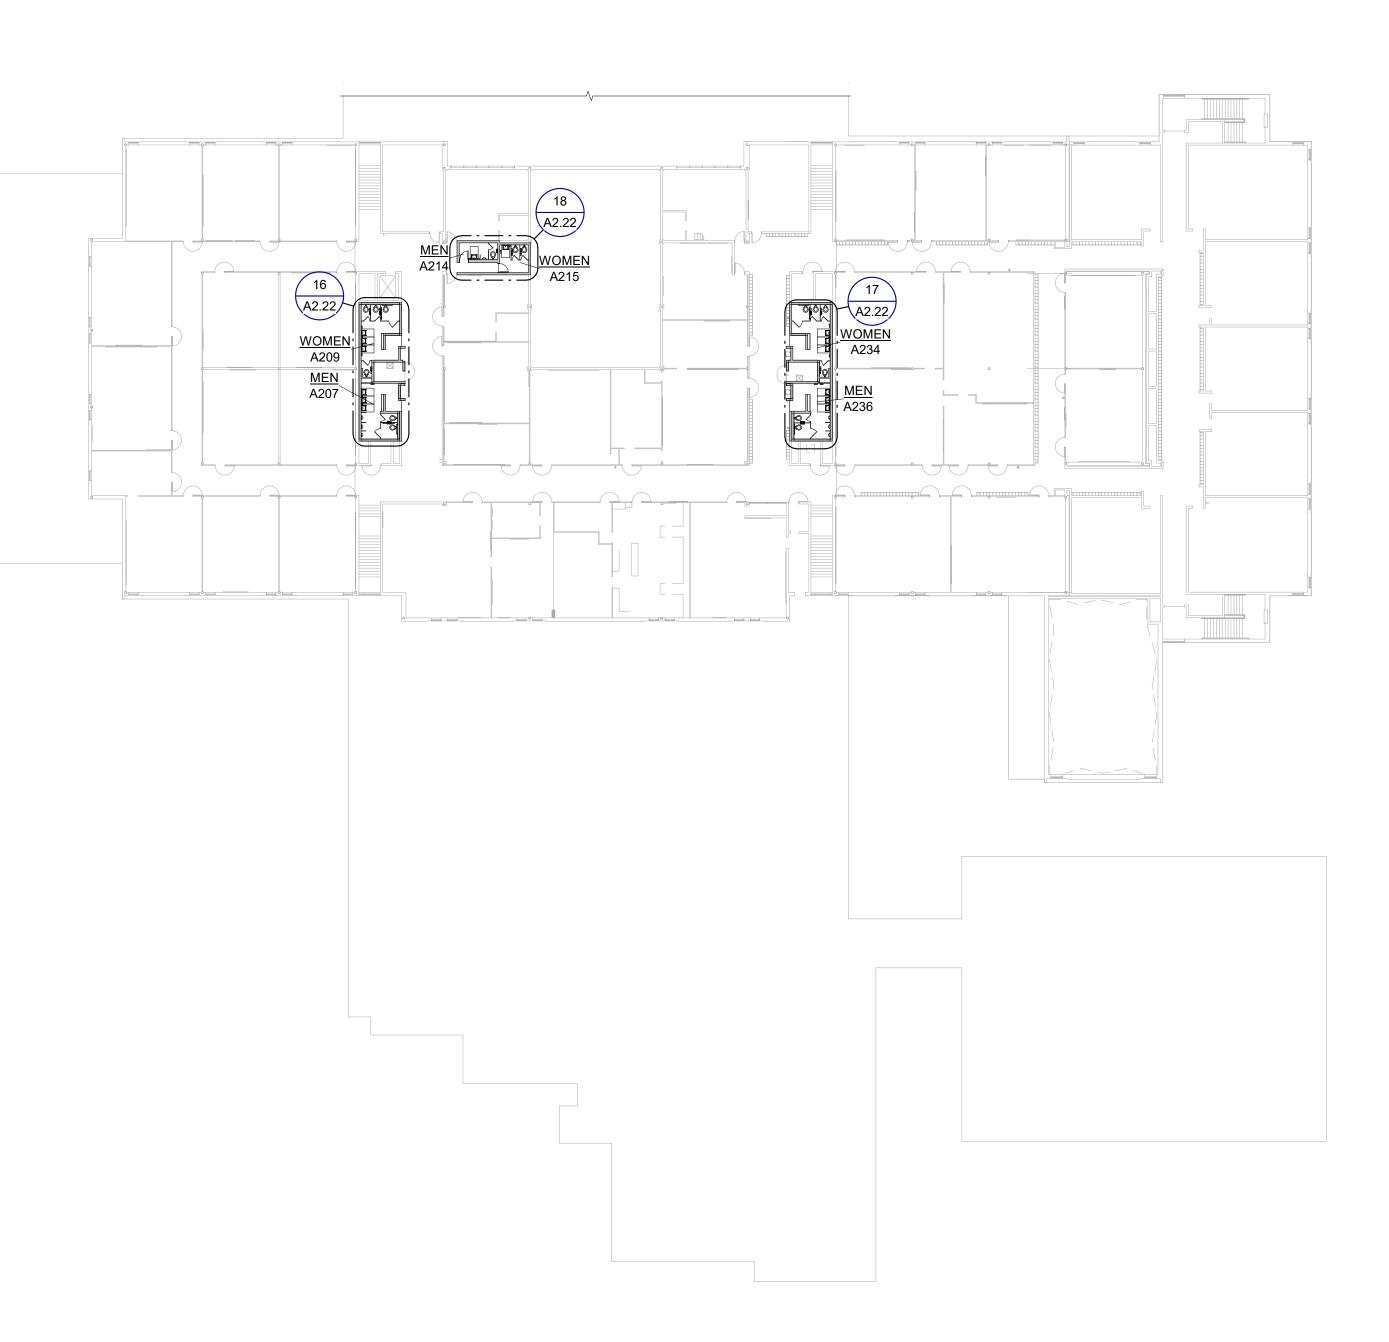
### PLAN GENERAL NOTES:


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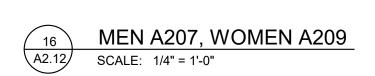
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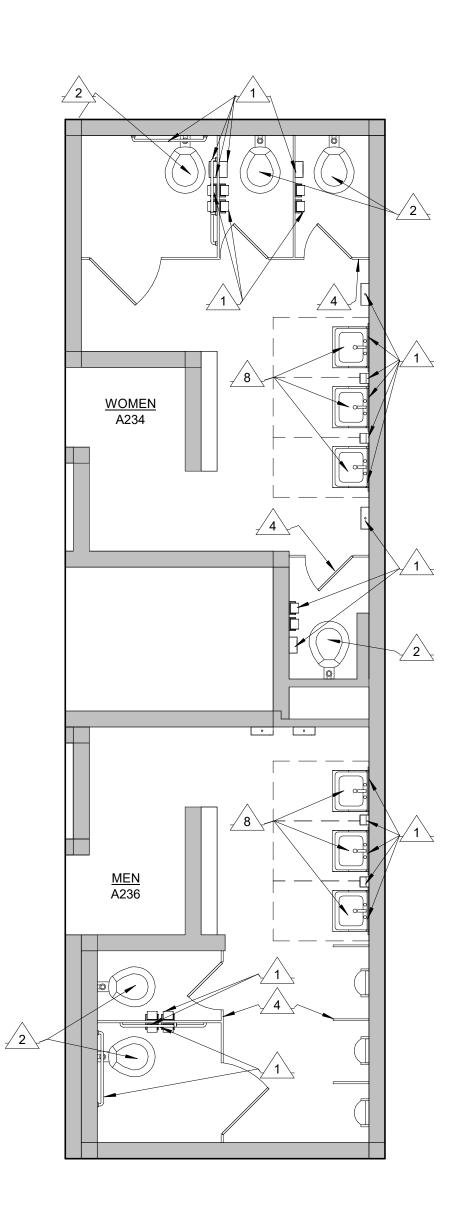
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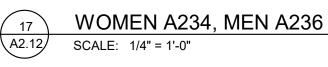






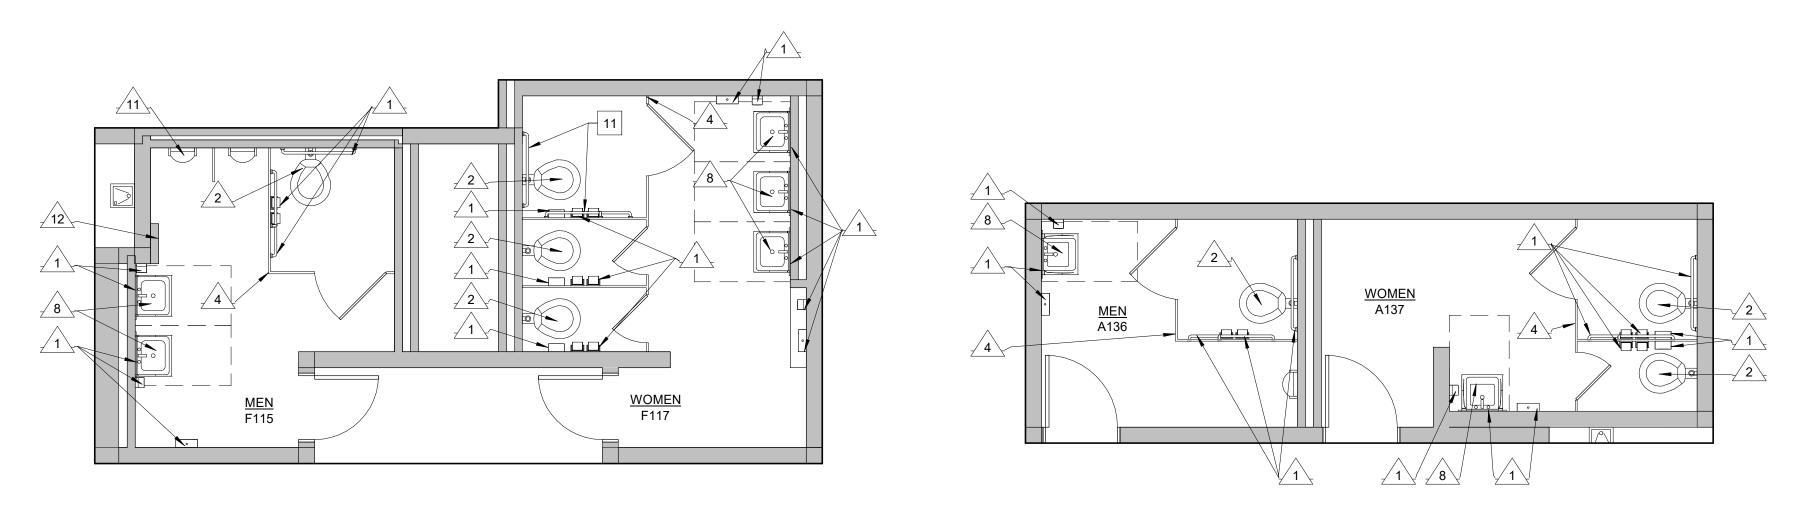


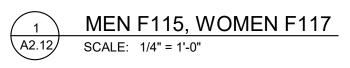

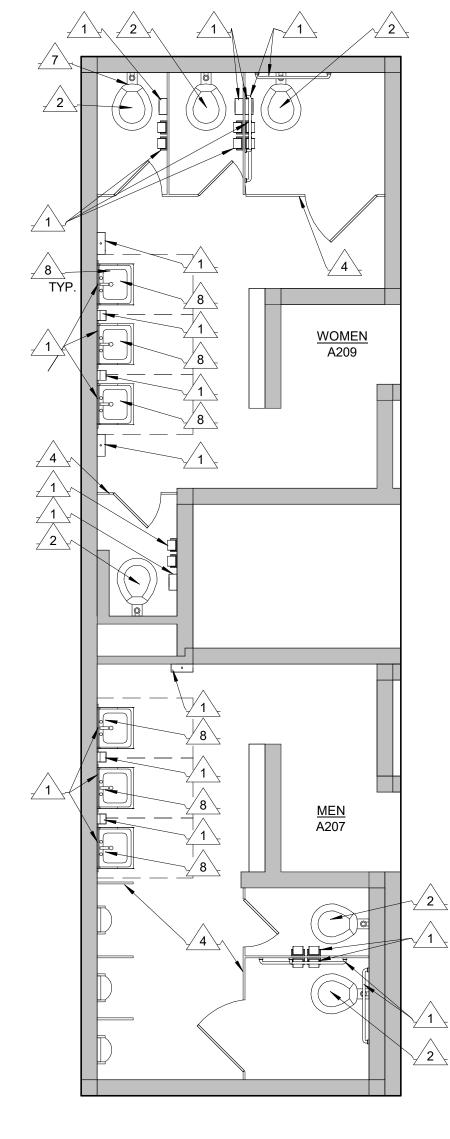


MEN A136, WOMEN A137 SCALE: 1/4" = 1'-0"

 $\begin{pmatrix} 2 \\ A2.12 \end{pmatrix}$ 

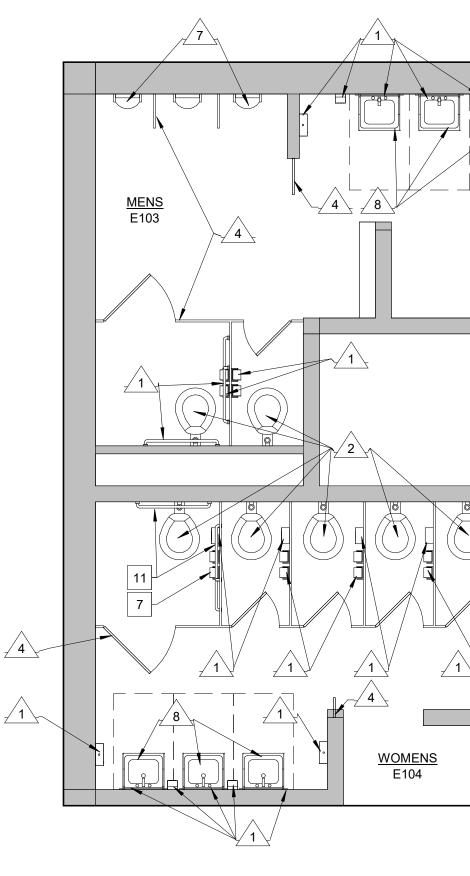



MEN E103, WOMEN E104 SCALE: 1/4" = 1'-0"

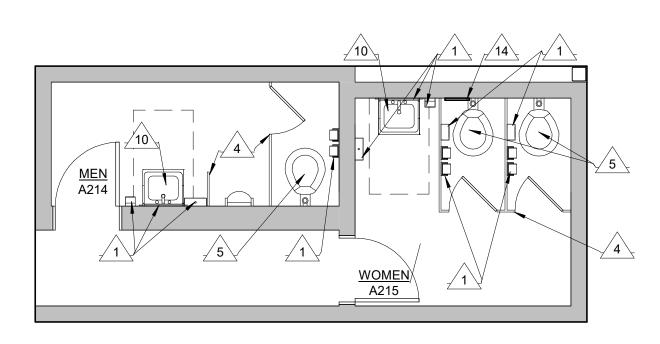

MEN A214, WOMEN A215 (18) (A2.12) SCALE: 1/4" = 1'-0"

### DEMOLITION KEYNOTES

- 1 REMOVE AND PROTECT EXISTING PLUMBING ACCESSORIES AND SAVE FOR REINSTALLATION. 2 FLOOR MOUNTED WATER CLOSET TO REMAIN. REMOVE AND DISPOSE OF EXISTING WATER CLOSET SEAT. TIGHTEN ANY LOOSE FIXTURES.
- 4 REMOVE EXISTING PARTITION. 5 REMOVE EXISTING PLUMBING FIXTURE, REF.
- MECHANICAL. 7 EXISTING FLUSH VALVE TO BE REMOVED AND
- DISPOSED OF, REF. MECHANICAL.
- 8 EXISTING LAVATORY TO REMAIN. EXISTING FAUCET, PIPE PROTECTIVE COVERS, THERMOSTATIC MIXING VALVE, FAUCET, GRID STRAINER, TAILPIECE, P-TRAP, AND ANGLE VALVE TO BE REMOVED AND REPLACED. REPLACE PIPING AND FITTINGS TO BE ABLE TO REPLACE EXISTING LAVATORY TRIM, REF. MECHANICAL.
- 10 REMOVE AND DISPOSE OF EXISTING SINK, REF. MECHANICAL.
- 11 URINAL IS MISSING, PREP. EXISTING CONDITIONS TO INSTALL NEW URINAL. 12 REMOVE EXISTING PAPER TOWEL DISPENSER,
- PROVIDED BLOCKING FOR NEW PAPER TOWEL DISPENSER.
- 13 REMOVE EXISTING METAL ACCESS PANEL. 14 REMOVE EXISTING SANITARY NAPKIN DISPOSAL.

#### PLAN GENERAL NOTES:

- REFER TO MECHANICAL AND ELECTRICAL DRAWINGS FOR COMPLETE MEP SCOPE.
- PLAN DIMENSIONS DO NOT INCLUDE WALL THICKNESS.
- ALL AREAS DAMAGED BY DEMOLITION WORK ARE TO BE PATCHED AND REPAIRED OR REPLACED TO MATCH ADJACENT SURFACES.
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- 14. POWERWASH ALL EXISTING TILE FLOORING.

NO.	REVISION	DATE



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PROJECT TITLE

TOILET ROOM RENOVATIONS FOR: WESTERN HIGH SCHOOL BAY CITY PUBLIC SCHOOLS


BAY CITY, MICHIGAN


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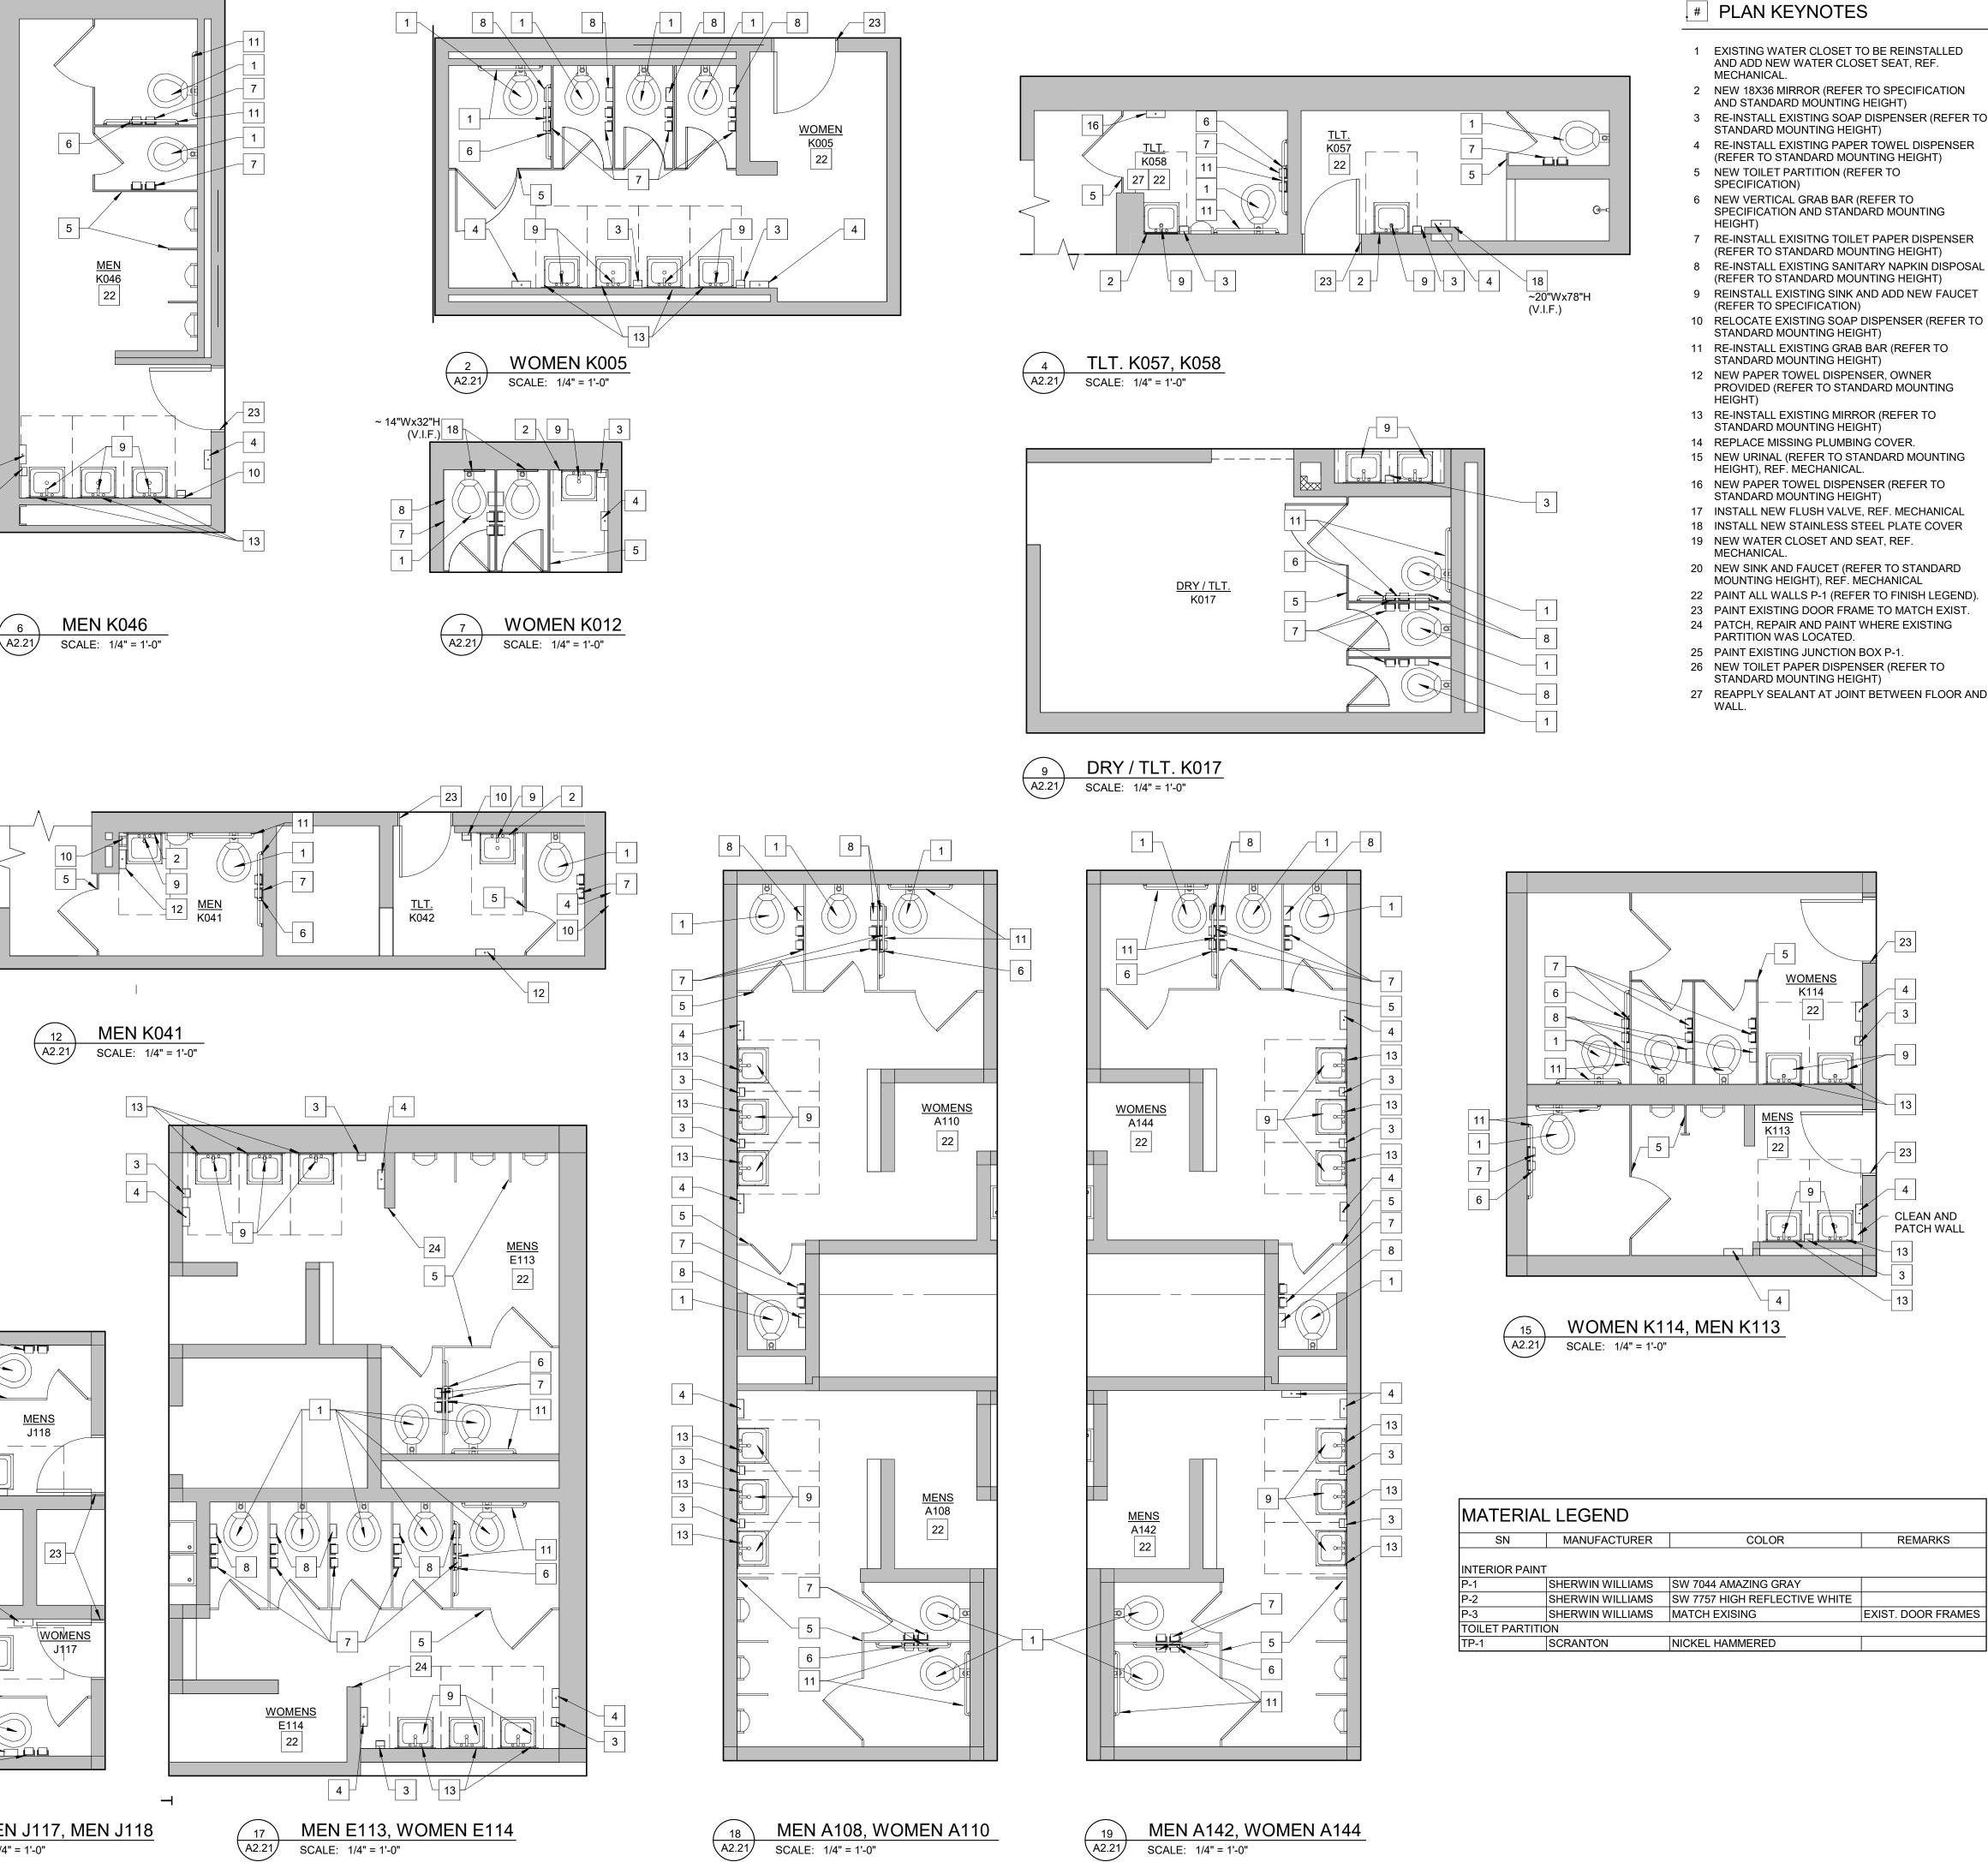
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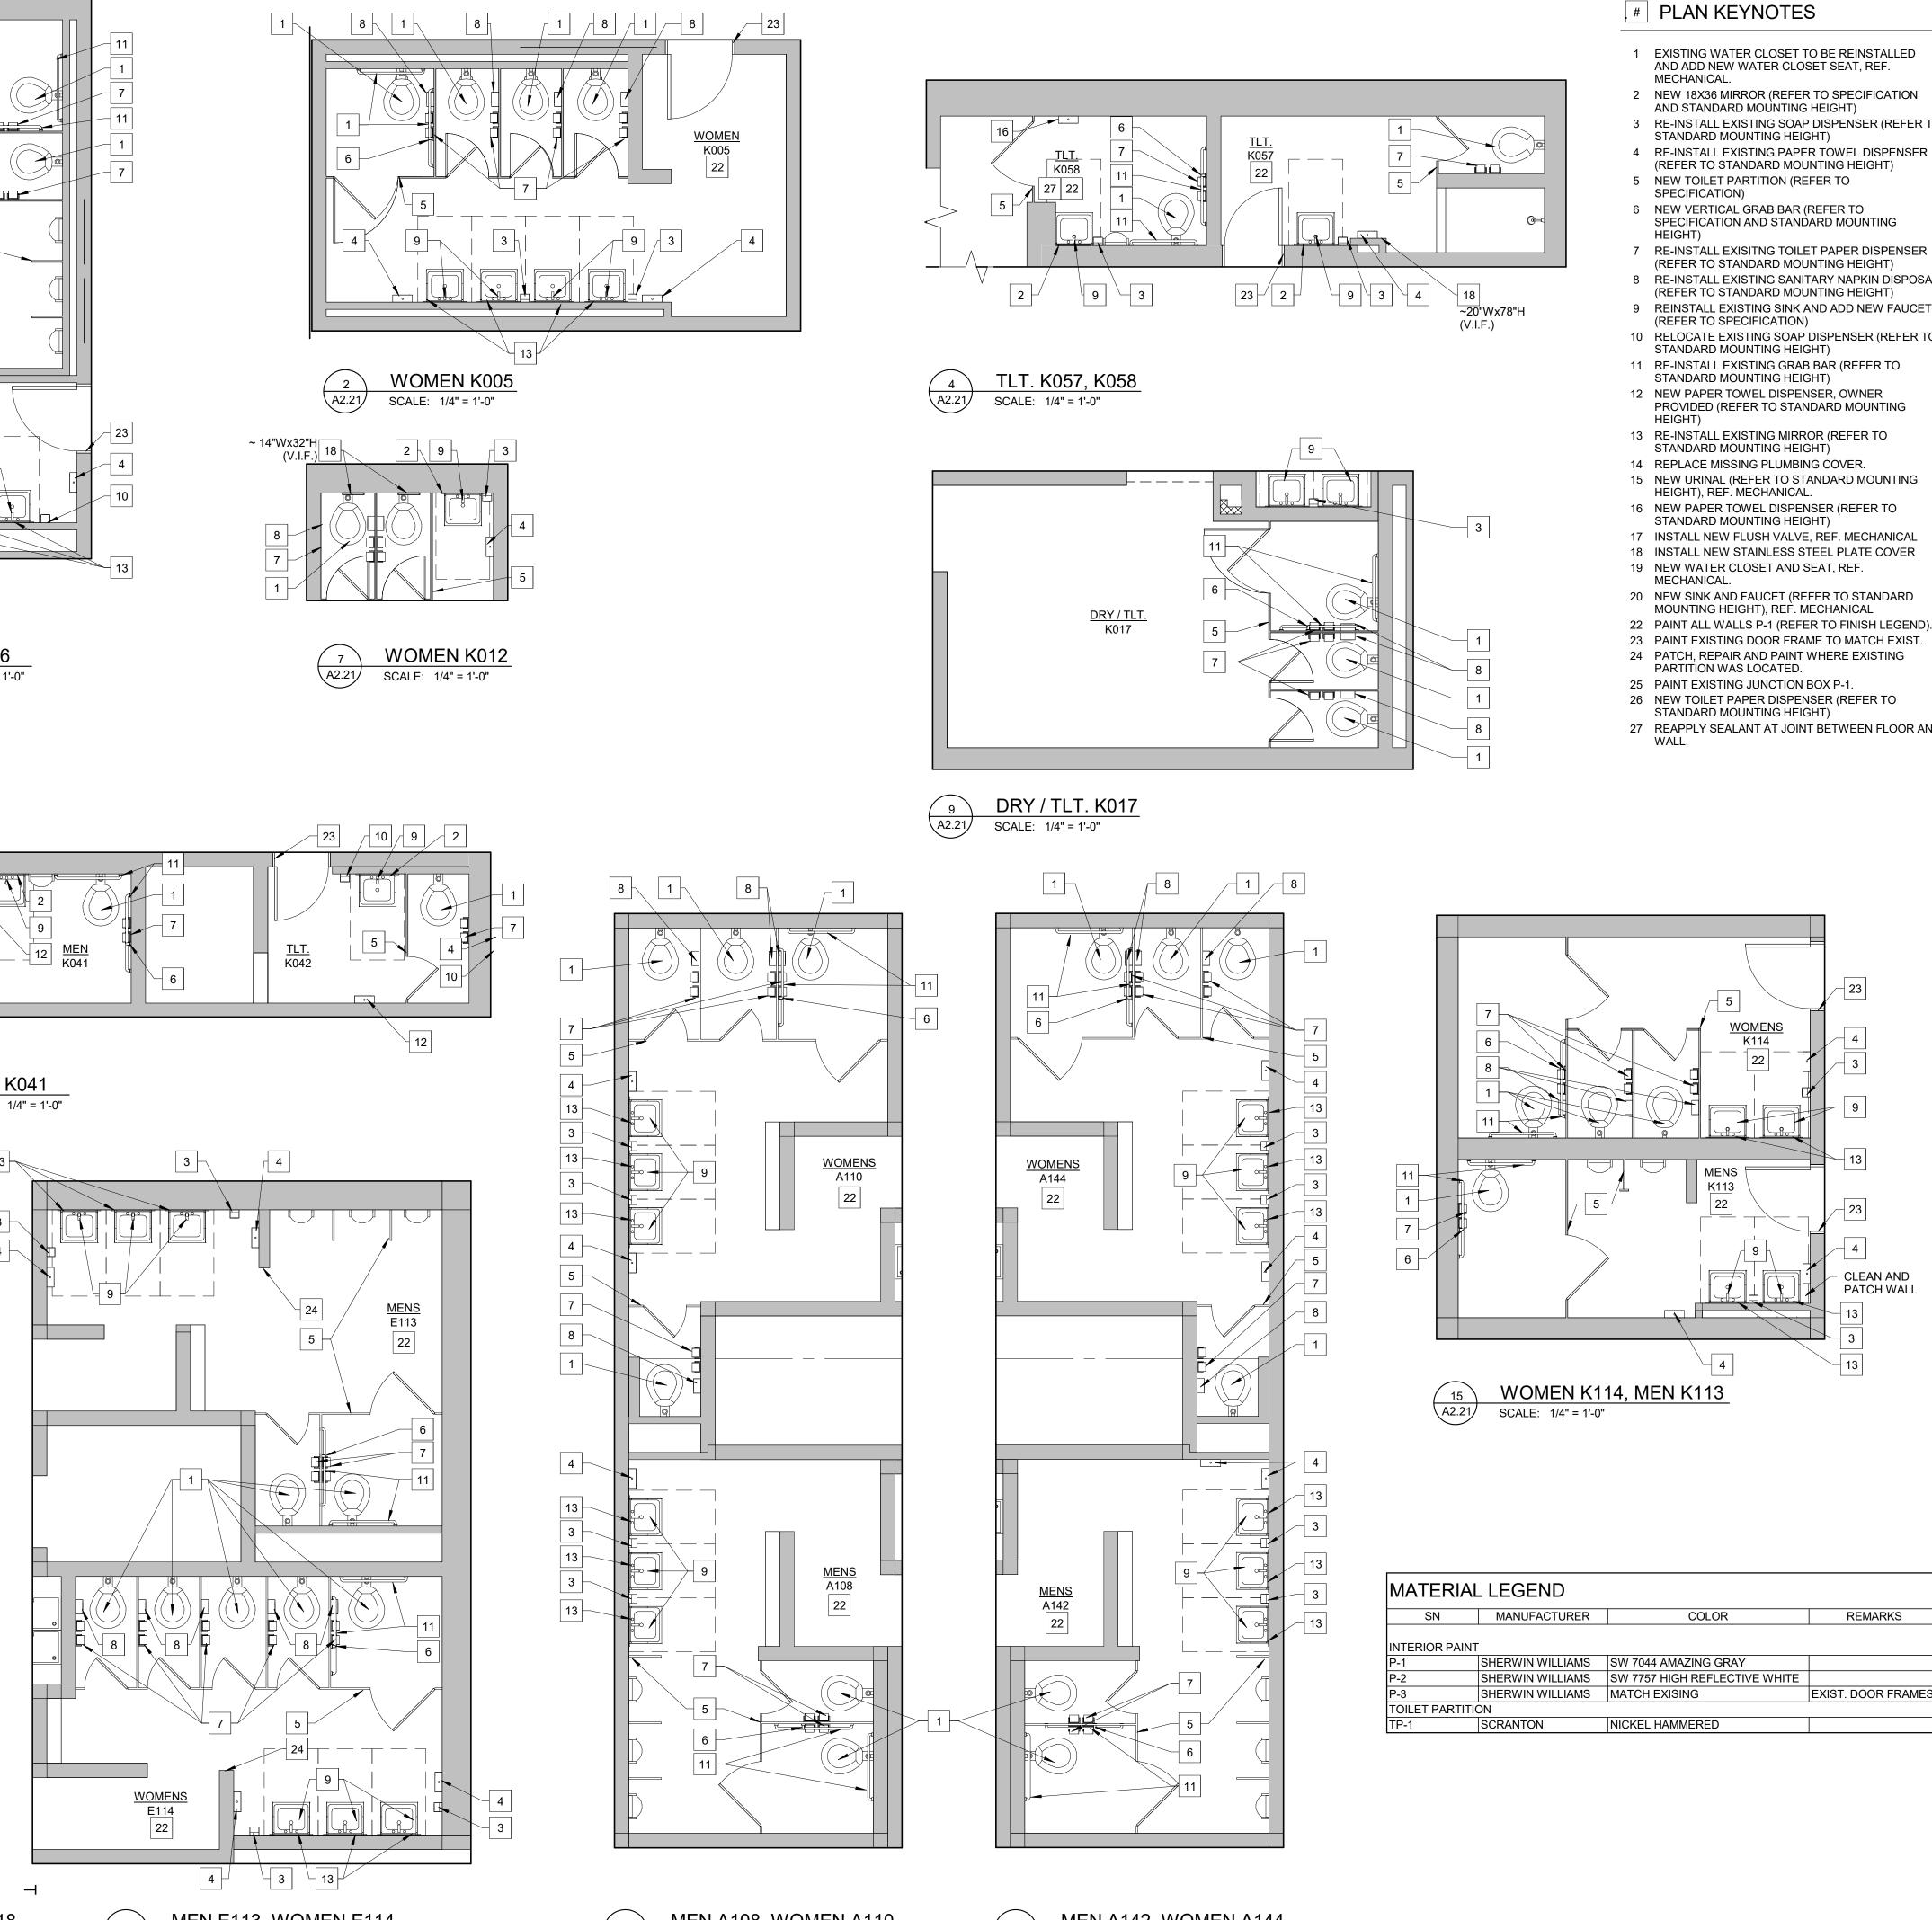
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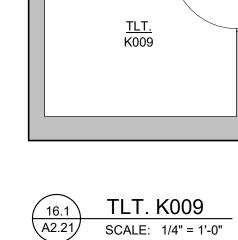








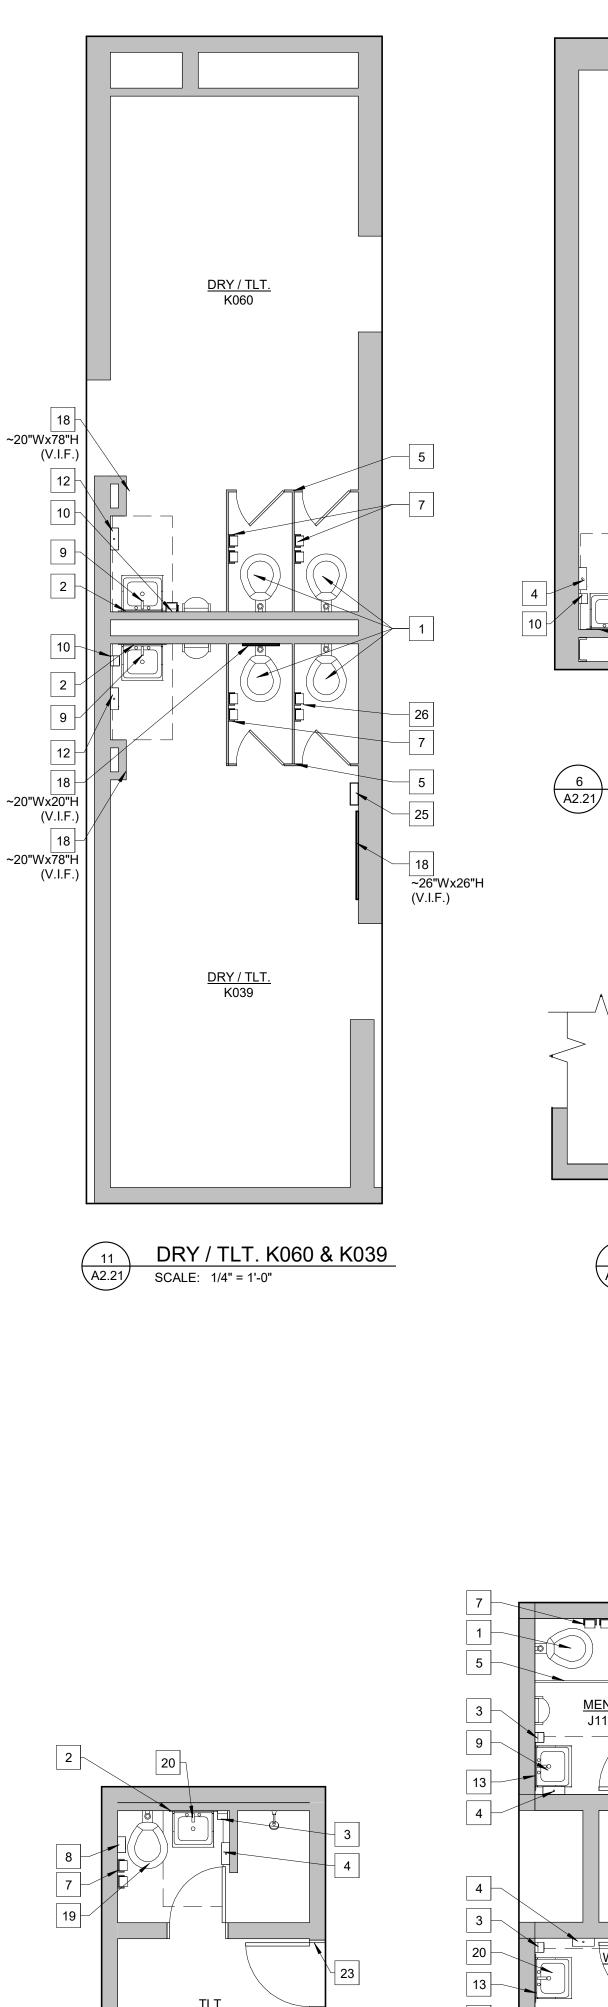

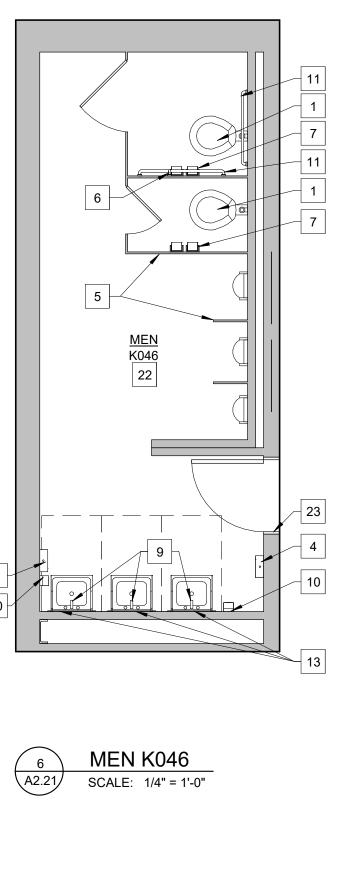



WOMEN J117, MEN J118 SCALE: 1/4" = 1'-0" (16.2) (A2.21)

SCALE: 1/4" = 1'-0"

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- 27 REAPPLY SEALANT AT JOINT BETWEEN FLOOR AND

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REVISION


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14. POWERWASH ALL EXISTING TILE FLOORING.

NO.

SN	MANUFACTURER	COLOR	REMARKS
NTERIOR PAINT			
-1	SHERWIN WILLIAMS	SW 7044 AMAZING GRAY	
-2	SHERWIN WILLIAMS	SW 7757 HIGH REFLECTIVE WHITE	
-3	SHERWIN WILLIAMS	MATCH EXISING	EXIST. DOOR FRAMES
OILET PARTITIO	ON		
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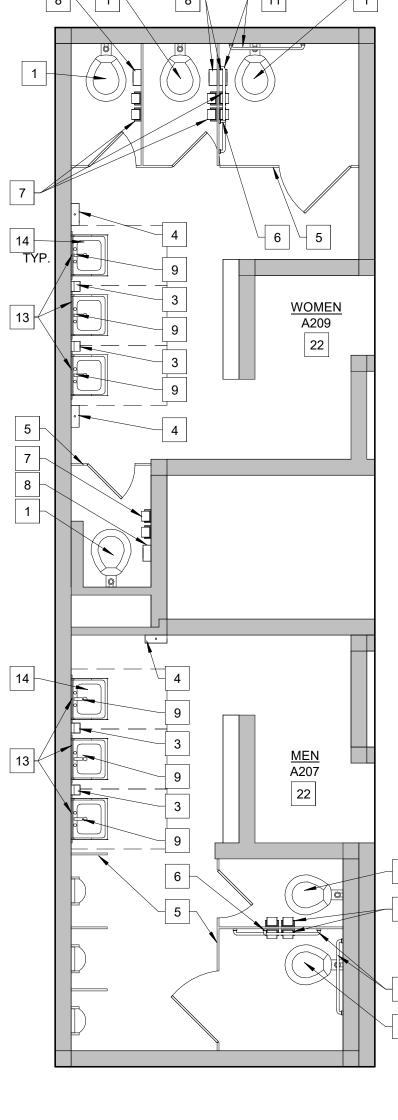



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6

WOMEN

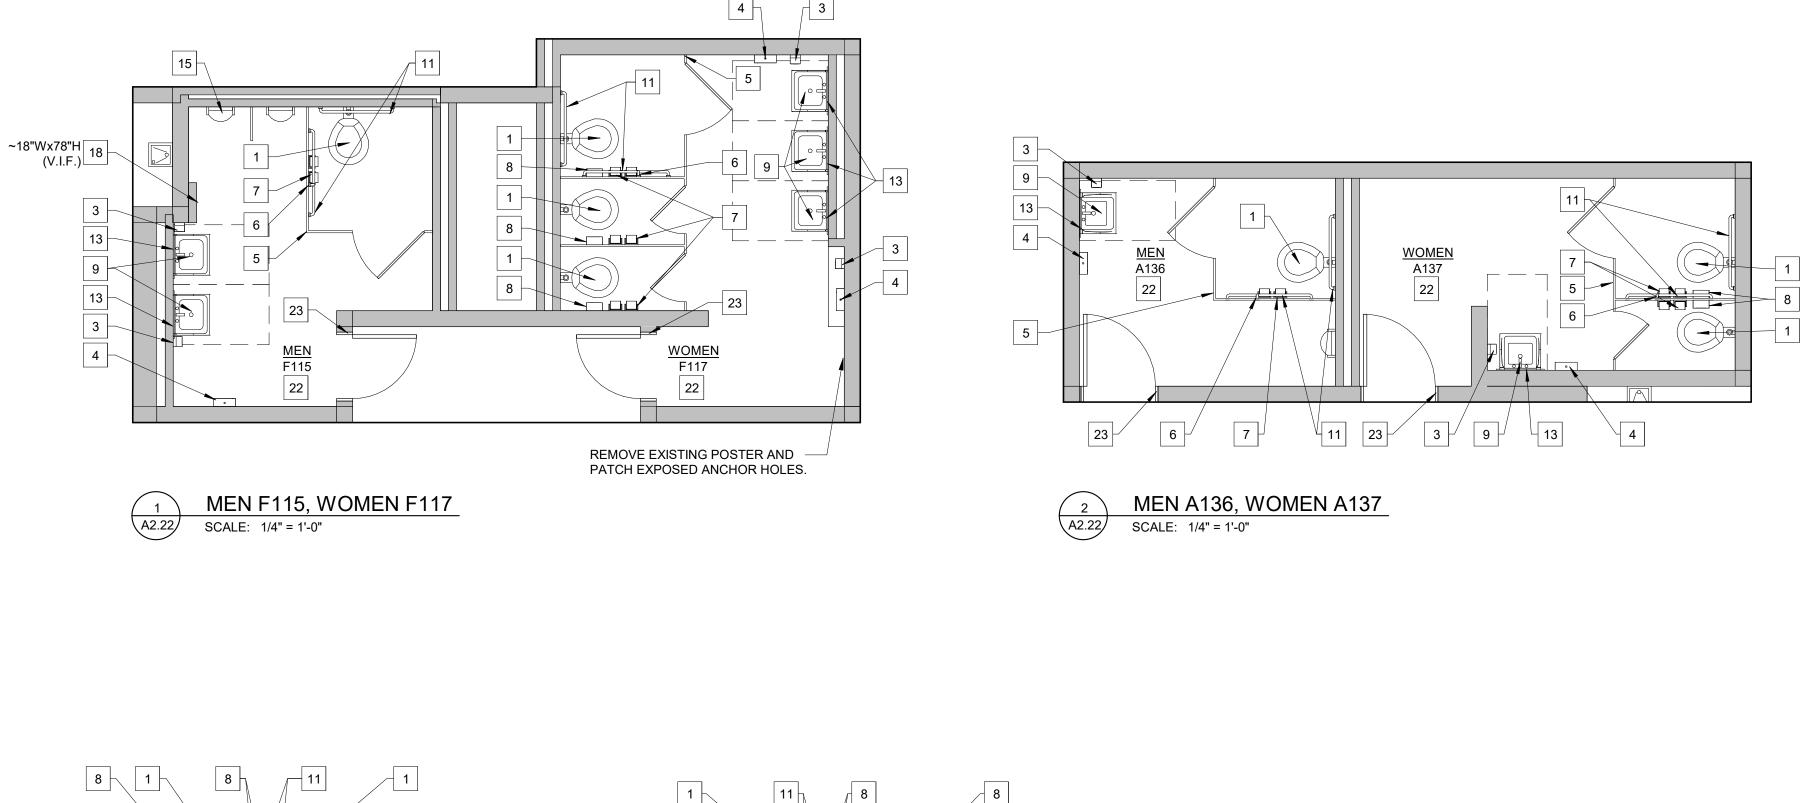A234


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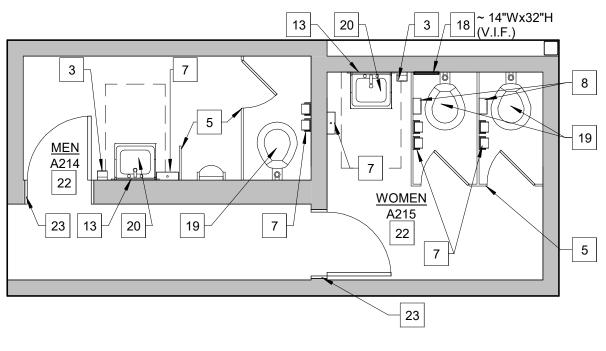
 16
 MEN A207, WOMEN A209

 A2.22
 SCALE: 1/4" = 1'-0"

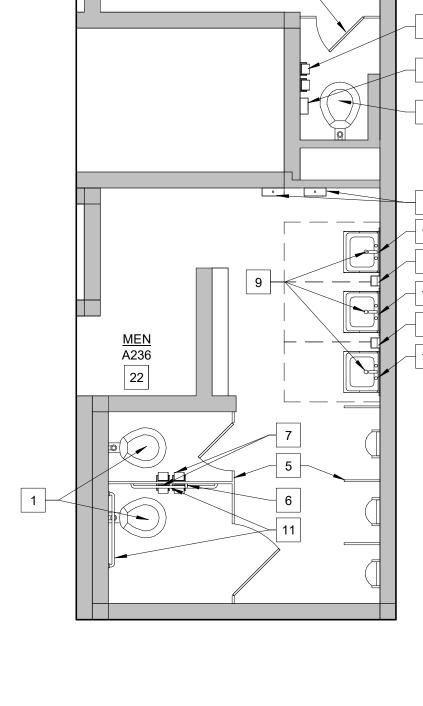 17
 WOMEN A234, MEN A236

 A2.22
 SCALE: 1/4" = 1'-0"



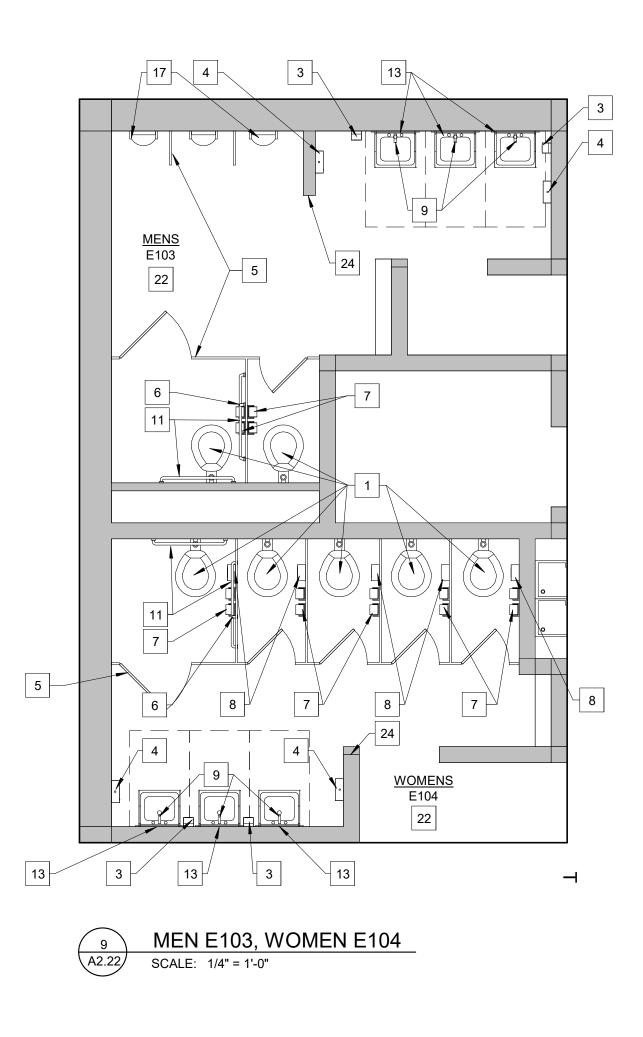

 18
 MEN A214, WOMEN A215

 A2.22
 SCALE: 1/4" = 1'-0"

#### # PLAN KEYNOTES

- 1 EXISTING WATER CLOSET TO BE REINSTALLED AND ADD NEW WATER CLOSET SEAT, REF. MECHANICAL.
- NEW 18X36 MIRROR (REFER TO SPECIFICATION AND STANDARD MOUNTING HEIGHT)
   RE-INSTALL EXISTING SOAP DISPENSER (REFER TO
- 4 RE-INSTALL EXISTING PAPER TOWEL DISPENSER
- (REFER TO STANDARD MOUNTING HEIGHT)5 NEW TOILET PARTITION (REFER TO
- SPECIFICATION)
- 6 NEW VERTICAL GRAB BAR (REFER TO SPECIFICATION AND STANDARD MOUNTING HEIGHT)
- 7 RE-INSTALL EXISITING TOILET PAPER DISPENSER (REFER TO STANDARD MOUNTING HEIGHT)
- 8 RE-INSTALL EXISTING SANITARY NAPKIN DISPOSAL (REFER TO STANDARD MOUNTING HEIGHT)
  9 REINSTALL EXISTING SINK AND ADD NEW FAUCET
- (REFER TO SPECIFICATION)
  10 RELOCATE EXISTING SOAP DISPENSER (REFER TO STANDARD MOUNTING HEIGHT)
- 11 RE-INSTALL EXISTING GRAB BAR (REFER TO STANDARD MOUNTING HEIGHT)
- 12 NEW PAPER TOWEL DISPENSER, OWNER PROVIDED (REFER TO STANDARD MOUNTING HEIGHT)
- 13 RE-INSTALL EXISTING MIRROR (REFER TO STANDARD MOUNTING HEIGHT)
- 14 REPLACE MISSING PLUMBING COVER.
   15 NEW URINAL (REFER TO STANDARD MOUNTING
- 15 NEW URINAL (REFER TO STANDARD MOUNTIN HEIGHT), REF. MECHANICAL.
- 16 NEW PAPER TOWEL DISPENSER (REFER TO STANDARD MOUNTING HEIGHT)
- 17 INSTALL NEW FLUSH VALVE, REF. MECHANICAL
- 18 INSTALL NEW STAINLESS STEEL PLATE COVER19 NEW WATER CLOSET AND SEAT, REF.
- MECHANICAL. 20 NEW SINK AND FAUCET (REFER TO STANDARD
- MOUNTING HEIGHT), REF. MECHANICAL
- 22 PAINT ALL WALLS P-1 (REFER TO FINISH LEGEND).
  23 PAINT EXISTING DOOR FRAME TO MATCH EXIST.
  24 PATCH, REPAIR AND PAINT WHERE EXISTING
- PARTITION WAS LOCATED. 25 PAINT EXISTING JUNCTION BOX P-1.
- 26 NEW TOILET PAPER DISPENSER (REFER TO
- STANDARD MOUNTING HEIGHT) 27 REAPPLY SEALANT AT JOINT BETWEEN FLOOR AND WALL.

#### PLAN GENERAL NOTES:

- I. REFER TO MECHANICAL AND ELECTRICAL DRAWINGS FOR COMPLETE MEP SCOPE.
- 2. PLAN DIMENSIONS DO NOT INCLUDE WALL THICKNESS.
- ALL AREAS DAMAGED BY DEMOLITION WORK ARE TO BE PATCHED AND REPAIRED OR REPLACED TO MATCH ADJACENT SURFACES.
- I. PATCH AND REPAIR REMAINING WALLS; AT ARCHITECTURAL, MECHANICAL, AND ELECTRICAL DEMOLITION POINTS WITH SIMILAR MATERIALS IN SIZE, COLOR AND TEXTURE.
- 5. PATCH AND REPAIR ALL EXPOSED ANCHOR HOLES AT WALLS, USING EPOXY AT GLAZED CMU AND GROUT AT PAINTED CMU.
- 6. REFER TO FINISH MATERIAL LEGEND FOR SPECIFIC MANUFACTURER AND COLOR.
- 7. REFER TO SPECIFICATIONS FOR COMPLETE FINISH INFORMATION.
- 8. REFER TO REFLECTED CEILING PLANS FOR CEILING TYPES, HEIGHTS AND FINISH INFORMATION
- ALL WALL MOUNTED MECHANICAL EQUIPMENT (DIFFUSERS, GRILLES, ETC) AND ELECTRICAL EQUIPMENT (PANELS, ETC) SHALL BE PAINTED TO MATCH THE ADJACENT WALL COLOR. REFER TO MECHANICAL AND ELECTRICAL DRAWINGS FOR QUANTITIES AND LOCATIONS.
- 10. WHERE REMOVAL OR MODIFICATION TO A FINISH MATERIAL IS SHOWN, BUT NEW FINISHES ARE NOT SCHEDULED, PATCH AND REPAIR TO MATCH EXISTING FINISH CONDITION AS REQUIRED.
- 11. ALL EXISTING PLUMBING FIXTURES TO BE TIGHTENED, AS NEEDED. REF. MECHANICAL.
- 12. APPLY NEW SEALANT AROUND ALL EXISTING PLUMBING FIXTURES.
- 13. ALL EXISTING PLUMBING FIXTURES TO REMAIN, UNLESS OTHERWISE NOTED.
- 14. POWERWASH ALL EXISTING TILE FLOORING.

NO.	REVISION	DATE

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PROJECT TITLE

TOILET ROOM RENOVATIONS FOR: WESTERN HIGH SCHOOL BAY CITY PUBLIC SCHOOLS

BAY CITY, MICHIGAN


SHEET TITLE

ENLARGED PLANS


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PROJECT DATE 2024	A2.22
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#### MATERIAL LEGEND

SN	MANUFACTURER	COLOR	REMARKS
<b>NTERIOR PAINT</b>			
-1	SHERWIN WILLIAMS	SW 7044 AMAZING GRAY	
-2	SHERWIN WILLIAMS	SW 7757 HIGH REFLECTIVE WHITE	
-3	SHERWIN WILLIAMS	MATCH EXISING	EXIST. DOOR FRAMES
OILET PARTITIO	N	•	
P-1	SCRANTON	NICKEL HAMMERED	



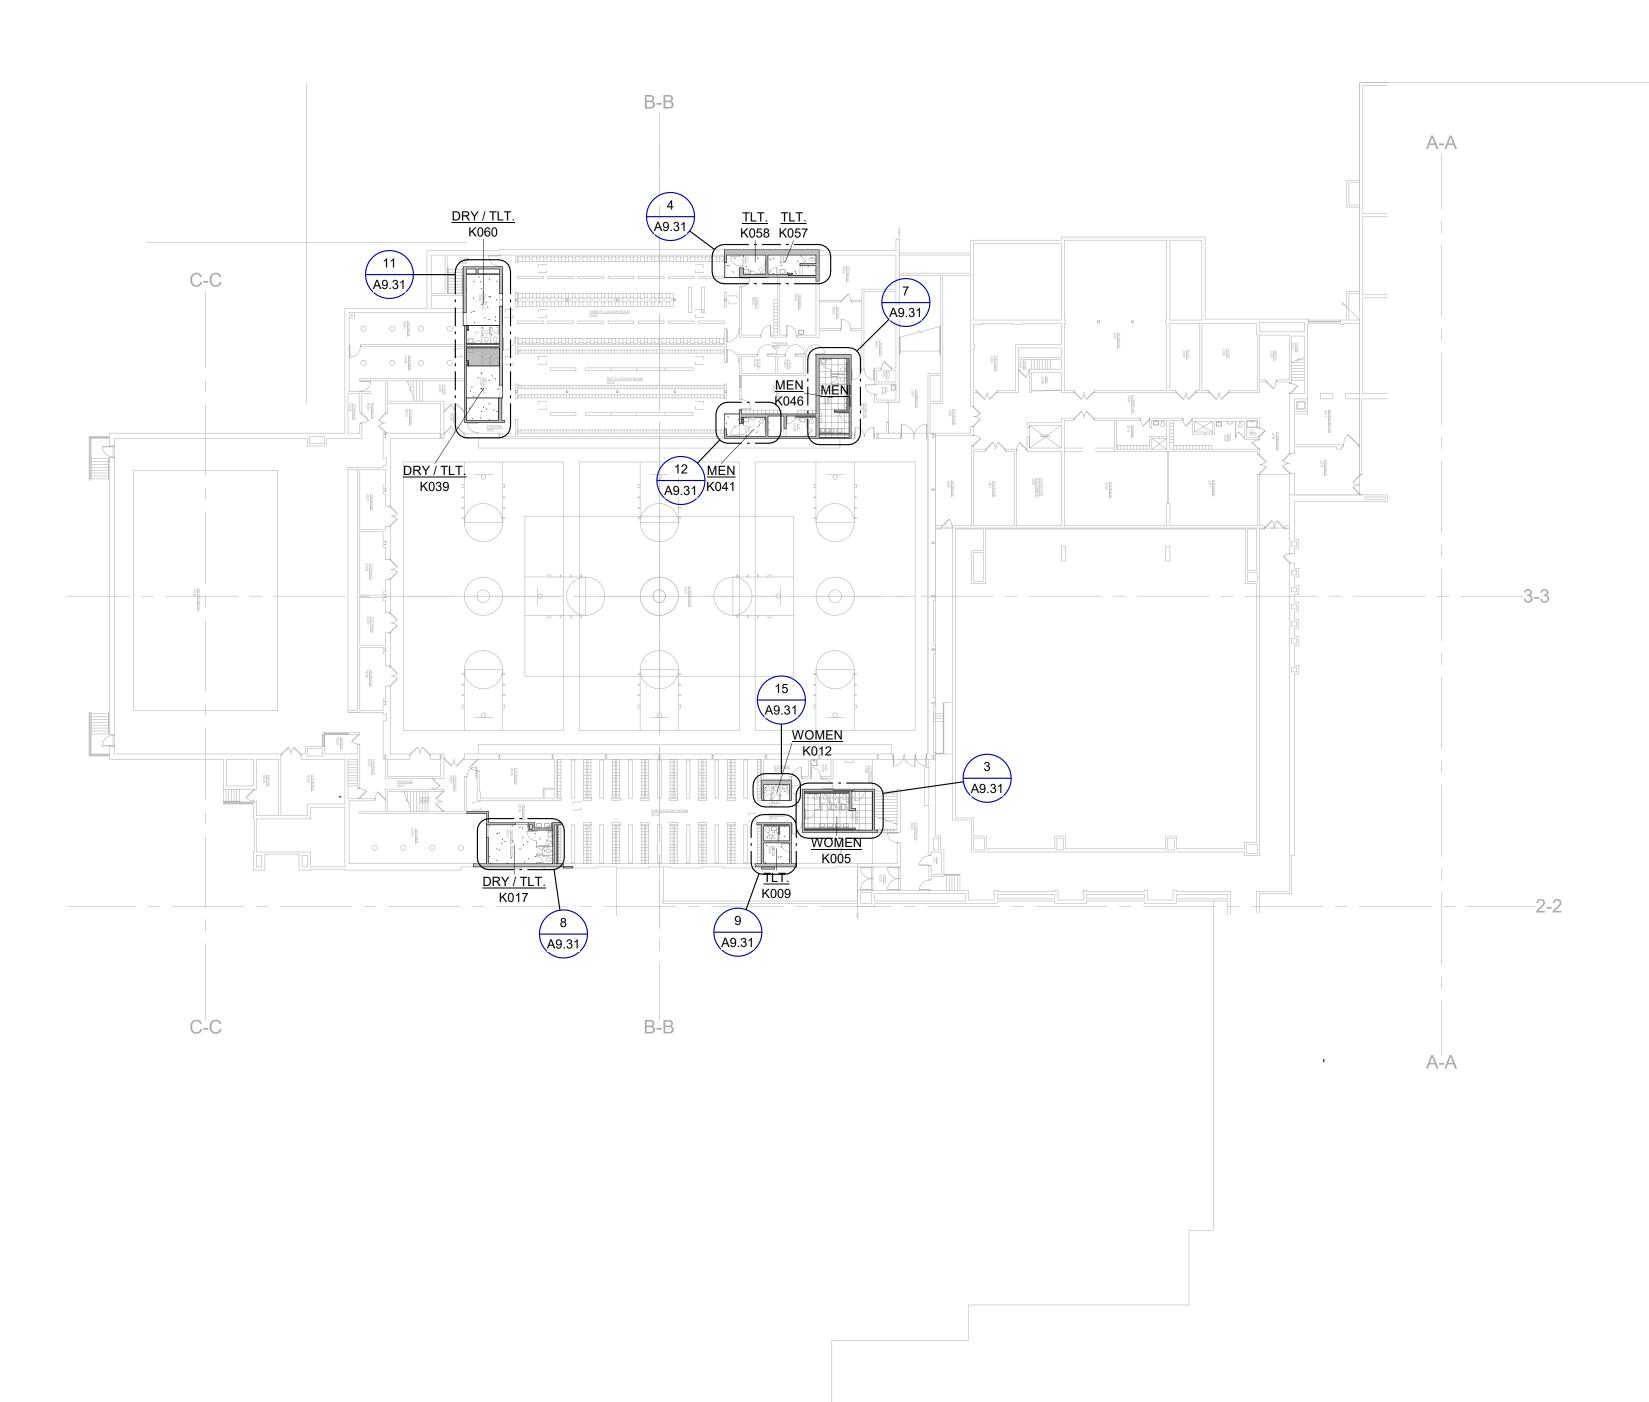


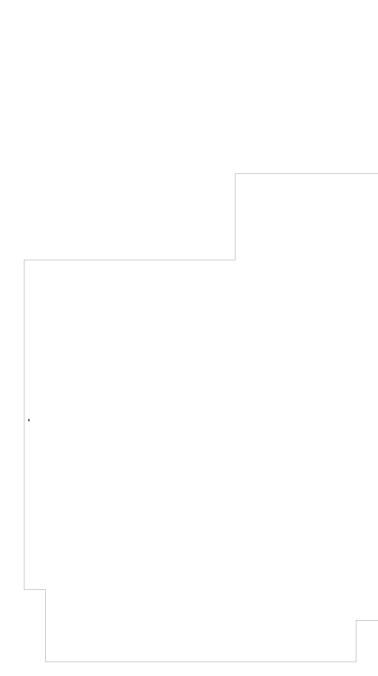

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CEILING PLAN GENERAL NOTES:
<ol> <li>ALL NOTED CEILING HEIGHTS ARE RELATIVE TO THE FINISH FLOOR BELOW.</li> </ol>
2. ALL DIMENSIONS ARE TO FINISH FACE OF PARTITION AND TO CENTERLINE OF LIGHT FIXTURES U.O.N.
3. REFER TO MECHANICAL DRAWINGS FOR DIFFUSER TYPES. REFER TO ARCHITECTURAL DRAWINGS FOR EXACT PLACEMENT OF DEVICES. NOTIFY ARCHITECT OF ANY POTENTIAL CONFLICTS PRIOR TO PROCEEDING WITH WORK.
<ol> <li>REFER TO ELECTRICAL DRAWINGS FOR LIGHT FIXTURE TYPES. REFER TO ARCHITECTURAL DRAWINGS FOR EXACT PLACEMENT OF FIXTURES. NOTIFY ARCHITECT OF ANY POTENTIAL CONFLICTS PRIOR TO PROCEEDING WITH WORK.</li> </ol>
<ol> <li>ALL PLASTER CEILINGS AND CEILING GRIDS TO BE PAINTED P-2.</li> </ol>
REFLECTED CEILING LEGEND:
2' x 2' SUSPENDED ACOUSTICAL TILE
GYPSUM BOARD OR PLASTER CEILING
NO. REVISION DATE
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PROJECT TITLE TOILET ROOM RENOVATIONS FOR:
WESTERN HIGH SCHOOL BAY CITY PUBLIC SCHOOLS
BAY CITY, MICHIGAN
SHEET TITLE LOWER LEVEL REFLECTED CEILING MASTER PLAN
PROJECT NUMBER SHEET NUMBER
PROJECT NUMBER SHEET NUMBER 2019113.33 PROJECT DATE
PROJECT NUMBER 2019113.33 PROJECT DATE



NORTH FIRST FLOOR REFLECTED CEILING MASTER PLAN SCALE: 1" = 30'-0"
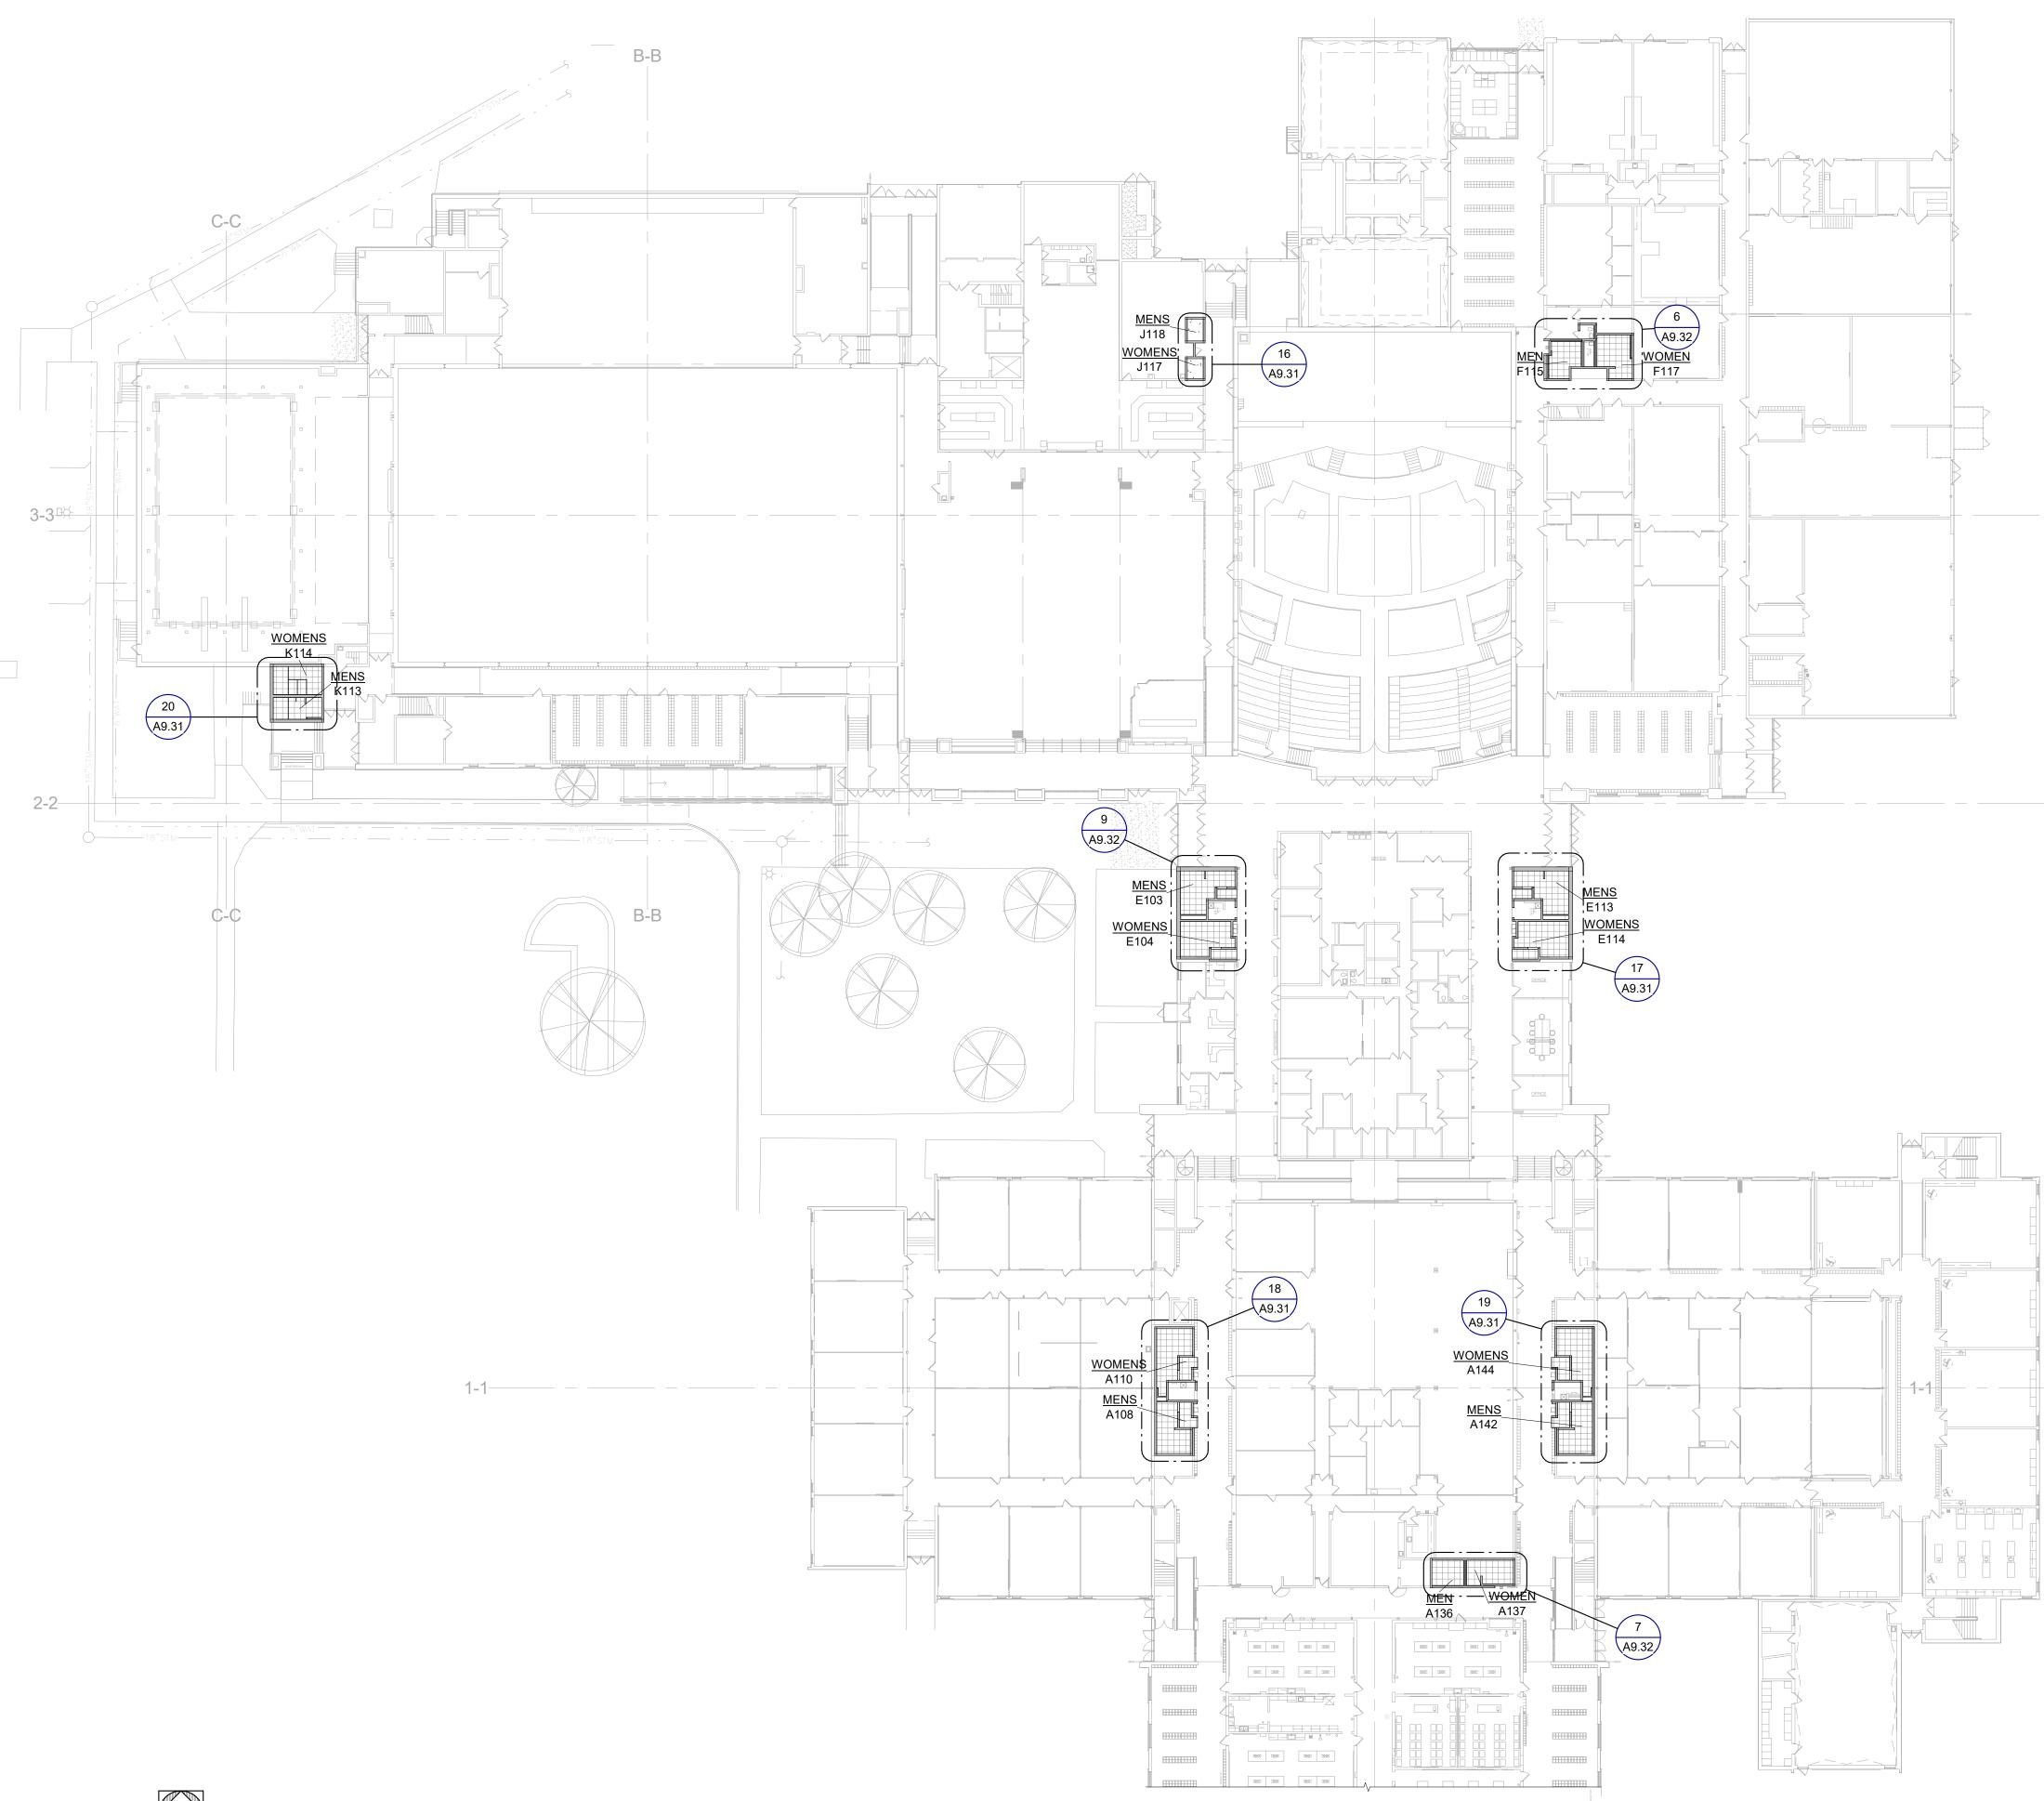
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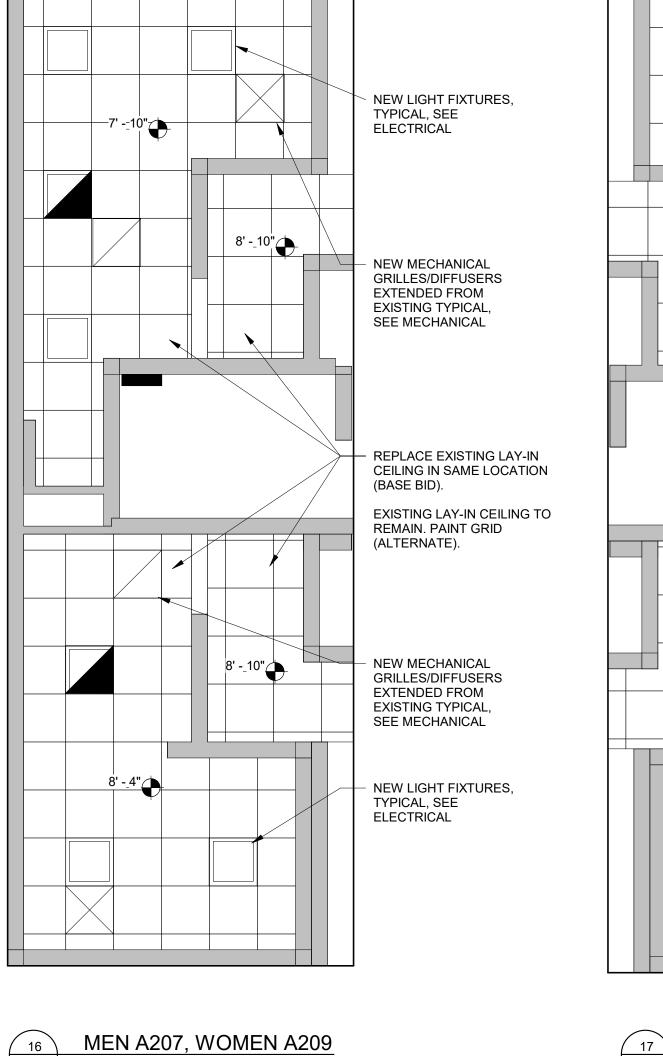
NORTH SECOND FLOOR REFLECTED CEILING MASTER PLAN SCALE: 1" = 30'-0"


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5. ALL PLASTER CEILINGS A PAINTED P-2.	ND CEILING GRIDS TO BE
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SCALE: 1/4" = 1'-0"







WOMEN A234, MEN A236


SCALE: 1/4" = 1'-0"

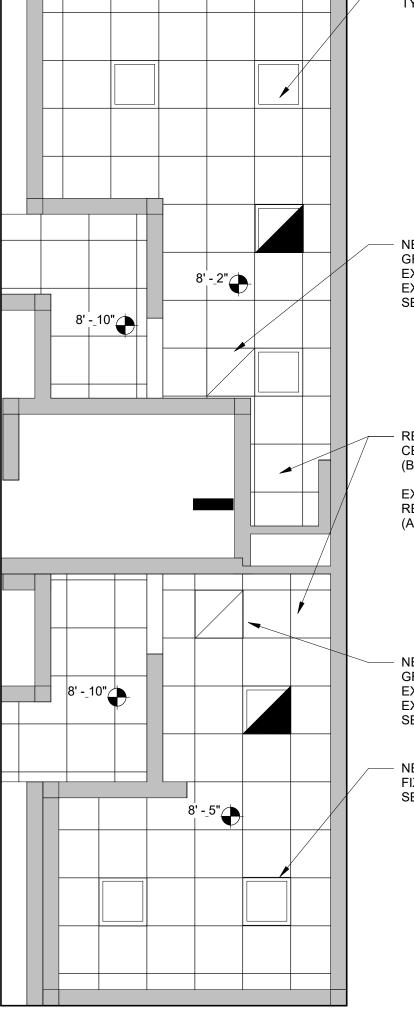(17) (A9.32)

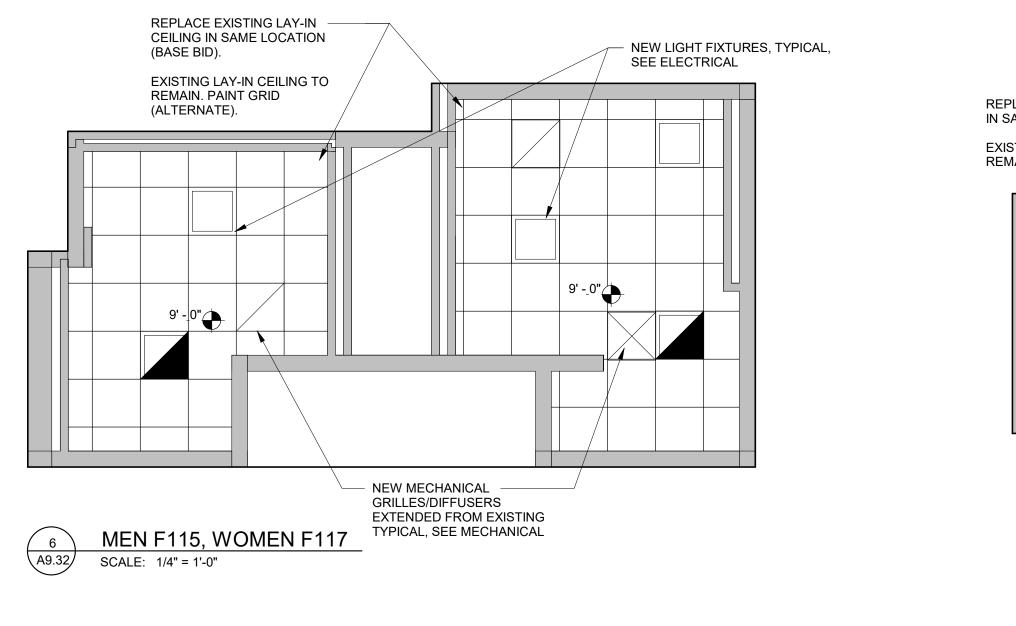

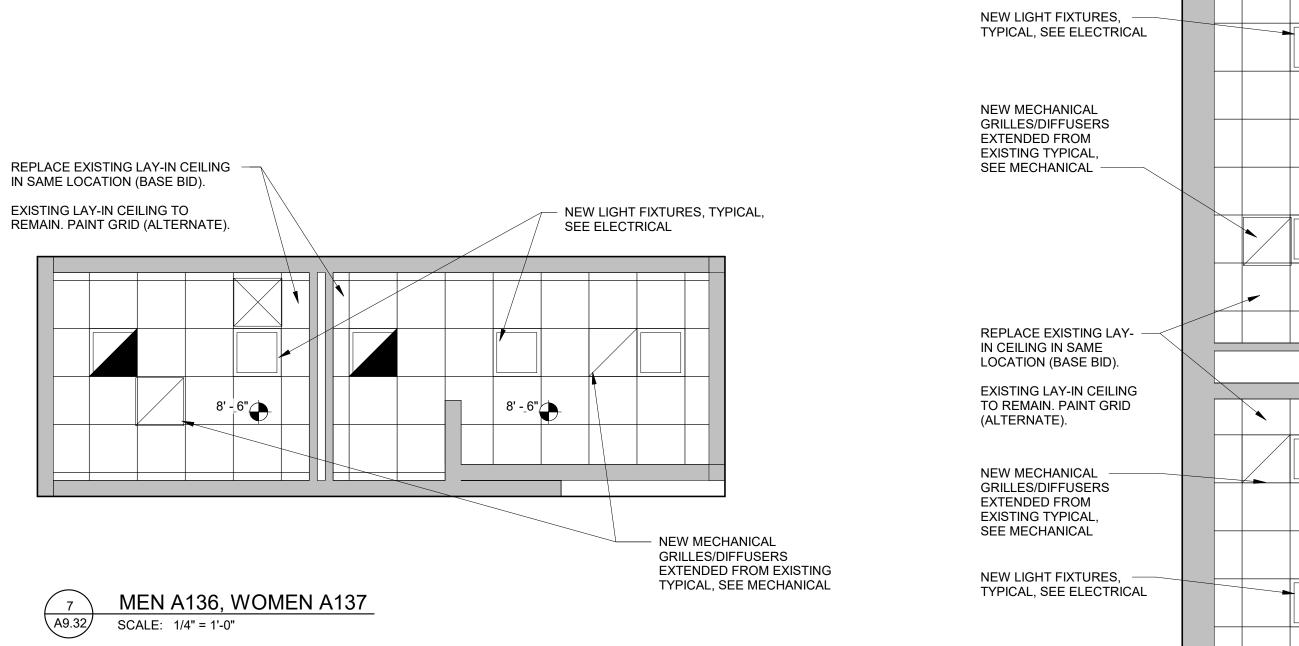

NEW LIGHT FIXTURES, TYPICAL, SEE ELECTRICAL

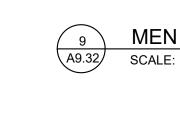


NEW MECHANICAL GRILLES/DIFFUSERS EXTENDED FROM EXISTING TYPICAL, SEE MECHANICAL

REPLACE EXISTING LAY-IN CEILING IN SAME LOCATION (BASE BID). EXISTING LAY-IN CEILING TO

REMAIN. PAINT GRID (ALTERNATE).

NEW MECHANICAL **GRILLES/DIFFUSERS** EXTENDED FROM EXISTING TYPICAL, SEE MECHANICAL

- NEW LIGHT FIXTURES, TYPICAL, SEE ELECTRICAL

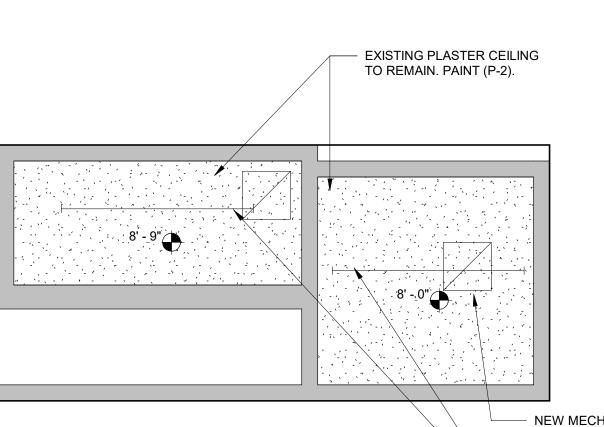



MEN A214, WOMEN A215 SCALE: 1/4" = 1'-0"

NEW MECHANICAL GRILLES/DIFFUSERS EXTENDED FROM EXISTING TYPICAL, SEE MECHANICAL

NEW LIGHT FIXTURES, TYPICAL, SEE ELECTRICAL

TERIAL LEGEND		
SN MANUFACTURER	COLOR	REMARKS
SHERWIN WILLIAMS SHERWIN WILLIAMS	SW 7044 AMAZING GRAY SW 7757 HIGH REFLECTIVE WHITE	
SHERWIN WILLIAMS ET PARTITION	MATCH EXISING	EXIST. DOOR FRAMES
SCRANTON	NICKEL HAMMERED	
9'8"		
	_	
9'8"		
	9'9"	
E103, WOMEN E104 1/4" = 1'-0"		
1/4 - 1-0		

# **CEILING PLAN GENERAL NOTES:** ALL NOTED CEILING HEIGHTS ARE RELATIVE TO THE FINISH FLOOR BELOW. ALL DIMENSIONS ARE TO FINISH FACE OF PARTITION AND TO CENTERLINE OF LIGHT FIXTURES U.O.N. REFER TO MECHANICAL DRAWINGS FOR DIFFUSER TYPES. REFER TO ARCHITECTURAL DRAWINGS FOR EXACT PLACEMENT OF DEVICES. NOTIFY ARCHITECT OF ANY POTENTIAL CONFLICTS PRIOR TO PROCEEDING WITH WORK. REFER TO ELECTRICAL DRAWINGS FOR LIGHT FIXTURE TYPES. REFER TO ARCHITECTURAL DRAWINGS FOR EXACT PLACEMENT OF FIXTURES. NOTIFY ARCHITECT OF ANY POTENTIAL CONFLICTS PRIOR TO PROCEEDING WITH WORK. . ALL PLASTER CEILINGS AND CEILING GRIDS TO BE PAINTED P-2. **REFLECTED CEILING LEGEND:** 2' x 2' SUSPENDED ACOUSTICAL TILE GYPSUM BOARD OR PLASTER CEILING NO. DATE REVISION WTAARCH.COM **WTA** ARCHITECTS 100 S Jefferson Ave, Suite 601 Saginaw, Michigan 48607 989 752 8107 COPYRIGHT © 2024 PROJECT TITLE TOILET ROOM RENOVATIONS FOR: WESTERN HIGH SCHOOL BAY CITY PUBLIC SCHOOLS BAY CITY, MICHIGAN SHEET TITLE ENLARGED REFLECTED CEILING PLANS

PROJECT NUMBER

PROJECT DATE

2024


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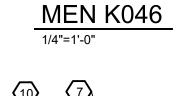
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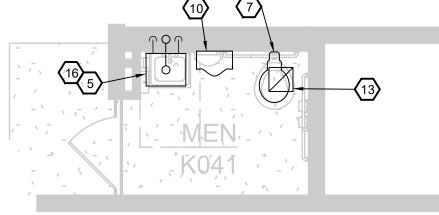
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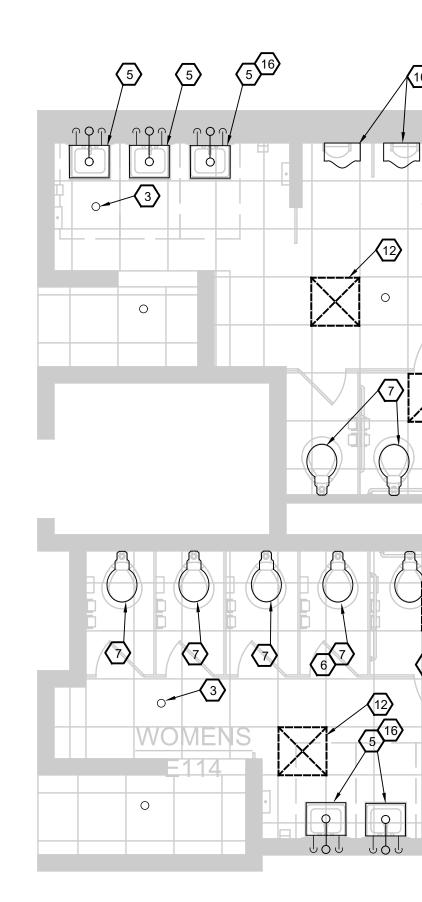
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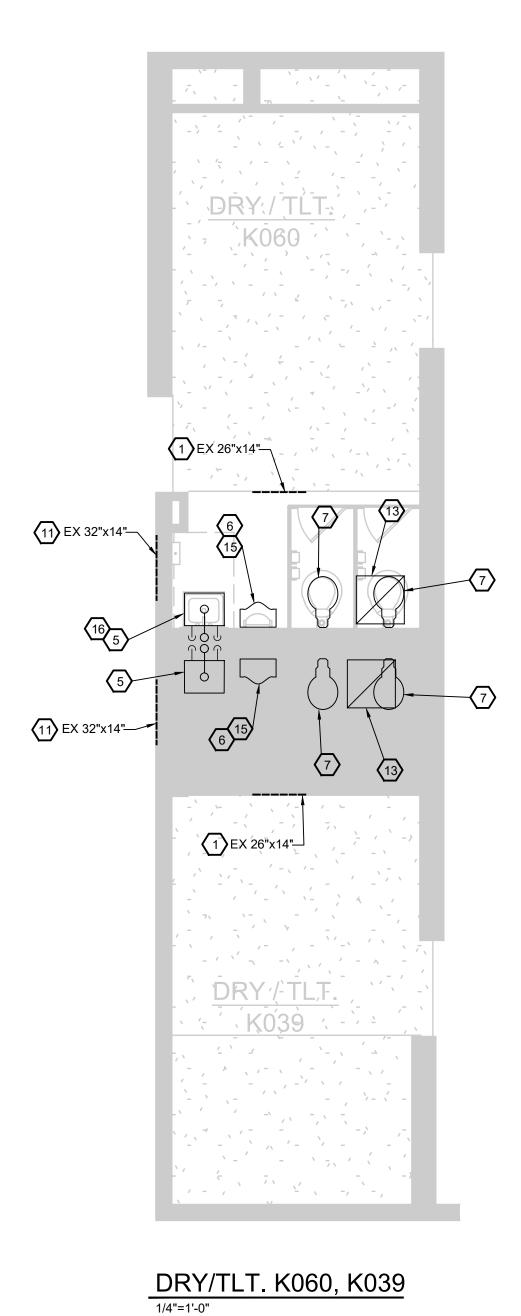






MEN K041, TLT. K042 1/4"=1'-0"




MEN E113, WOMEN E114 1/4"=1'-0"

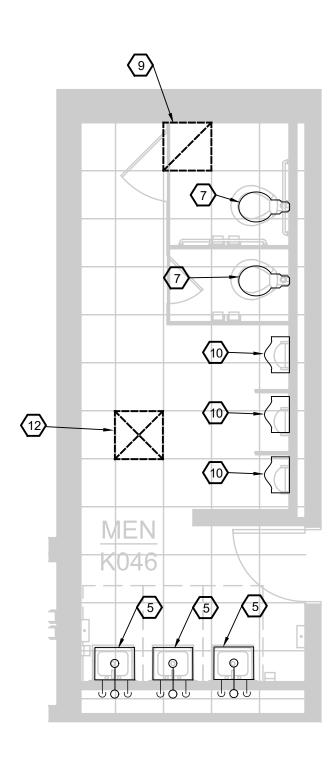


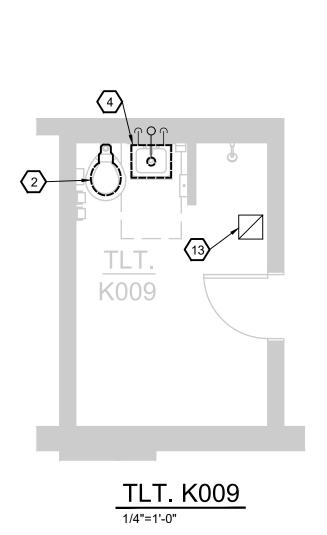

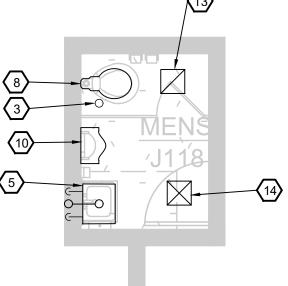

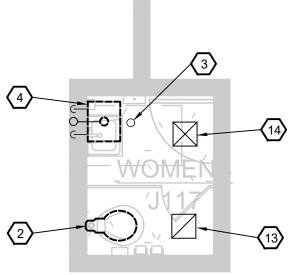

WOMEN J117, MEN J118 1/4"=1'-0"

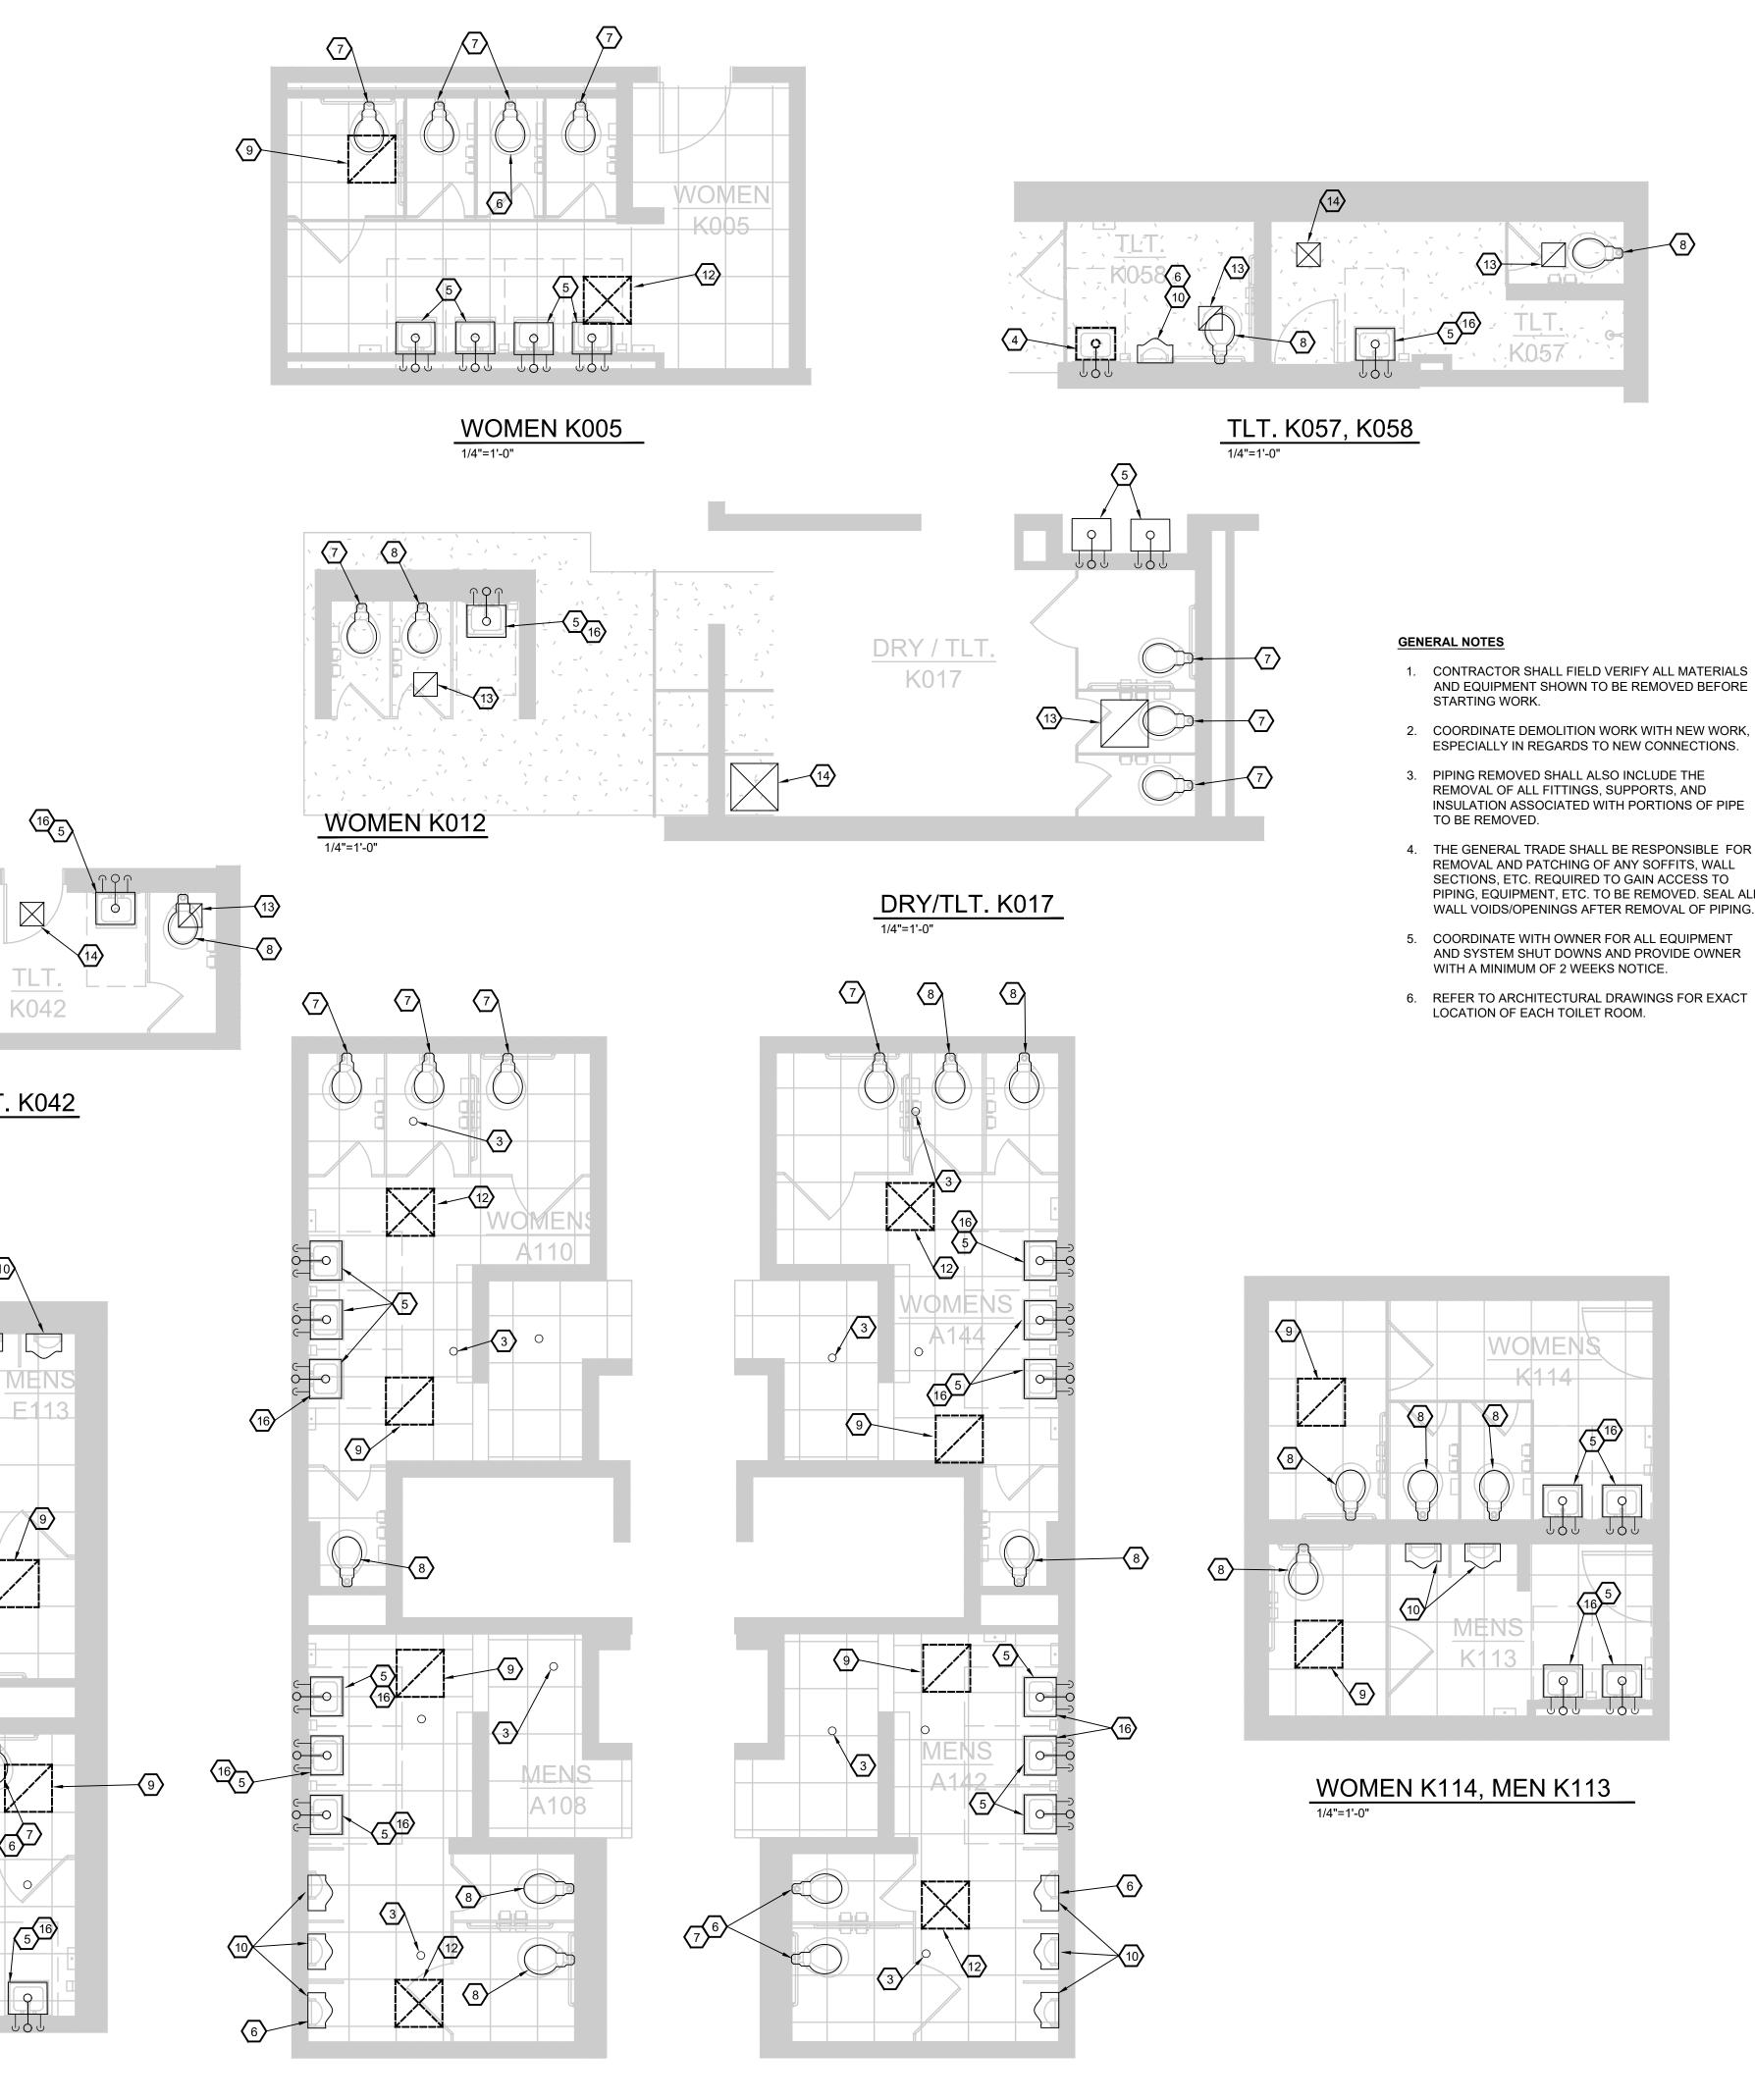

MEN A142, WOMEN A144 1/4"=1'-0"

- AND EQUIPMENT SHOWN TO BE REMOVED BEFORE
- 2. COORDINATE DEMOLITION WORK WITH NEW WORK, ESPECIALLY IN REGARDS TO NEW CONNECTIONS.
- REMOVAL OF ALL FITTINGS, SUPPORTS, AND INSULATION ASSOCIATED WITH PORTIONS OF PIPE
- 4. THE GENERAL TRADE SHALL BE RESPONSIBLE FOR REMOVAL AND PATCHING OF ANY SOFFITS, WALL SECTIONS, ETC. REQUIRED TO GAIN ACCESS TO PIPING, EQUIPMENT, ETC. TO BE REMOVED. SEAL ALL WALL VOIDS/OPENINGS AFTER REMOVAL OF PIPING.
- 5. COORDINATE WITH OWNER FOR ALL EQUIPMENT AND SYSTEM SHUT DOWNS AND PROVIDE OWNER
- 6. REFER TO ARCHITECTURAL DRAWINGS FOR EXACT

#### KEYED NOTES

- 1 APPROXIMATE LOCATION OF EXISTING 26"X14" SUPPLY AIR GRILLE IN SOFFIT TO BE REMOVED AND REPLACED. FIELD VERIFY EXACT LOCATION PRIOR TO REMOVAL.
- 2 EXISTING FLOOR MOUNTED WATER CLOSET TO BE REMOVED AND REPLACED. REMOVAL SHALL INCLUDE ASSOCIATED FLUSH VALVE, FITTINGS ETC.
- 3 APPROXIMATE LOCATION OF EXISTING FIRE PROTECTION SPRINKLER HEAD TO REMAIN. TYPICAL FOR ALL FIRE PROTECTION SPRINKLER HEADS.
- 4 EXISTING LAVATORY TO BE REMOVED AND REPLACED. REMOVAL SHALL INCLUDE ASSOCIATED FAUCET, PIPE PROTECTIVE COVER, ANGLE CHECK STOPS, PIPING, FITTINGS ETC.
- 5 EXISTING LAVATORY TO REMAIN. EXISTING FAUCET PIPE PROTECTIVE COVERS, THERMOSTATIC MIXING VALVE, FAUCET, GRID STRAINER, TAILPIECE, P-TRAP, AND ANGLE VALVE TO BE REMOVED AND REPLACED. REPLACE PIPING AND FITTINGS TO BE ABLE TO REPLACE EXISTING LAVATORY TRIM.
- 6 EXISTING FLUSH VALVE TO BE REMOVED AND REPLACED.
- 7 REMOVE AND REINSTALL EXISTING WATER CLOSET THE INTENT IS TO SECURE EXISTING WATER CLOSET. WATER CLOSET IS LOOSE. EXISTING WATER CLOSET TO BE REUSED. REMOVE AND REPLACE EXISTING WATER CLOSET SEAT TO MATCH EXISTING FIXTURE.
- 8 EXISTING FLOOR MOUNTED WATER CLOSET TO REMAIN. REMOVE AND REPLACE WATER CLOSET SEAT TO MATCH EXISTING FIXTURE.
- 9 APPROXIMATE LOCATION OF EXISTING EXHAUST AIR GRILLE TO BE REMOVED AND REPLACED. FIELD VERIFY EXACT LOCATION.
- 10 EXISTING URINAL TO REMAIN.
- APPROXIMATE LOCATION OF EXISTING 32"X14" EXHAUST AIR GRILLE IN WALL TO BE REMOVED AND REPLACED. FIELD VERIFY EXACT LOCATION PRIOR TO REMOVAL.
- (12) APPROXIMATE LOCATION OF EXISTING SUPPLY AIR DIFFUSER TO BE REMOVED AND REPLACED. FIELD VERIFY EXACT LOCATION.
- APPROXIMATE LOCATION OF EXISTING EXHAUST AIR GRILLE IN EXISTING DRYWALL CEILING TO REMAIN.
- (14) APPROXIMATE LOCATION OF EXISTING SUPPLY AIR DIFFUSER IN EXISTING DRYWALL CEILING TO REMAIN.
- 15 REMOVE AND REINSTALL EXISTING URINAL. THE INTENT IS TO SECURE EXISTING URINAL. URINAL IS LOOSE. EXISTING URINAL TO BE REUSED.
- (16) REMOVE AND REINSTALL EXISTING LAVATORY. THE INTENT IS TO SECURE EXISTING LAVATORY. LAVATORY IS LOOSE. EXISTING LAVATORY TO BE REUSED.


	100% ISSUED FOR BID	10/28/24
	50% REVIEW	10/03/2024
NO.	REVISION	DATE

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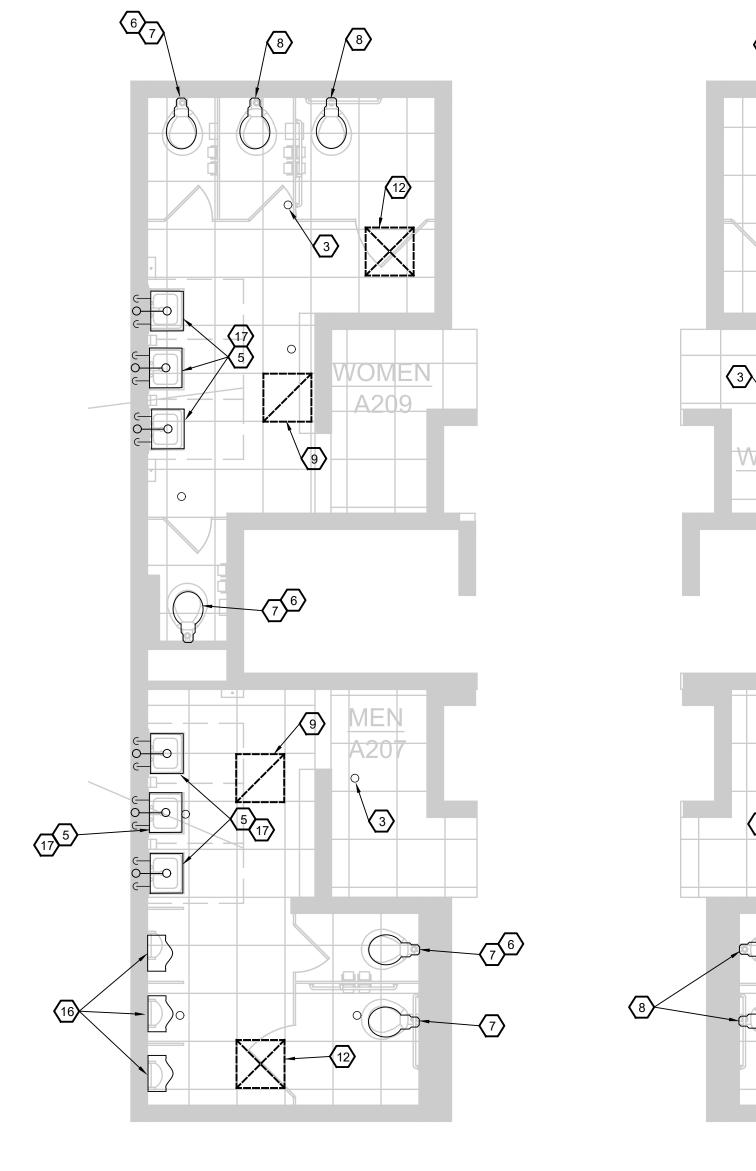
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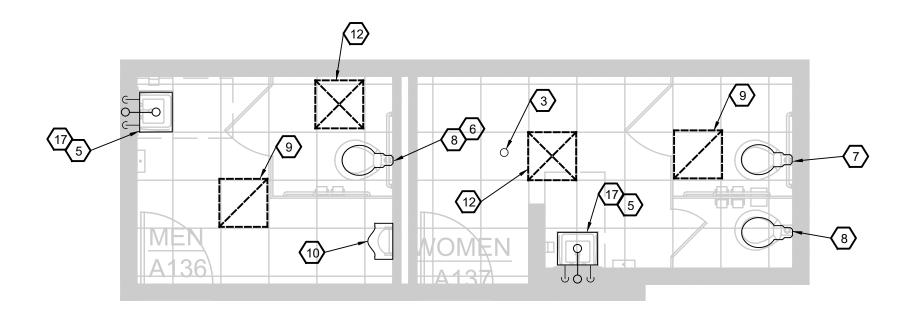


MEN F115, WOMEN F117





MEN A207, WOMEN A209

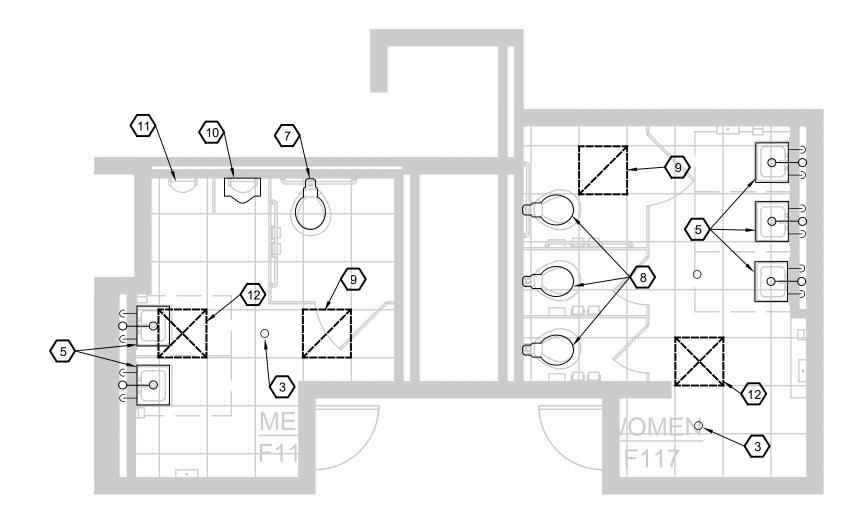1/4"=1'-0"




MEN A136, WOMEN A137

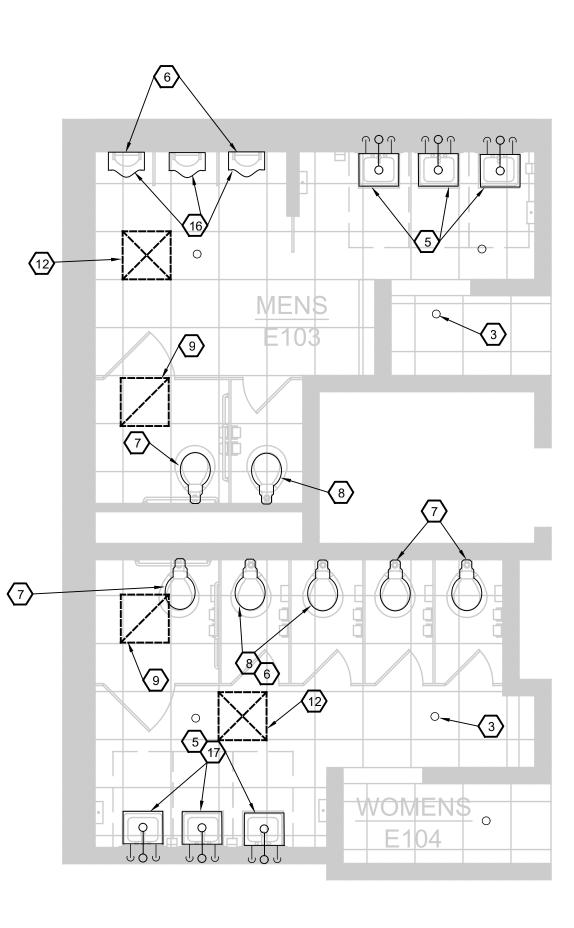

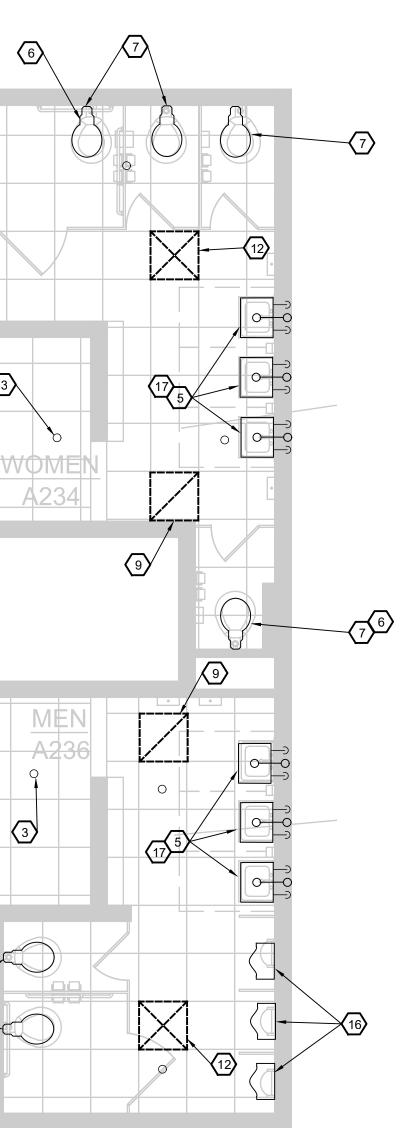

WOMEN A234, MEN A236

1/4"=1'-0"

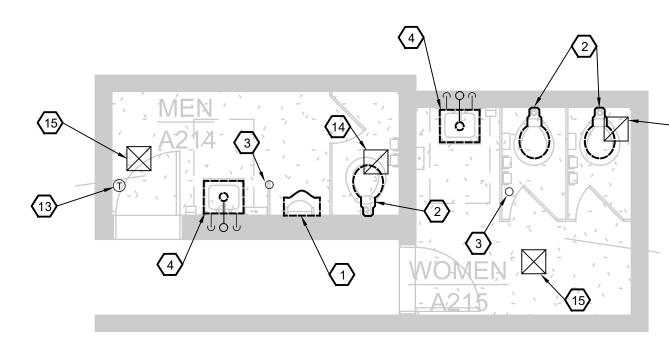

#### MEN A214, WOMEN A215 1/4"=1'-0"


### MEN E103, WOMEN E104

#### GENERAL NOTES


- CONTRACTOR SHALL FIELD VERIFY ALL MATERIALS AND EQUIPMENT SHOWN TO BE REMOVED BEFORE STARTING WORK.
- 2. COORDINATE DEMOLITION WORK WITH NEW WORK, ESPECIALLY IN REGARDS TO NEW CONNECTIONS.
- 3. PIPING REMOVED SHALL ALSO INCLUDE THE REMOVAL OF ALL FITTINGS, SUPPORTS, AND INSULATION ASSOCIATED WITH PORTIONS OF PIPE TO BE REMOVED.
- 4. THE GENERAL TRADE SHALL BE RESPONSIBLE FOR REMOVAL AND PATCHING OF ANY SOFFITS, WALL SECTIONS, ETC. REQUIRED TO GAIN ACCESS TO PIPING, EQUIPMENT, ETC. TO BE REMOVED. SEAL ALL WALL VOIDS/OPENINGS AFTER REMOVAL OF PIPING.
- 5. COORDINATE WITH OWNER FOR ALL EQUIPMENT AND SYSTEM SHUT DOWNS AND PROVIDE OWNER WITH A MINIMUM OF 2 WEEKS NOTICE.
- 6. REFER TO ARCHITECTURAL DRAWINGS FOR EXACT LOCATION OF EACH TOILET ROOM.

<u>KE)</u>	ED NOTES		
1	EXISTING URINAL TO BE R REMOVAL SHALL INCLUDE FITTINGS ETC.		
2	EXISTING FLOOR MOUNTE REMOVED AND REPLACED ASSOCIATED FLUSH VALV	. REMOVAL SHA	LL INCLUDE
3	APPROXIMATE LOCATION PROTECTION SPRINKLER I FOR ALL FIRE PROTECTIO	HEAD TO REMAI	N. TYPICAL
4	EXISTING LAVATORY TO B REPLACED. REMOVAL SHA FAUCET, PIPE PROTECTIV STOPS, PIPING, FITTINGS I	LL INCLUDE AS E COVER, ANGL	SOCIATED
5	EXISTING LAVATORY TO R PIPE PROTECTIVE COVERS VALVE, FAUCET, GRID STF AND ANGLE VALVE TO BE REPLACE PIPING AND FITT REPLACE EXISTING LAVAT	EMAIN. EXISTIN S, THERMOSTAT AINER, TAILPIE REMOVED AND 'INGS TO BE ABI	IC MIXING CE, P-TRAP, REPLACED.
6	EXISTING FLUSH VALVE TO REPLACED.	D BE REMOVED	AND
7	REMOVE AND REINSTALL I THE INTENT IS TO SECURE WATER CLOSET IS LOOSE TO BE REUSED. REMOVE / WATER CLOSET SEAT TO I	E EXISTING WAT . EXISTING WAT AND REPLACE E	ER CLOSET. ER CLOSET XISTING
8	EXISTING FLOOR MOUNTE REMAIN. REMOVE AND RE SEAT TO MATCH EXISTING	PLACE WATER (	
9	APPROXIMATE LOCATION GRILLE TO BE REMOVED A VERIFY EXACT LOCATION.	ND REPLACED.	
	EXISTING URINAL TO REM		
(11)	URINAL WAS PREVIOUSLY PLUMBING CONNECTIONS	,	
(12)	APPROXIMATE LOCATION DIFFUSER TO BE REMOVE VERIFY EXACT LOCATION.	D AND REPLACE	
(13)	EXISTING THERMOSTAT TO REFASTENED TO WALL.		3E
(14)	APPROXIMATE LOCATION GRILLE IN EXISTING DRYW		
(15)	APPROXIMATE LOCATION DIFFUSER IN EXISTING DR REMAIN.		
(16)	REMOVE AND REINSTALL I	STING URINAL. U	
(17)	LOOSE. EXISTING URINAL REMOVE AND REINSTALL I		ORY, THE
	LAVATORY IS LOOSE. EXIS REUSED.	TING LAVATOR	Y TO BE
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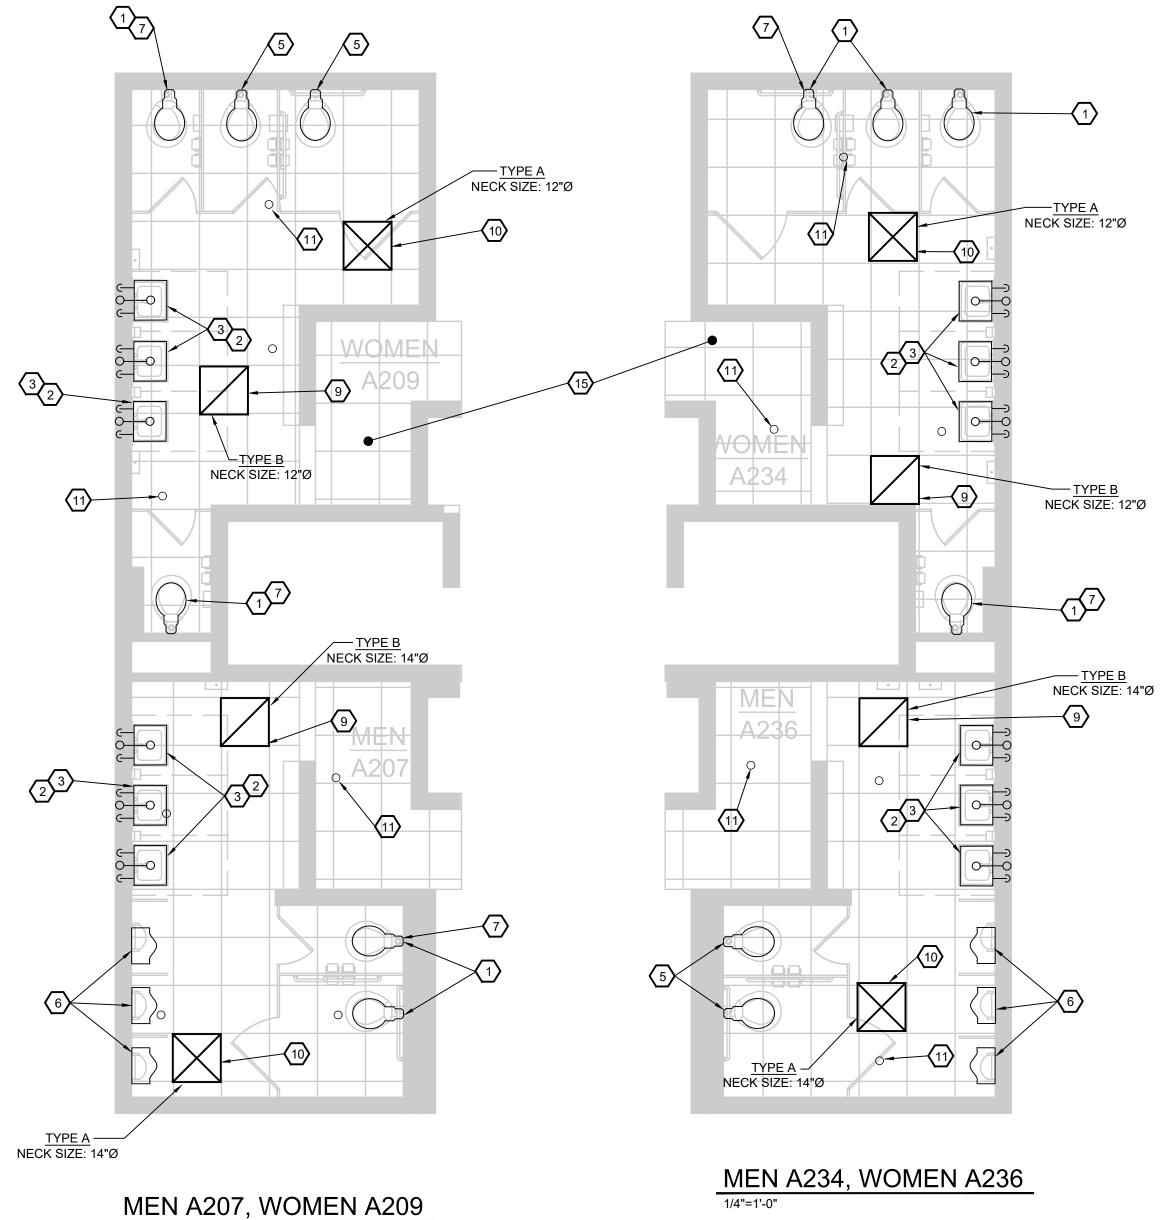



$\langle 1 \rangle$			
	REMOVE AND REINSTALL FOR ABILITY TO SECURE WATER CLOSET IS LOOSE NEW STUDS, AND NUTS A WATER CLOSET. REPLAC SEAT WITH NEW SEAT TO	EXISTING WATEI E. INSTALL NEW <sup>V</sup> ND REINSTALL E E EXISTING WAT	R CLOSET. WAX RING, XISTING ER CLOSET
2	EXISTING LAVATORY IS LO TO BE RESUPPORTED AS CARRIER WITH NEW FAST REMOVE LAVATORY AS N EXISTING LAVATORY TO E	NECESSARY ON ENERS. INTENT ECESSARY TO S	I EXISTING IS TO ECURE
3	EXISTING LAVATORY TO F INSTALL NEW FAUCET, PII THERMOSTATIC MIXING V GRID STRAINER AND ASS ABLE TO REPLACE GRID S	REMAIN. FURNIS PE PROTECTIVE ALVE, ANGLE ST OCIATED FITTIN	H AND COVERS, OP VALVES,
4	FURNISH AND INSTALL NE FITTINGS. CONNECT TO E TO INSTALL NEW CARRIEI NECESSARY FOR INSTALL	XISTING PIPING. R WITH NEW LAV	INTENT IS ATORY AS
5	EXISTING WATER CLOSET EXISTING WATER CLOSET MATCH EXISTING.		
6	REMOVE AND REINSTALL ABILITY TO SECURE EXIS LOOSE. EXISTING URINAL NEW FASTENERS. INTENT URINAL AS NECESSARY T TO EXISTING CARRIER.	TING URINAL. UF TO BE RESUPPO IS TO REMOVE	RINAL IS ORTED WITH EXISTING
$\langle 7 \rangle$	FURNISH AND INSTALL NE EXISTING URINAL/WATER		ON
8 9	EXISTING URINAL TO REM APPROXIMATE LOCATION GRILLE TO BE INSTALLED GRILLE LOCATION WITH A PLANS, ELECTRICAL LIGH DUCTWORK LOCATION(S) SIZE AS NECESSARY FOR DUCTWORK. FIELD VERIF LOCATION OF EXISTING D	OF NEW EXHAU CLOSELY COOI RCHITECTURAL TING PLANS ANI TRANSITION GF CONNECTION T Y EXACT SIZE AN	RDINATE CEILING DEXISTING RILLE NECK OEXISTING ND
10	FURNISH AND INSTALL A I EXHAUST AIR GRILLE IN V LOCATION OF GRILLE INS DUCTWORK AND OPENING	VALL. FIELD VER TALLATION WITH	IFY EXACT
11	APPROXIMATE LOCATION DIFFUSER TO BE INSTALL DIFFUSER LOCATION WIT PLANS, ELECTRICAL LIGH DUCTWORK LOCATION(S) NECK SIZE AS NECESSAR EXISTING DUCTWORK. FIE LOCATION OF EXISTING D	ED. CLOSELY CO H ARCHITECTUR TING PLANS, AN . TRANSITION DI Y FOR CONNEC ELD VERIFY EXAM	DORDINATE AL CEILING D EXISTING FFUSER TION TO
(12)	APPROXIMATE LOCATION PROTECTION SPRINKLER LOCATION OF EXISTING S FOR ALL FIRE PROTECTIC	HEAD. FIELD VE PRINKLER HEAD	RIFY EXACT TYPICAL
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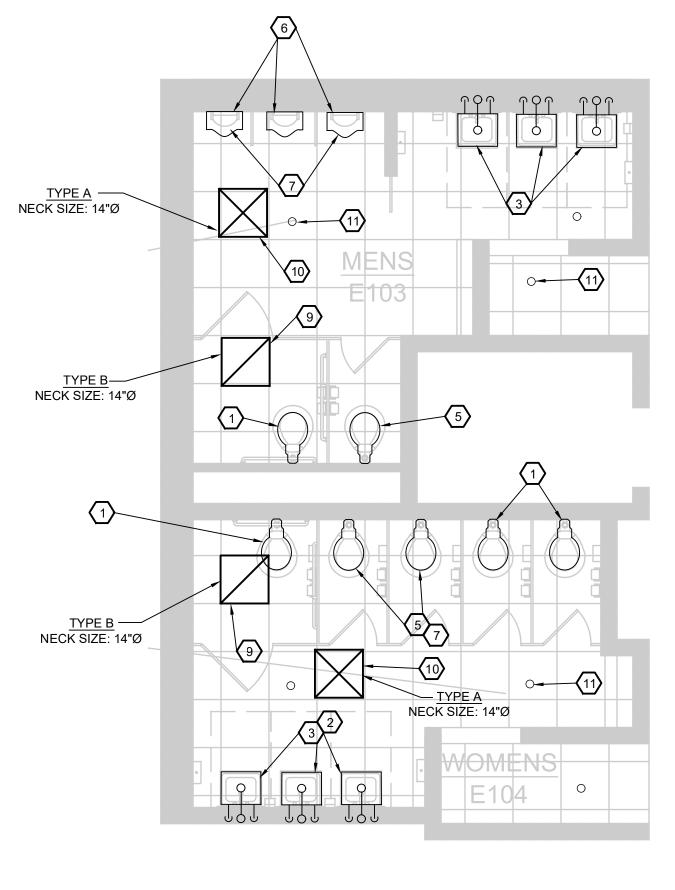
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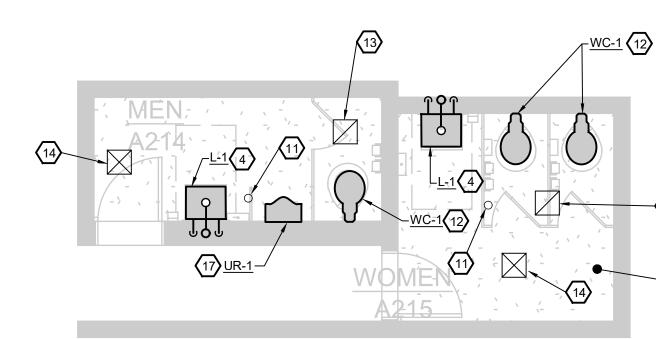
MEN F115, WOMEN F117 1/4"=1'-0"

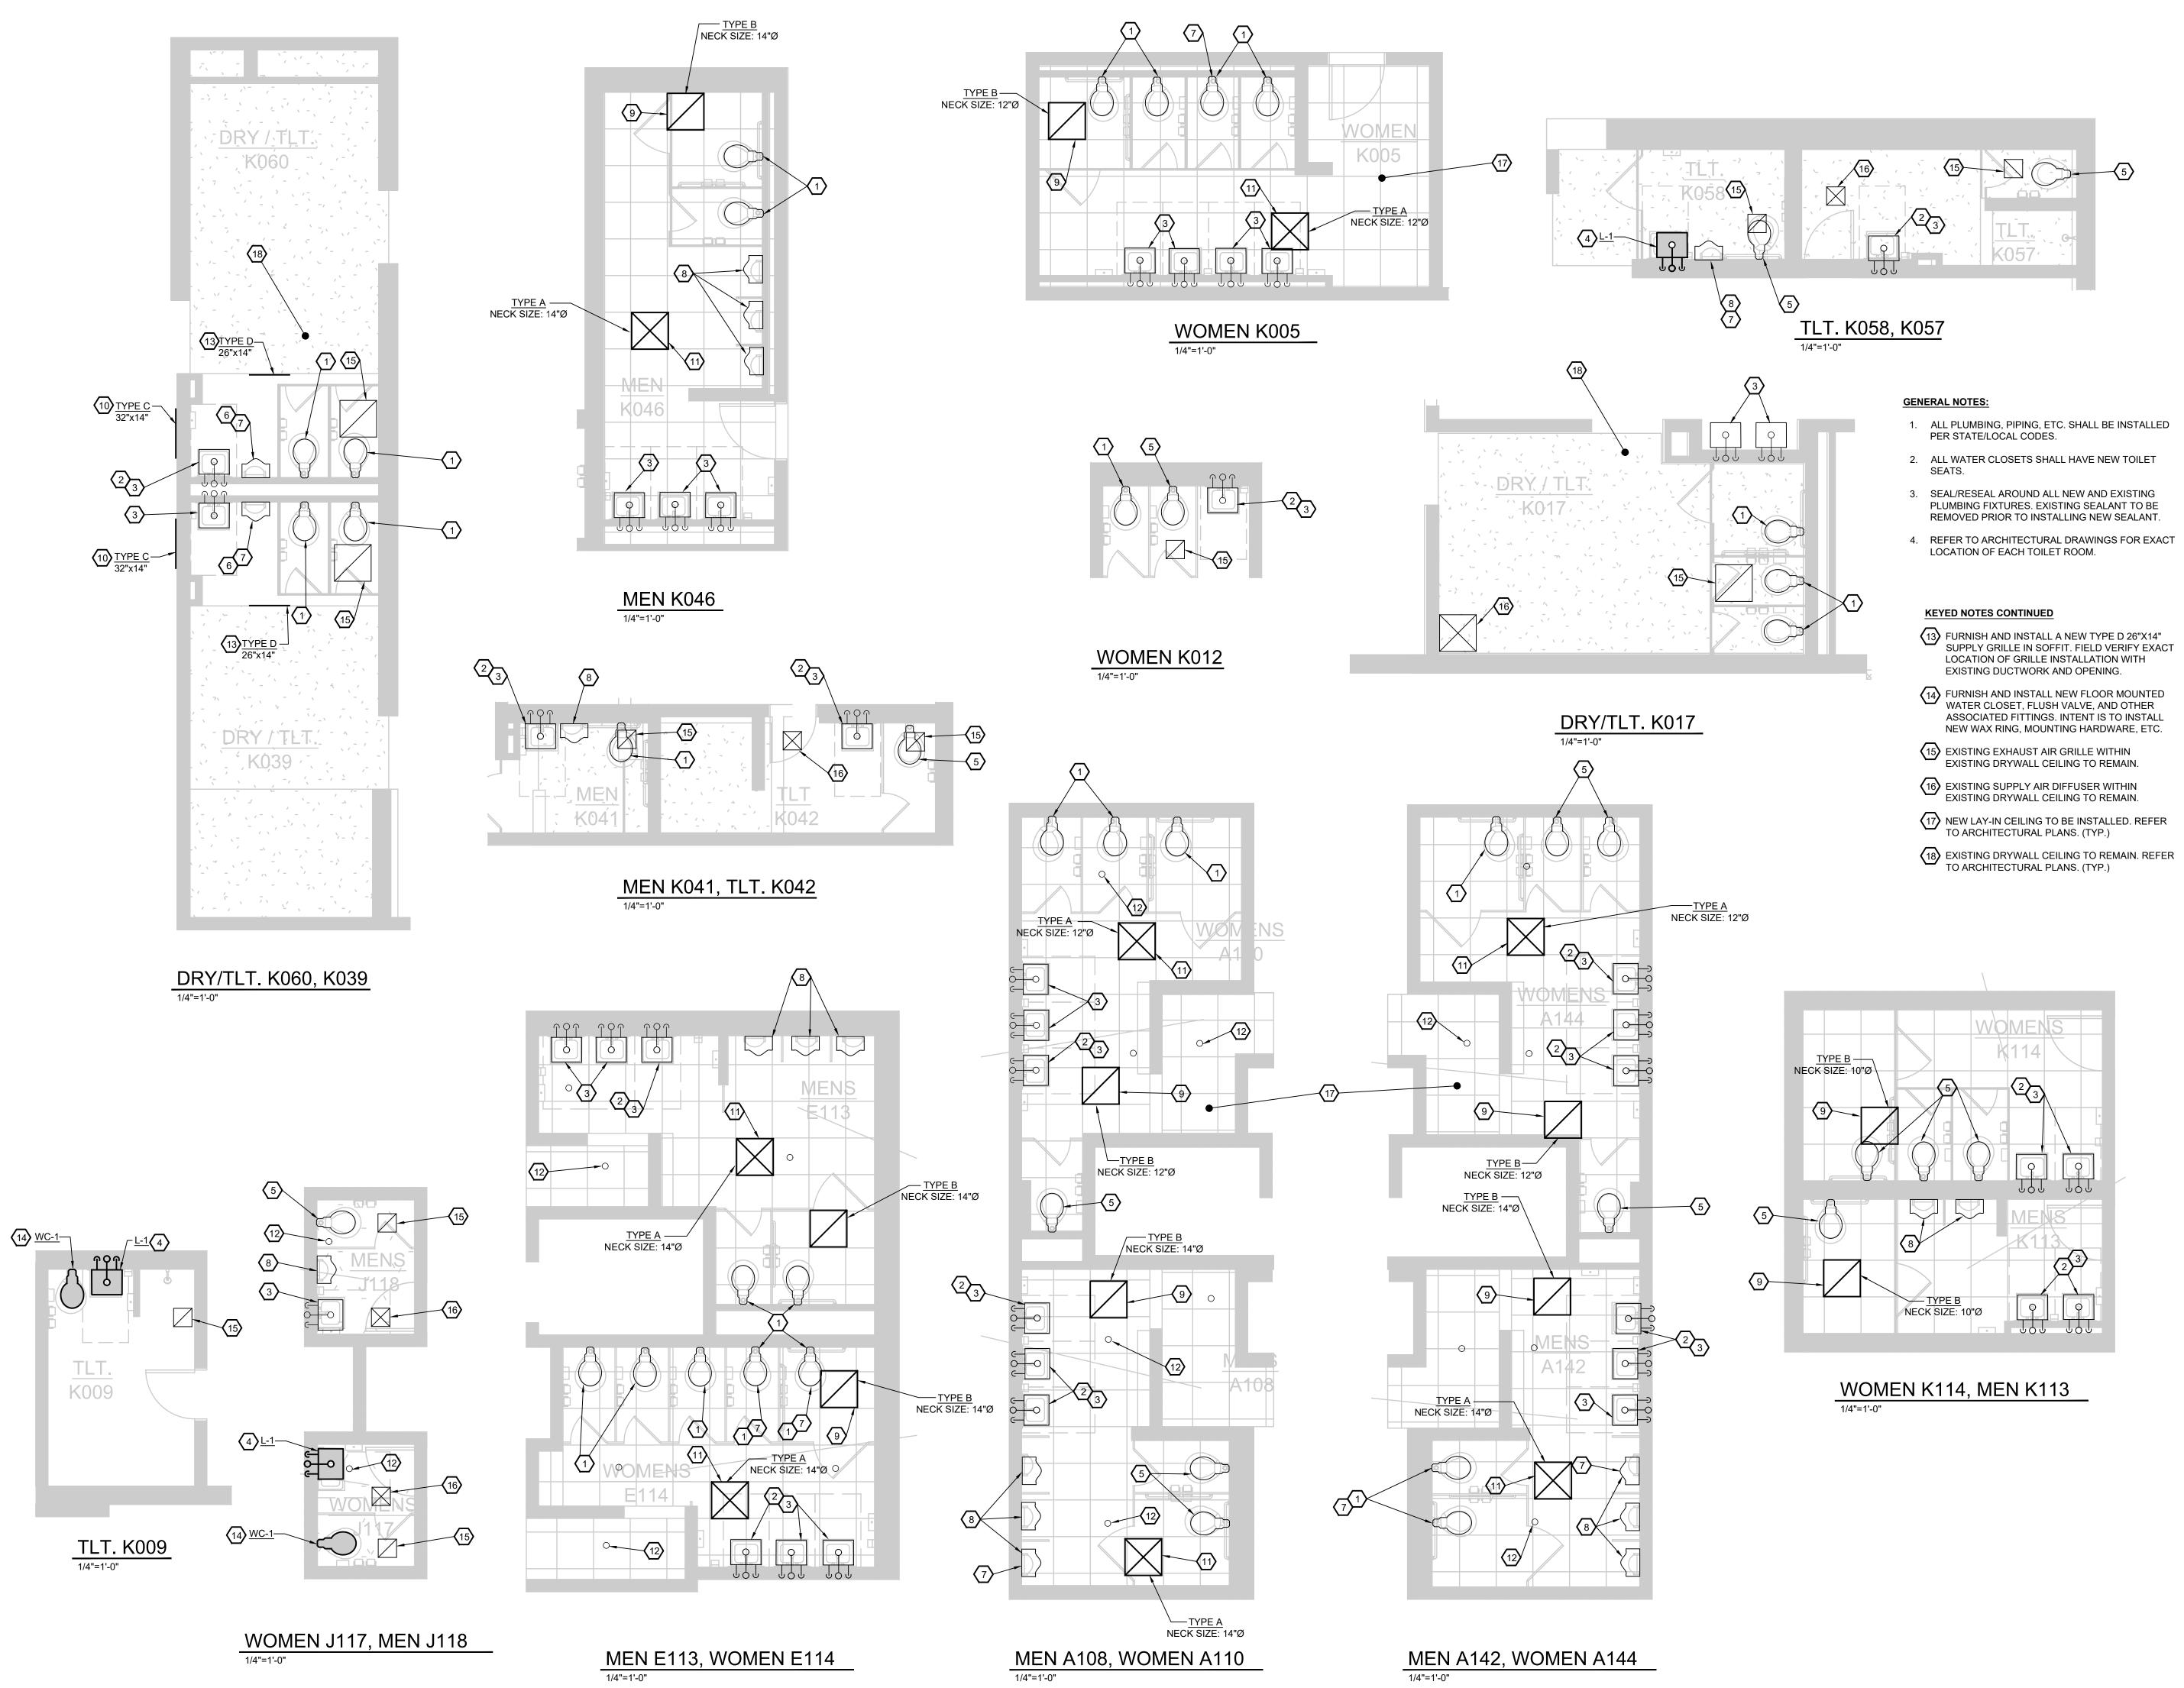

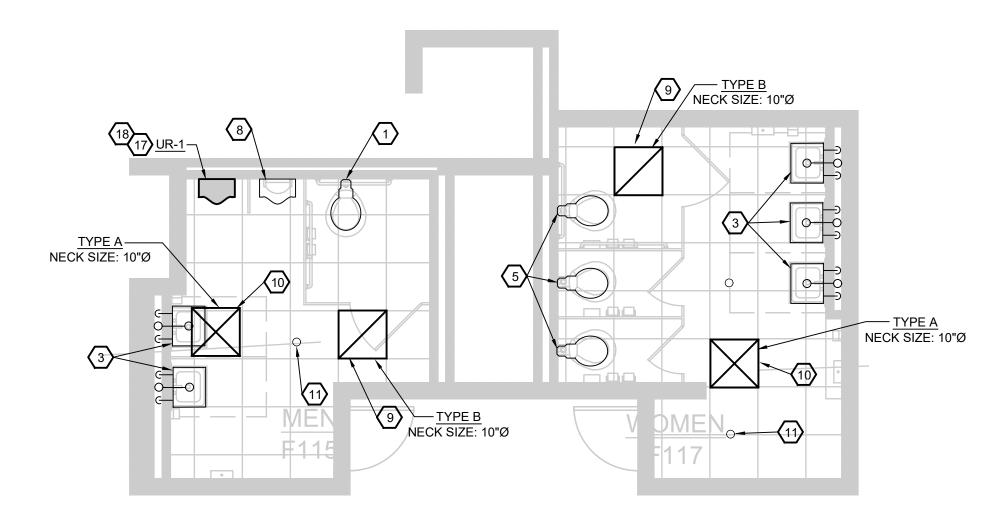

MEN A136, WOMEN A137



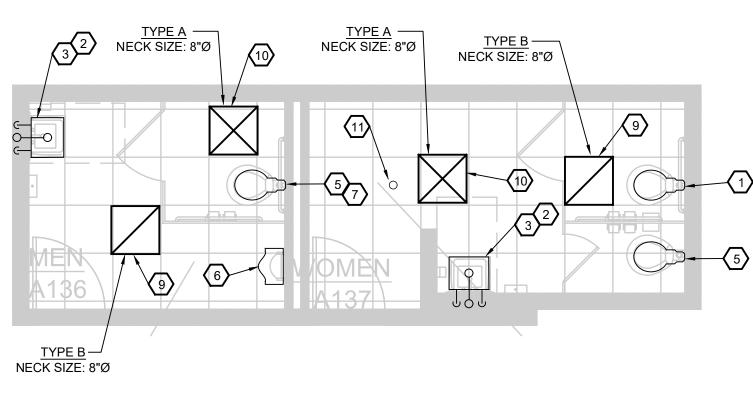

MEN A214, WOMEN A215 1/4"=1'-0"

### MEN E103, WOMEN E104

16

#### **GENERAL NOTES:**

- 1. ALL PLUMBING, PIPING, ETC. SHALL BE INSTALLED PER STATE/LOCAL CODES.
- 2. ALL WATER CLOSETS SHALL HAVE NEW TOILET SEATS.
- 3. SEAL/RESEAL AROUND ALL NEW AND EXISTING PLUMBING FIXTURES. EXISTING SEALANT TO BE REMOVED PRIOR TO INSTALLING NEW SEALANT.
- 4. REFER TO ARCHITECTURAL DRAWINGS FOR EXACT LOCATION OF EACH TOILET ROOM.


#### KEYED NOTES CONTINUED

- 12 FURNISH AND INSTALL NEW FLOOR MOUNTED WATER CLOSET, FLUSH VALVE, AND OTHER ASSOCIATED FITTINGS. INTENT IS TO INSTALL NEW WAX RING, MOUNTING HARDWARE, ETC.
- (13) EXISTING EXHAUST AIR GRILLE WITHIN EXISTING DRYWALL CEILING TO REMAIN.
- (14) EXISTING SUPPLY AIR GRILLE WITHIN EXISTING DRYWALL CEILING TO REMAIN.
- NEW LAY-IN CEILING TO BE INSTALLED. REFER TO ARCHITECTURAL PLANS. (TYP.)
- EXISTING DRYWALL CEILING TO REMAIN. REFER TO ARCHITECTURAL PLANE. (TYP.)
- TT FURNISH AND INSTALL NEW URINAL, FLUSH VALVE, AND OTHER ASSOCIATED FITTINGS, MOUNTING HARDWARE, ETC. INTENT IS TO PROVIDE AND INSTALL NEW CARRIED FOR URINAL AS NECESSARY.
- 18 FURNISH AND INSTALL NEW CARRIER FOR URINAL.

#### KEYED NOTES

- 1 REMOVE AND REINSTALL EXISTING WATER CLOSET FOR ABILITY TO SECURE EXISTING WATER CLOSET. WATER CLOSET IS LOOSE. INSTALL NEW WAX RING, NEW STUDS, AND NUTS AND REINSTALL EXISTING WATER CLOSET. REPLACE EXISTING WATER CLOSET SEAT WITH NEW SEAT TO MATCH EXISTING.
- 2 EXISTING LAVATORY IS LOOSE. EXISTING LAVATORY TO BE RESUPPORTED AS NECESSARY ON EXISTING CARRIER WITH NEW FASTENERS. INTENT IS TO REMOVE LAVATORY AS NECESSARY TO SECURE EXISTING LAVATORY TO EXISTING CARRIER.
- (3) EXISTING LAVATORY TO REMAIN. FURNISH AND INSTALL NEW FAUCET, PIPE PROTECTIVE COVERS, THERMOSTATIC MIXING VALVE, ANGLE STOP VALVES, GRID STRAINER AND ASSOCIATED FITTINGS TO BE ABLE TO REPLACE GRID STRAINER.
- 4 FURNISH AND INSTALL NEW LAVATORY, FAUCET, AND FITTINGS. CONNECT TO EXISTING PIPING. INTENT IS TO INSTALL NEW CARRIER WITH NEW LAVATORY AS NECESSARY FOR INSTALLATION OF NEW LAVATORY.
- 5 EXISTING WATER CLOSET TO REMAIN. REPLACE EXISTING WATER CLOSET SEAT WITH NEW SEAT TO MATCH EXISTING.
- $\langle 6 \rangle$  REMOVE AND REINSTALL EXISTING URINAL FOR ABILITY TO SECURE EXISTING URINAL. URINAL IS LOOSE. EXISTING URINAL TO BE RESUPPORTED WITH NEW FASTENERS. INTENT IS TO REMOVE EXISTING URINAL AS NECESSARY TO SECURE EXISTING URINAL TO EXISTING CARRIER.
- T FURNISH AND INSTALL NEW FLUSH VALVE ON EXISTING URINAL/WATER CLOSET.
- 8 EXISTING URINAL TO REMAIN.
- 9 APPROXIMATE LOCATION OF NEW EXHAUST AIR GRILLE TO BE INSTALLED. CLOSELY COORDINATE GRILLE LOCATION WITH ARCHITECTURAL CEILING PLANS, ELECTRICAL LIGHTING PLANS AND EXISTING DUCTWORK LOCATION(S). TRANSITION GRILLE NECK SIZE AS NECESSARY FOR CONNECTION TO EXISTING DUCTWORK. FIELD VERIFY EXACT SIZE AND LOCATION OF EXISTING DUCTWORK ABOVE CEILING.
- 10 APPROXIMATE LOCATION OF NEW SUPPLY AIR DIFFUSER TO BE INSTALLED. CLOSELY COORDINATE DIFFUSER LOCATION WITH ARCHITECTURAL CEILING PLANS, ELECTRICAL LIGHTING PLANS, AND EXISTING DUCTWORK LOCATION(S). TRANSITION DIFFUSER NECK SIZE AS NECESSARY FOR CONNECTION TO EXISTING DUCTWORK. FIELD VERIFY EXACT SIZE AND LOCATION OF EXISTING DUCTWORK.
- 11) APPROXIMATE LOCATION OF EXISTING FIRE PROTECTION SPRINKLER HEAD. FIELD VERIFY EXACT LOCATION OF EXISTING SPRINKLER HEAD. TYPICAL FOR ALL FIRE PROTECTION SPRINKLER HEADS.

	100% ISSUED FOR BID	10/28/24
NO.	REVERIEN	10/03/2024 DATE

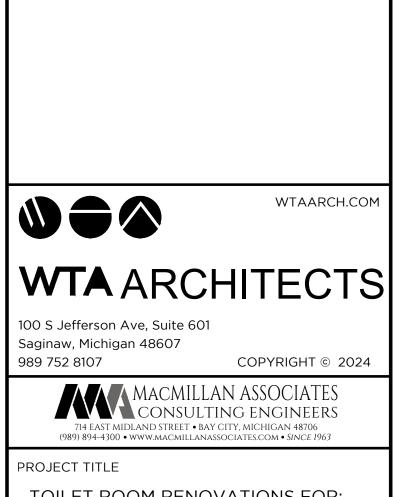

TOILET ROOM RENOVATIONS FOR: WESTERN HIGH SCHOOL

BAY CITY, MICHIGAN

- )	
SHEET TITLE	
ENLARGED PLANS -	
MECHANICAL REVISED	

PROJECT NUMBER 2019113.3 PROJECT DATE 2024

SHEET NUMBER

M2.02

CHECKED BY GRS

#### GENERAL MECHANICAL NOTES

- 1. THE MECHANICAL TRADES SHALL FAMILIARIZE THEMSELVES WITH ALL EXISTING AND NEW CONDITIONS, THESE DRAWINGS, ADDENDA & RELATED SPECIFICATIONS. THEY SHALL COMPLETELY SATISFY THEMSELVES AS TO THE CONDITIONS TO WHICH THE WORK IS TO BE PERFORMED BEFORE SUBMITTING THEIR BID. NO ALLOWANCES OR CONSIDERATIONS WILL BE GIVEN AT A LATER DATE FOR ALLEGED MISUNDERSTANDINGS AS TO THE REQUIREMENTS OF THE WORK, MATERIALS TO BE FURNISHED, OR CONDITIONS REQUIRED BY THE NATURE OF THIS PROJECT SITE DUE TO NEGLECT ON THE BIDDERS PART TO MAKE SUCH AN EXAMINATION AND COORDINATION.
- 2. DRAWINGS ARE DIAGRAMMATIC AND ARE INTENDED TO SHOW APPROXIMATE LOCATION AND GENERAL ARRANGEMENT OF SYSTEMS AND EQUIPMENT. DRAWINGS SHALL NOT BE SCALED FOR LOCATION OF SYSTEMS, EQUIPMENT, ETC. ALL LOCATIONS OF SYSTEMS AND EQUIPMENT SHALL BE VERIFIED IN FIELD AND COORDINATED WITH ALL OTHER TRADES AND EXISTING FIELD CONDITIONS. SOME SYSTEMS (PIPING, DUCTWORK, ETC.) AND EQUIPMENT LOCATIONS MAY REQUIRE CHANGES IN LOCATION DUE TO FIELD CONDITIONS AND COORDINATION WITH OTHER TRADES. THESE CHANGES SHALL BE MADE WITH NO ADDITIONAL COST TO THE OWNER. FAILURE TO VERIFY AND COORDINATE WILL BE NO REASON FOR ADDITIONAL COMPENSATION.
- 3. THE INSTALLATION OF ALL SYSTEMS, EQUIPMENT, ETC., IS SUBJECT TO CLARIFICATION WITH SUBMITTED SHOP DRAWINGS AND FIELD COORDINATION REQUIREMENTS. EQUIPMENT OUTLINES SHOWN ON DRAWINGS OR DIMENSIONED ON DRAWINGS ARE LIMITING DIMENSIONS. ANY EQUIPMENT THAT REDUCES THE INDICATED CLEARANCES OR EXCEEDS SPECIFIED OR SCHEDULED EQUIPMENT DIMENSIONS SHALL NOT BE USED.
- 4. THE MECHANICAL CONTRACTOR SHALL COORDINATE FINAL LOCATION OF ALL EQUIPMENT WITH PIPING, DUCTWORK, ETC., AT THE TIME OF ROUGH-IN. ALL EQUIPMENT TO BE SERVICEABLE. ABOVE CEILING EQUIPMENT SHALL BE WITHIN 18" OF CEILING WITHOUT ANY OBSTRUCTIONS AND SHALL HAVE ALL SERVICE AND ACCESS SPACES KEPT CLEAR. PERFORM ABOVE CEILING COORDINATION WITH ALL TRADES.
- 5. THESE DRAWINGS AND THE ASSOCIATED SPECIFICATIONS ARE INTENDED TO PROVIDE COMPLETELY FURNISHED, INSTALLED AND OPERATIONAL MECHANICAL SYSTEM (HEATING, VENTILATING, AIR CONDITIONING, PLUMBING AND PIPING, ETC.). IF THESE DRAWINGS AND ASSOCIATED SPECIFICATIONS HAVE INFORMATION OMITTED THAT WOULD NOT ALLOW A COMPLETELY OPERATIONAL SYSTEM AS IS THE INTENT OF THE ENGINEER, THE BIDDER SHALL NOTIFY THE ENGINEER A MINIMUM ONE WEEK PRIOR TO THE BID DATE TO ALLOW FOR ADDENDA. ONCE BIDS HAVE BEEN RECEIVED, THE CONTRACTOR SHALL BE RESPONSIBLE FOR ALL MATERIAL, LABOR, ETC., TO FURNISH AND INSTALL A COMPLETELY OPERATIONAL MECHANICAL SYSTEM AS IS THE INTENT OF THESE DRAWINGS AND ASSOCIATED SPECIFICATION. ALL EQUIPMENT SHALL BE INSTALLED PER MANUFACTURER'S INSTRUCTIONS. IF ANY DISCREPANCIES ARE ON DRAWINGS, AS COMPARED TO MANUFACTURER'S INSTALLATION INSTRUCTIONS, THE CONTRACTOR SHALL NOTIFY THE ENGINEER AND INSTALL EQUIPMENT AS REQUIRED AT NO ADDITIONAL COST TO THE PROJECT.
- 6. THE MECHANICAL TRADES SHALL TAKE OUT ALL PERMITS AND ARRANGE FOR NECESSARY INSPECTIONS AND SHALL PAY ALL FEES AND COSTS.
- 7. THE MECHANICAL TRADES SHALL VERIFY AMOUNT OF EXISTING PIPING, VALVES, DUCTWORK, ETC. TO BE REMOVED OR RELOCATED TO ALLOW FOR INSTALLATION OF NEW PIPING, DUCTWORK, VALVES, EQUIPMENT, WALLS, ETC. ALL ABANDONED PIPING, VALVES, ETC., SHALL BE REMOVED.
- 8. THE MECHANICAL TRADES SHALL COORDINATE ALL WORK WITH OTHER TRADES AND SHALL COORDINATE ANY SYSTEMS SHUT-DOWN WITH THE ARCHITECT/ENGINEER AND OWNER.
- 9. ALL EXISTING EQUIPMENT, PIPING, DUCTWORK, ETC. THAT IS TO BE REMOVED SHALL REMAIN THE PROPERTY OF THE OWNER. THE CONTRACTOR SHALL REMOVE AND LOCATE THIS MATERIAL THAT REMAINS THE PROPERTY OF THE OWNER TO A LOCATION DETERMINED BY THE OWNER SOMEWHERE ON SITE. IF THE OWNER DOES NOT WANT TO MAINTAIN POSSESSION OF THE REMOVED MATERIAL, THE CONTRACTOR SHALL BE RESPONSIBLE FOR REMOVING MATERIAL FROM THE SITE AND DISPOSING OF THIS MATERIAL AS NECESSARY TO MEET ALL CODES AND REQUIREMENTS AND SHALL PAY ALL COSTS AS REQUIRED FOR ANY DISPOSAL FEES, INSPECTIONS, PERMITS, ETC.
- 10. ATTACHMENTS OF MECHANICAL OR ELECTRICAL EQUIPMENT TO STRUCTURAL MEMBERS ARE THE RESPONSIBILITY OF THE INSTALLING TRADE. STRUCTURAL MEMBERS SHALL NOT BE FIELD CUT, WELDED OR OTHERWISE MODIFIED WITHOUT APPROVAL OF THE ARCHITECT/ENGINEER. ATTACHMENT TO STEEL JOISTS SHALL BE MADE AT PANEL POINTS WHENEVER POSSIBLE. STEEL JOISTS SHALL BE REINFORCED FOR NON-PANEL POINT CONCENTRATED LOADS IN ACCORDANCE WITH THE STRUCTURAL DETAILS; THIS WORK SHALL BE PERFORMED BY CERTIFIED WELDERS AND IS THE RESPONSIBILITY OF THE TRADE INSTALLING THE SUBJECT LOAD. STRUCTURAL MEMBERS SHALL NOT BE OVERLOADED AS A RESULT OF ATTACHMENTS. ATTACHMENT/EQUIPMENT LOADING FOR ALL TRADES RESULTING IN TOTAL LOAD GREATER THAN AN EQUIVALENT UNIFORM 5 PSF FOR ANY MEMBER SHALL BE SUBMITTED TO THE ARCHITECT/ENGINEER FOR REVIEW.
- 11. THE MECHANICAL TRADES SHALL FURNISH AND LOCATE CEILING AND/OR WALL ACCESS DOORS AS REQUIRED TO GIVE ACCESS TO VALVES, EQUIPMENT, ETC. COORDINATE WALL OR CEILING FIRE RATINGS AND FURNISH ACCESS DOOR WITH RATING AS NECESSARY. THE GENERAL TRADES SHALL INSTALL ACCESS DOORS.

### EQUIPMENT MANUFACTURERS AND MATERIALS SPECIFIED OR SCHEDULED ON THESE PROJECT

DRAWINGS AND SPECIFICATIONS SHALL BE INCLUDED UNDER THE BASE BID PRICE. SUBSTITUTE OR ALTERNATE EQUIPMENT SHALL BE PRICED AS AN ADD OR DEDUCT PRICE TO THE CONTRACTOR'S BASE BID PRICE. IF ONE OR MORE SUBSTITUTIONS ARE ACCEPTED WITH THE PROPOSAL AT THE CORRESPONDING ALTERNATE PRICE, IT SHALL BE UNDERSTOOD THAT APPROVAL OF SAID EQUIPMENT SHALL BE SUBJECT TO STRICT ADHERENCE TO THE PLANS AND SPECIFICATIONS. SHOULD ANY OF THE SUBSTITUTE EQUIPMENT FAIL TO MEET THE SPECIFICATIONS AFTER THE PROPOSAL HAS BEEN ACCEPTED, REGARDLESS IF EQUIPMENT HAS BEEN SHIPPED TO THE SITE AND INSTALLED, THE CONTRACTOR SHALL FURNISH AT NO EXTRA COST TO THE OWNER, THE SPECIFIED EQUIPMENT MEETING THE REQUIREMENTS AS STATED IN THESE SPECIFICATIONS AND COVER ALL COSTS NECESSARY FOR REMOVAL AND REINSTALLATION OF EQUIPMENT.

SPECIFIED AND SCHEDULED EQUIPMENT NOTE

#### PLUMBING FIXTURE SCHEDULE

TAG/ DESCRIPTION	MANUFACTURER	MODEL #	
WC-1	AMERICAN STANDARD	3043.001	FLOOR MOUNTED FLUSH VALVE WATER CLOSET (BARRIER FREE): A SAVER TOILET WITH SIPHON JET ACTION, ELONGATED BOWL, WHITE INCLUDE ZURN Z-6000AV-WS1 FLUSH VALVE WITH VACUUM BREAKE OF SEAT ABOVE FINISHED FLOOR FOR BARRIER FREE USE, BOLT CA VALVE SHALL BE MOUNTED ON THE WIDE SIDE OF TOILET AREA. TH FIXTURE AS REQUIRED TO MATCH EXISTING ROUGH-INS. CONTRACT ORDERING NEW WATER CLOSET.
L-1	AMERICAN STANDARD	0356.012	WALL HUNG LAVATORY, LUCERNE, NOMINAL 20"X18" WHITE VITREOU 4" ON CENTER HOLES CONSTRUCTED FOR CONCEALED ARM CARRI LISTED UNDER EACH LAVATORY AND ADJUST TO 105 DEGREE HOT V FAUCET WITH RIGID SPOUT, SINGLE LEVER MANUAL FAUCET WITH F HANDLE STOPS AND TAILPIECE, ALL POLISHED CHROME FINISH, UNIT SUPPORT, ETC.
UR-1	AMERICAN STANDARD	6590.001	WALL HUNG. WASHBROOK URINAL WITH EVERCLEAN, WHITE VITRED THREADED 2" FEMALE, 1.0 GALLON PER FLUSH. CONTROL FOR FLUS INCLUDE ZURN Z-6003AV-WS1 FLUSH VALVE WITH VACUUM BREAKE
UNDER LAVATORY PROTECTIVE PIPE COVERS	ZURN	Z8946	TRAP AND STOP/RISER INSULATED COVERS SHALL BE FURNISHED ADA REQUIREMENTS. THIS SHALL INCLUDE DRAIN, CW AND HW PIP
THERMOSTATIC MIXING VALVE		ASSE 1070	THERMOSTATIC MIXING VALVE SHALL BE FURNISHED AND INSTALLED VALVE SHALL BE LISTED ASSE 1070, 1/2" SIZE WITH STRAINER AND CH WATER AT FAUCET.
4" CENTERSET FAUCET	ZURN	Z7440-XL	ZURN Z-7440-XL CENTERSET FAUCET WITH RIGID SPOUT, SINGLE LEVE DRAIN, P-TRAP, WHEEL HANDLE STOPS AND TAILPIECE, ALL POLISHED VALVE THAT IS ASSE 1070 LISTED UNDER EACH LAVATORY AND ADJUS EXACT FAUCET QUANTITIES AND SIZES PRIOR TO ORDERING. FAUCET
8" CENTERSET FAUCET	ZURN	Z831R1-XL	ZURN #Z831R1-XL POLISHED CHROME PLATE WIDESPREAD LAVATORY CODED METAL LEVERS, MOUNTING HARDWARE, AND QUARTER TURN PROTECTIVE COVERS, GRID DRAIN, P-TRAP, LOOSE KEY STOPS, ALL P LISTED UNDER EACH LAVATORY AND ADJUST TO 105 DEGREE HOT WA AND SIZES PRIOR TO ORDERING. FAUCET SIZE SHALL BE DETERMINED
WATER CLOSET FLUSH VALVE	ZURN	Z-6000-AV-WS1	ZURN Z-6000AV-WS1 FLUSH VALVE WITH VACUUM BREAKERS. CONTRA GALLONS PER FLUSH PRIOR TO ORDERING FLUSH VALVE. VACUUM TU
URINAL FLUSH VALVE	ZURN	Z-6003-AV-WS1	ZURN Z-6003AV-WS1 FLUSH VALVE WITH VACUUM BREAKER. CONTRAC PER FLUSH PRIOR TO ORDERING FLUSH VALVE. FLUSH VALVE SIZE AN
WATER CLOSET SEAT	ZURN	Z5956SS-EL-AM-STS	ZURN ELONGATED, EXTRA HEAVY DUTY, PREMIUM WHITE, OPEN FROM
ANGLE STOP VALVE	ZURN	Z8804-XL-LK-PC	ZURN CHROME PLATED, SOLID BRASS ANGLE STOP COMPRESSION TO

	GRILLE, REGISTER, AND DIFFUSER SCHEDULE					
	ТҮРЕ					
REF	SERVICE AND TYPE	MODEL NUMBERS	DEFLECTION	NECK SIZE	REMARKS	
A	CEILING SUPPLY AIR DIFFUSER	PRICE SMDA OR EQUAL TITUS	4 WAY	0-125 CFM: 6" x 6" (6" DIA) / 126-250 CFM: 9" x 9" (8" DIA) / 251-350 CFM: 12" x 12" (10" DIA) / 351-450 CFM: 12" x 12" (12" DIA) / 451-600 CFM: 15" x 15" (14" DIA) / 601-900 CFM: 18" x 18" (16" DIA)	ALL STEEL CONSTRUCTION, ADJUSTABLE HORIZONTAL TO VERTICAL AIRFLOW PATTERN, 24X24, BAKED ON ENAMEL FINISH WITH COLOR SELECTED BY ARCHITECT. FRAME AS REQUIRED FOR CEILING TYPE WITH DIFFUSER PANEL SHALL MATCH GRID SIZE WHERE INSTALLED IN LAY IN CEILING. MAXIMUM NECK VELOCITY SHALL BE 700 FPM AND MAXIMUM NC LEVEL SHALL BE 25.	
В	CEILING EXHAUST AIR GRILLE	PRICE 80F OR EQUAL TITUS	EGGCRATE	0-125 CFM: 6" x 6" (6" DIA) / 126-250 CFM: 9" x 9" (8" DIA) / 251-350 CFM: 12" x 12" (10" DIA) / 351-450 CFM: 12" x 12" (12" DIA) / 451-600 CFM: 15" x 15" (14" DIA) / 601-900 CFM: 18" x 18" (16" DIA) / 901-1200 CFM: 21" x 21"	ALL STEEL CONSTRUCTION, BAKED ON ENAMEL FINISH WITH COLOR SELECTED BY ARCHITECT. FRAME AS REQUIRED FOR CEILING TYPE. DIFFUSER PANEL SHALL MATCH GRID SIZE WHERE INSTALLED IN LAY IN CEILING. MAXIMUM NECK VELOCITY SHALL BE 700 FPM AND MAXIMUM NC LEVEL SHALL BE 25.	
с	WALL EXHAUST AIR GRILLE	PRICE 530L OR EQUAL TITUS	SINGLE DEFLECTION	SEE DRAWINGS FOR SIZES	ALL STEEL CONSTRUCTION, SINGLE DEFLECTION BLADES, 35 DEGREE HORIZONTAL FRONT BLADES, BAKED ON ENAMEL FINISH WITH COLOR SELECTED BY ARCHITECT.	
D	WALL SUPPLY AIR GRILLE	PRICE 520L OR EQUAL TITUS	DOUBLE DEFLECTION	SEE DRAWINGS FOR SIZES	ALL STEEL CONSTRUCTION, DOUBLE DEFLECTION BLADES, ADJUSTABLE HORIZONTAL FRONT BLADES, ADJUSTABLE VERTICAL REAR BLADES, BAKED ON ENAMEL FINISH WITH COLOR SELECTED BY ARCHITECT. IF GRILLE SIZE REQUIRES 2 SECTIONS, DECREASE WIDTH OF TRIM AT JOINT AS MUCH AS POSSIBLE.	

(1) BRANCH DUCT	
2 TRANSITION	
3 DAMPER WITH POSITIVE LOCKING WING NUT	
4 FLEXIBLE INSULATED	
DUCT SIMILAR TO FLEXMASTER TYPE 3 OR APPROVED EQUAL	
MAXIMUM 5'-0" LENGTH	
$\left< \frac{5}{2} \right>$ DIFFUSER OR GRILLE W/ ROUND NECK OR SQUARE TO ROUND NECK ADAPTER	
6 LAY-IN CEILING	
7 TAKE-OFF FITTING SIMILAR TO FLEXMASTER	
MODEL #CB-D CONICAL BELL MOUTH FITTING WITH DAMPER AND POSITIVE LOCKING WING NUT	

NO SCALE

#### NOTES

AMERICAN STANDARD #3043.001 MADERA FLOWISEA.D.A. EL 1.6, 16 1/2" HIGH WATER TE VITREOUS CHINA, 1 1/2" TOP SPUD, 1.6 GALLONS PER FLUSH. FITTINGS SHALL ER, CENTOCO 1500 CC WHITE OPEN FRONT SEAT, LESS COVER, TO GIVE 17" HIGH TOP CAPS, ETC. INSTALLATION SHALL MEET A.D.A. REQUIREMENTS. CONTROL FOR FLUSH HE CONTRACTOR SHALL VERIFY EXISTING ROUGH-INS IN FIELD AND PROVIDE NEW CTOR SHALL VERIFY AND MATCH HEIGH OF EXISTING WATER CLOSET IN FIELD BEFORE

OUS CHINA, FRONT OVERFLOW, FAUCET LEDGE, "D" SHAPED BOWL, SELF DRAINING DECK, RIER AND ADA COMPLIANT. INSTALL THERMOSTATIC MIXING VALVE THAT IS ASSE 1070 FWATER MAXIMUM AT FAUCET. FITTINGS SHALL INCLUDE ZURN Z-7440-XL CENTERSET I RIGID SPOUT AND COLOR INDEXES, 0.5 GPM FLOW DEVICE, GRID DRAIN, P-TRAP, WHEEL NDERSINK PROTECTIVE PIPE COVERS, ZURN CONCEALED ARM CARRIER WITH FLOOR

EOUS CHINA WASH OUT WATER SAVER URINAL WITH 3/4" TOP INLET SPUD, OUTLET JSH VALVE SHALL BE MOUNTED ON THE WIDE SIDE OF THE TOILET AREA. FITTINGS SHALL ER, ZURN CONCEALED ARM CARRIER WITH FLOOR SUPPORT.

O AND INSTALLED ON ALL EXPOSED PIPING AND VALVES BELOW LAVATORIES TO MEET PING, FITTINGS, VALVES, ETC.

D UNDER EACH NEW LAVATORY, HAND SINK, COUNTERTOP SINK AND SIMILAR FIXTURES. HECK-STOPS. PIPE TO HOT WATER SIDE OF FAUCET AND ADJUST TO PROVIDE 105F HOT

VER MANUAL FAUCET WITH RIGID SPOUT AND COLOR INDEXES, 0.5 GPM FLOW DEVICE, GRID ED CHROME FINISH, UNDERSINK PROTECTIVE PIPE COVERS. INSTALL THERMOSTATIC MIXING JST TO 105 DEGREE HOT WATER MAXIMUM AT FAUCET. CONTRACTOR SHALL FIELD VERIFY ET SIZE SHALL BE DETERMINED ON A CASE-BY-CASE BASIS.


RY FAUCET WITH 8" CENTERSET, BRASS LOW PROFILE SPOUT, VANDAL-RESISTANT COLOR N CERAMIC DISC CARTRIDGES, 0.5 GPM FLOW DEVICE, SOLENOID VALVE, UNDERSINK PIPE POLISHED CHROME FINISH. INSTALL THERMOSTATIC MIXING VALVE THAT IS ASSE 1070 ATER MAXIMUM AT FAUCET. CONTRACTOR SHALL FIELD VERIFY EXACT FAUCET QUANTITIES ED ON A CASE-BY-CASE BASIS.

RACTOR SHALL FIELD VERIFY EXACT VACUUM TUBE HEIGHT, FLUSH VALVE SIZE, AND UBE HEIGHT SHALL BE DETERMINED ON A CASE-BY-CASE BASIS.

ACTOR SHALL FIELD VERIFY EXACT FLUSH VALVE SIZE, VACUUM TUBE HEIGHT, AND GALLONS ND VACUUM TUBE HEIGHT SHALL BE DETERMINED ON A CASE-BY-CASE BASIS.


ONT TOILET SEAT, LESS COVER, WITH STAINLESS STEEL CHECK HINGE.

TO COMPRESSION FITTING WITH LOOSE KEY.

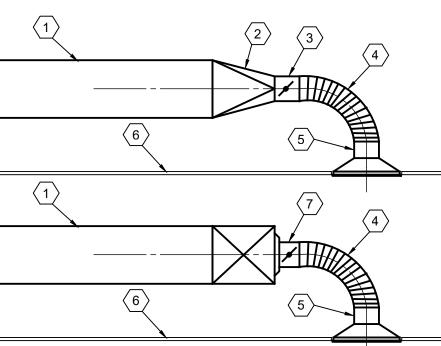


### BRANCH DUCT CONNECTION TO DIFFUSER OR GRILLE DETAIL


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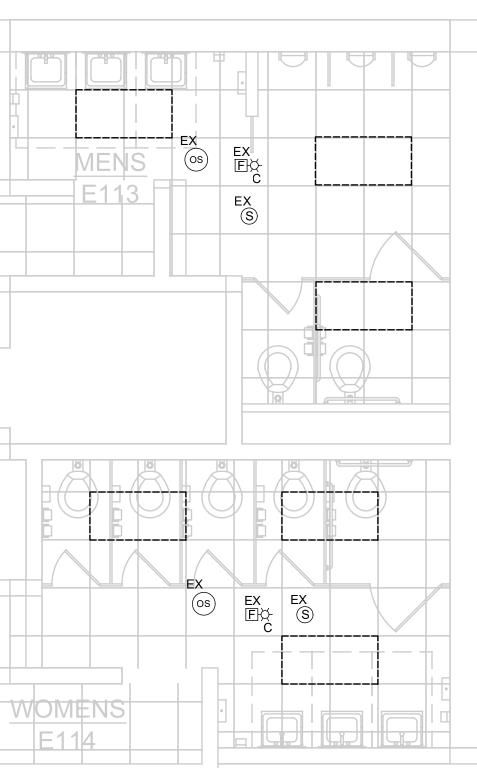


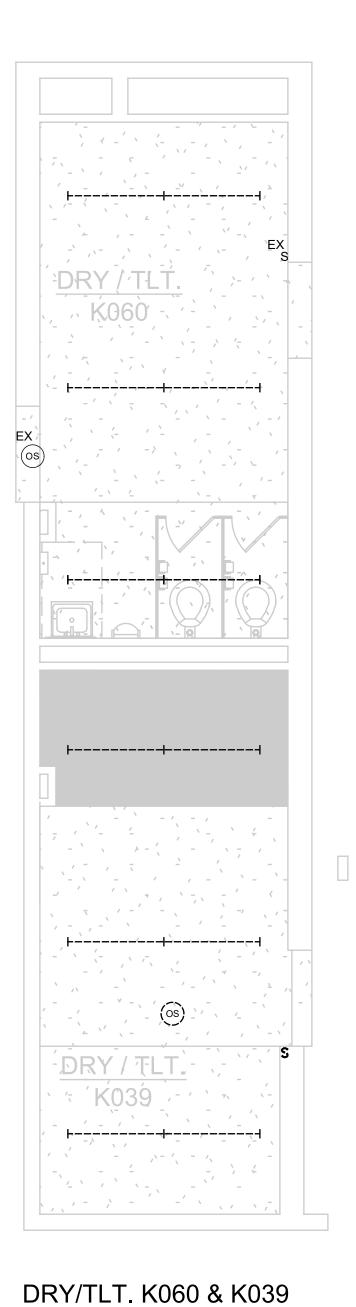
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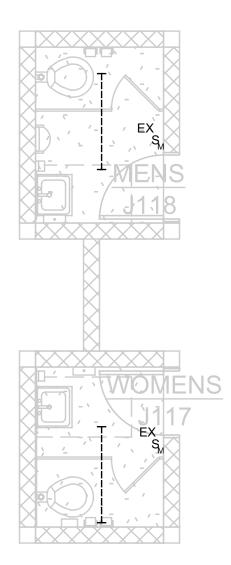








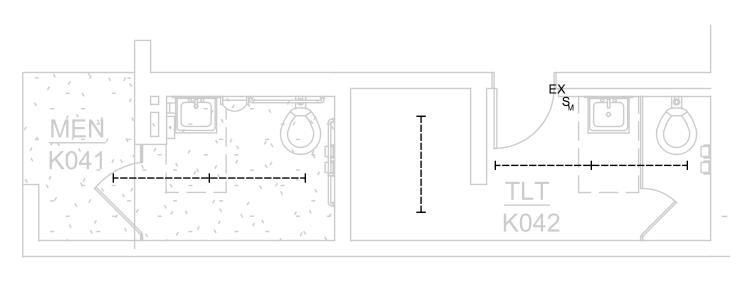

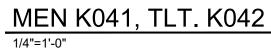

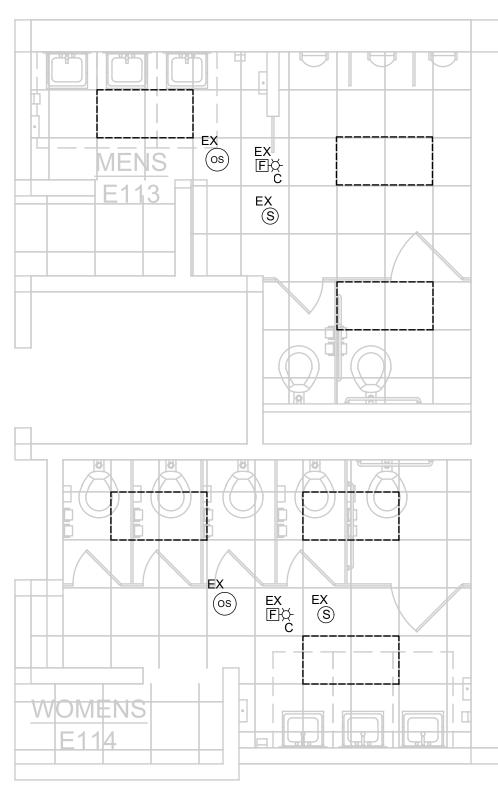


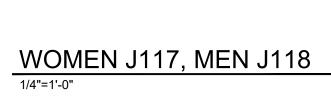

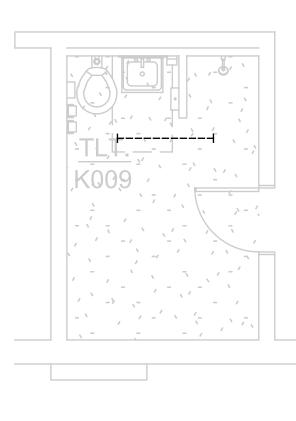


1/4"=1'-0"

TLT K009

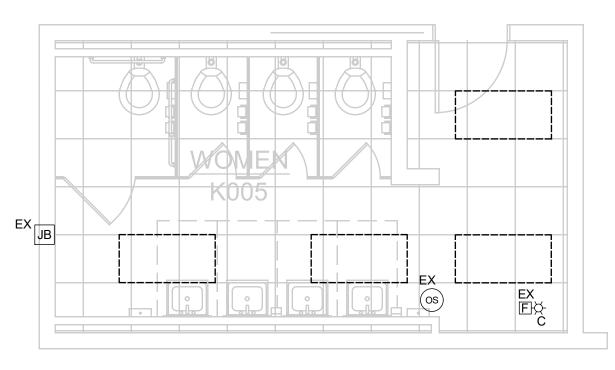


WOMEN K005 1/4"=1'-0"

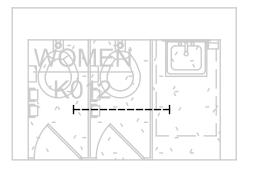

WOMEN K012 1/4"=1'-0"


MEN E113, WOMEN E114 1/4"=1'-0"

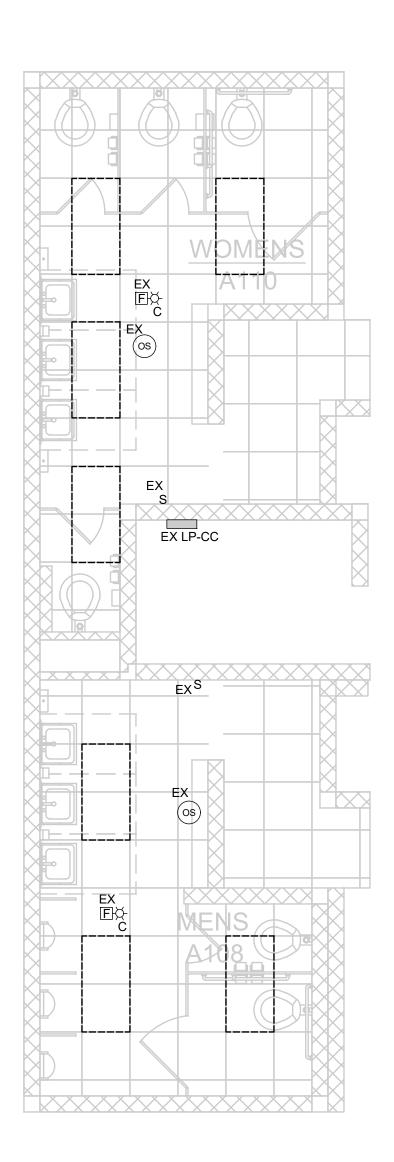

MEN A108, WOMEN A110 1/4"=1'-0"





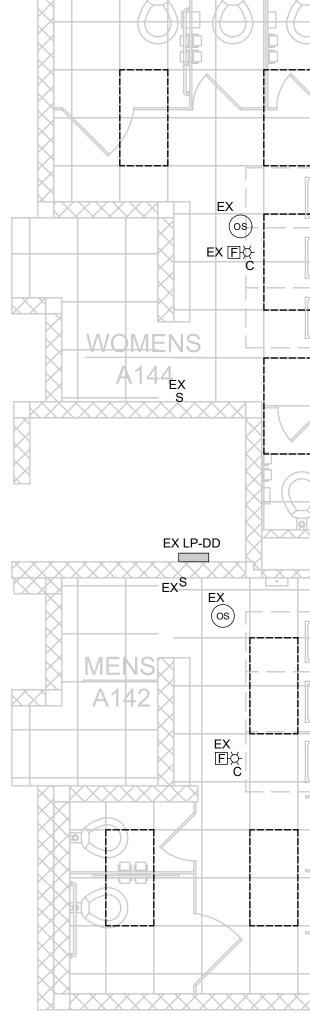

MEN A142, WOMEN A144 1/4"=1'-0"

		FIE	LD CONFIRM EXACT LO	CATION.	
		ITE	SHED LINES SHOWN ON MS SHOWN TO BE REM HERWISE.		
		3. ELI RE ELI IS	ECTRICAL CONTRACTO MOVE ALL LIGHT FIXTU ECTRICAL EQUIPMENT / TO RE-USE EXISTING LC R NEW BATHROOM FIXT	RES AND ASSO AS NEEDED. DE DCAL LIGHTING	CIATED SIGN INTENT
<u>,</u> K058		EX FR AN	E ALARM SYSTEM IS EX STING DEVICES SHALL OM EXISTING CEILING, <sup>-</sup> D REINSTALLED IN THE CATION.	BE PROTECTED	D, REMOVED SUPPORTED,
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	DRY/TLT. K017 <sup>1/4"=1'-0"</sup>				
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		989 75		LAN ASSOCI TING ENGIN ay city, michigan 48	IEERS <sup>8706</sup>
	WOMEN K114, MEN K113 1/4"=1'-0"	тоі	CT TITLE LET ROOM RENCE ESTERN HIC		
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GENERAL DEMOLITION NOTES


DEVICE LOCATIONS ARE SHOWN DIAGRAMMATICAL.

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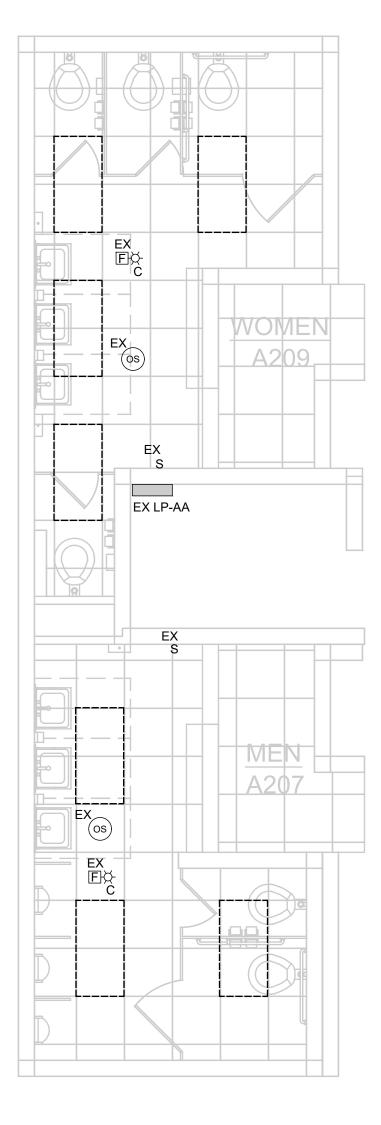



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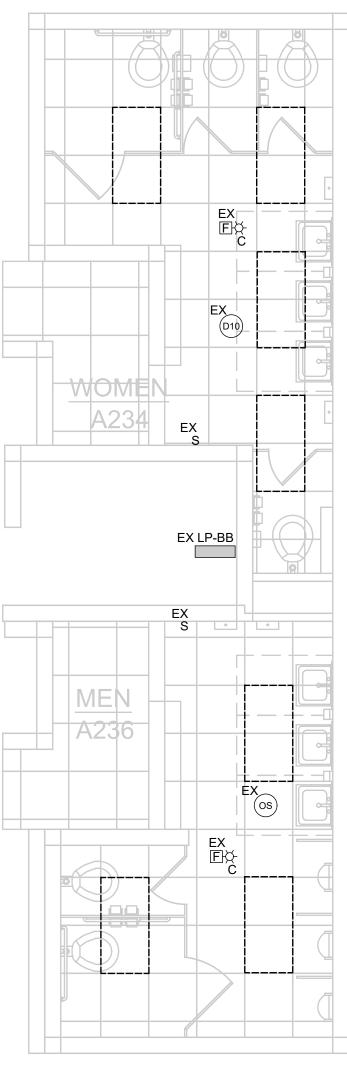
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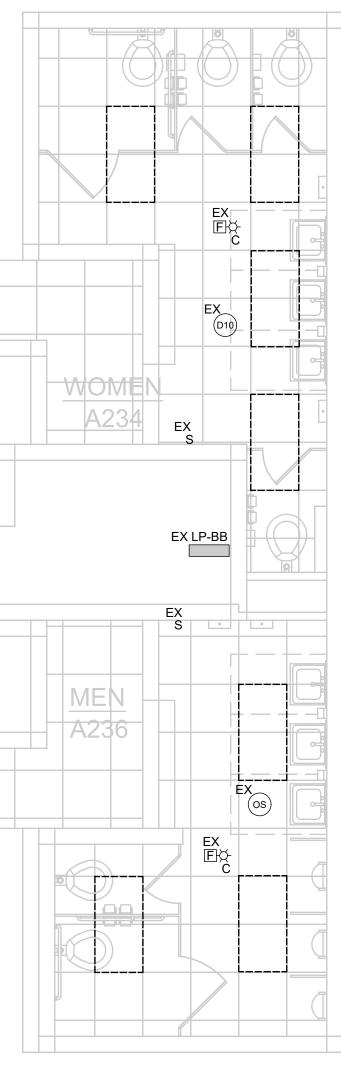


MEN F115, WOMEN F117




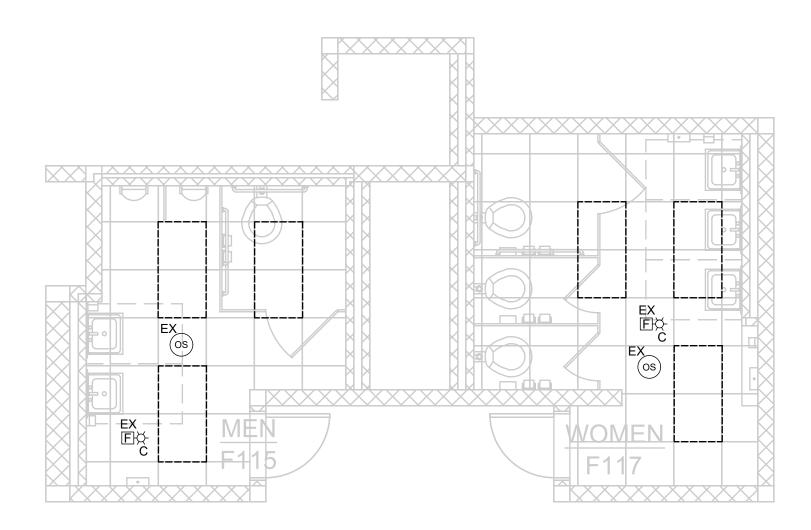




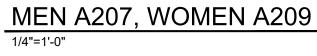


1/4"=1'-0"

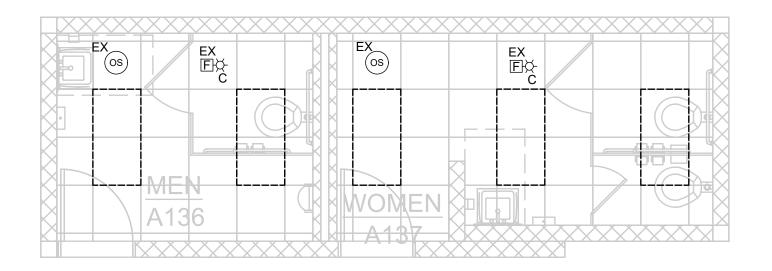

MEN A136, WOMEN A137

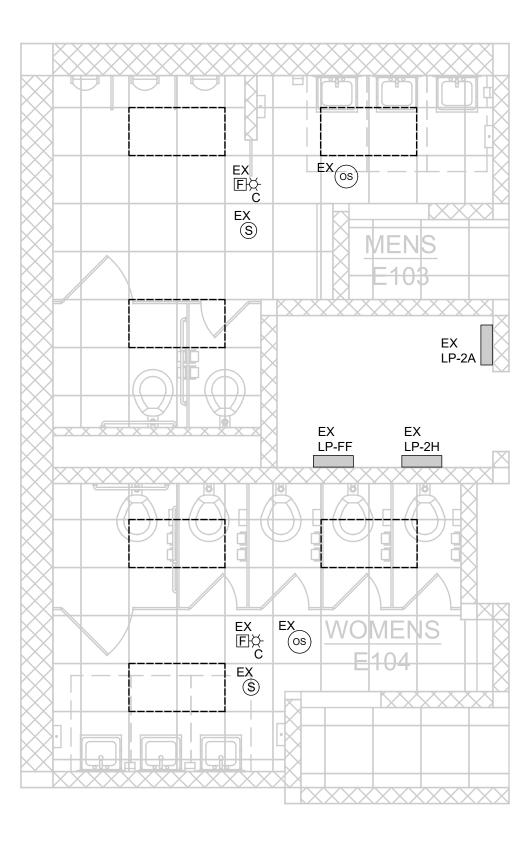

1/4"=1'-0"

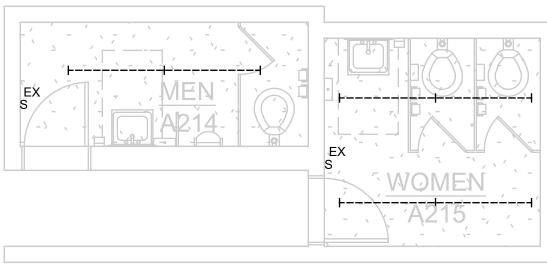

MEN A214, WOMEN A215 1/4"=1'-0"

# WOMEN A234, MEN A236

# MEN E103, WOMEN E104

GENERAL	DEMOLITION	I NOTES

- DEVICE LOCATIONS ARE SHOWN DIAGRAMMATICAL. FIELD CONFIRM EXACT LOCATION.
- DASHED LINES SHOWN ON DEMOLITION SHEETS ARE ITEMS SHOWN TO BE REMOVED UNLESS NOTED OTHERWISE.
- ELECTRICAL CONTRACTOR SHALL DISCONNECT AND REMOVE ALL LIGHT FIXTURES AND ASSOCIATED ELECTRICAL EQUIPMENT AS NEEDED. DESIGN INTENT IS TO RE-USE EXISTING LOCAL LIGHTING CIRCUIT.
- FIRE ALARM SYSTEM IS EXISTING TO REMAIN. EXISTING DEVICES SHALL BE PROTECTED, REMOVED FROM EXISTING CEILING, TEMPORARILY SUPPORTED, AND REINSTALLED IN THE NEW CEILING IN THE SAME LOCATION.
- OCCUPANCY SENSORS ARE EXISTING TO REMAIN UNLESS OTHERWISE NOTED. EXISTING DEVICES SHALL BE REMOVED FROM EXISTING CEILING AND REINSTALLED IN THE NEW CEILING IN THE SAME LOCATION.
- SPEAKERS ARE EXISTING TO REMAIN. EXISTING DEVICES SHALL BE REMOVED FROM THE EXISTING CEILING AND REINSTALLED IN THE NEW CEILING IN THE SAME LOCATION.
- POWER PACKS SHALL BE EXISTING TO REMAIN.

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PROJECT TITLE

PROJECT DATE

2024


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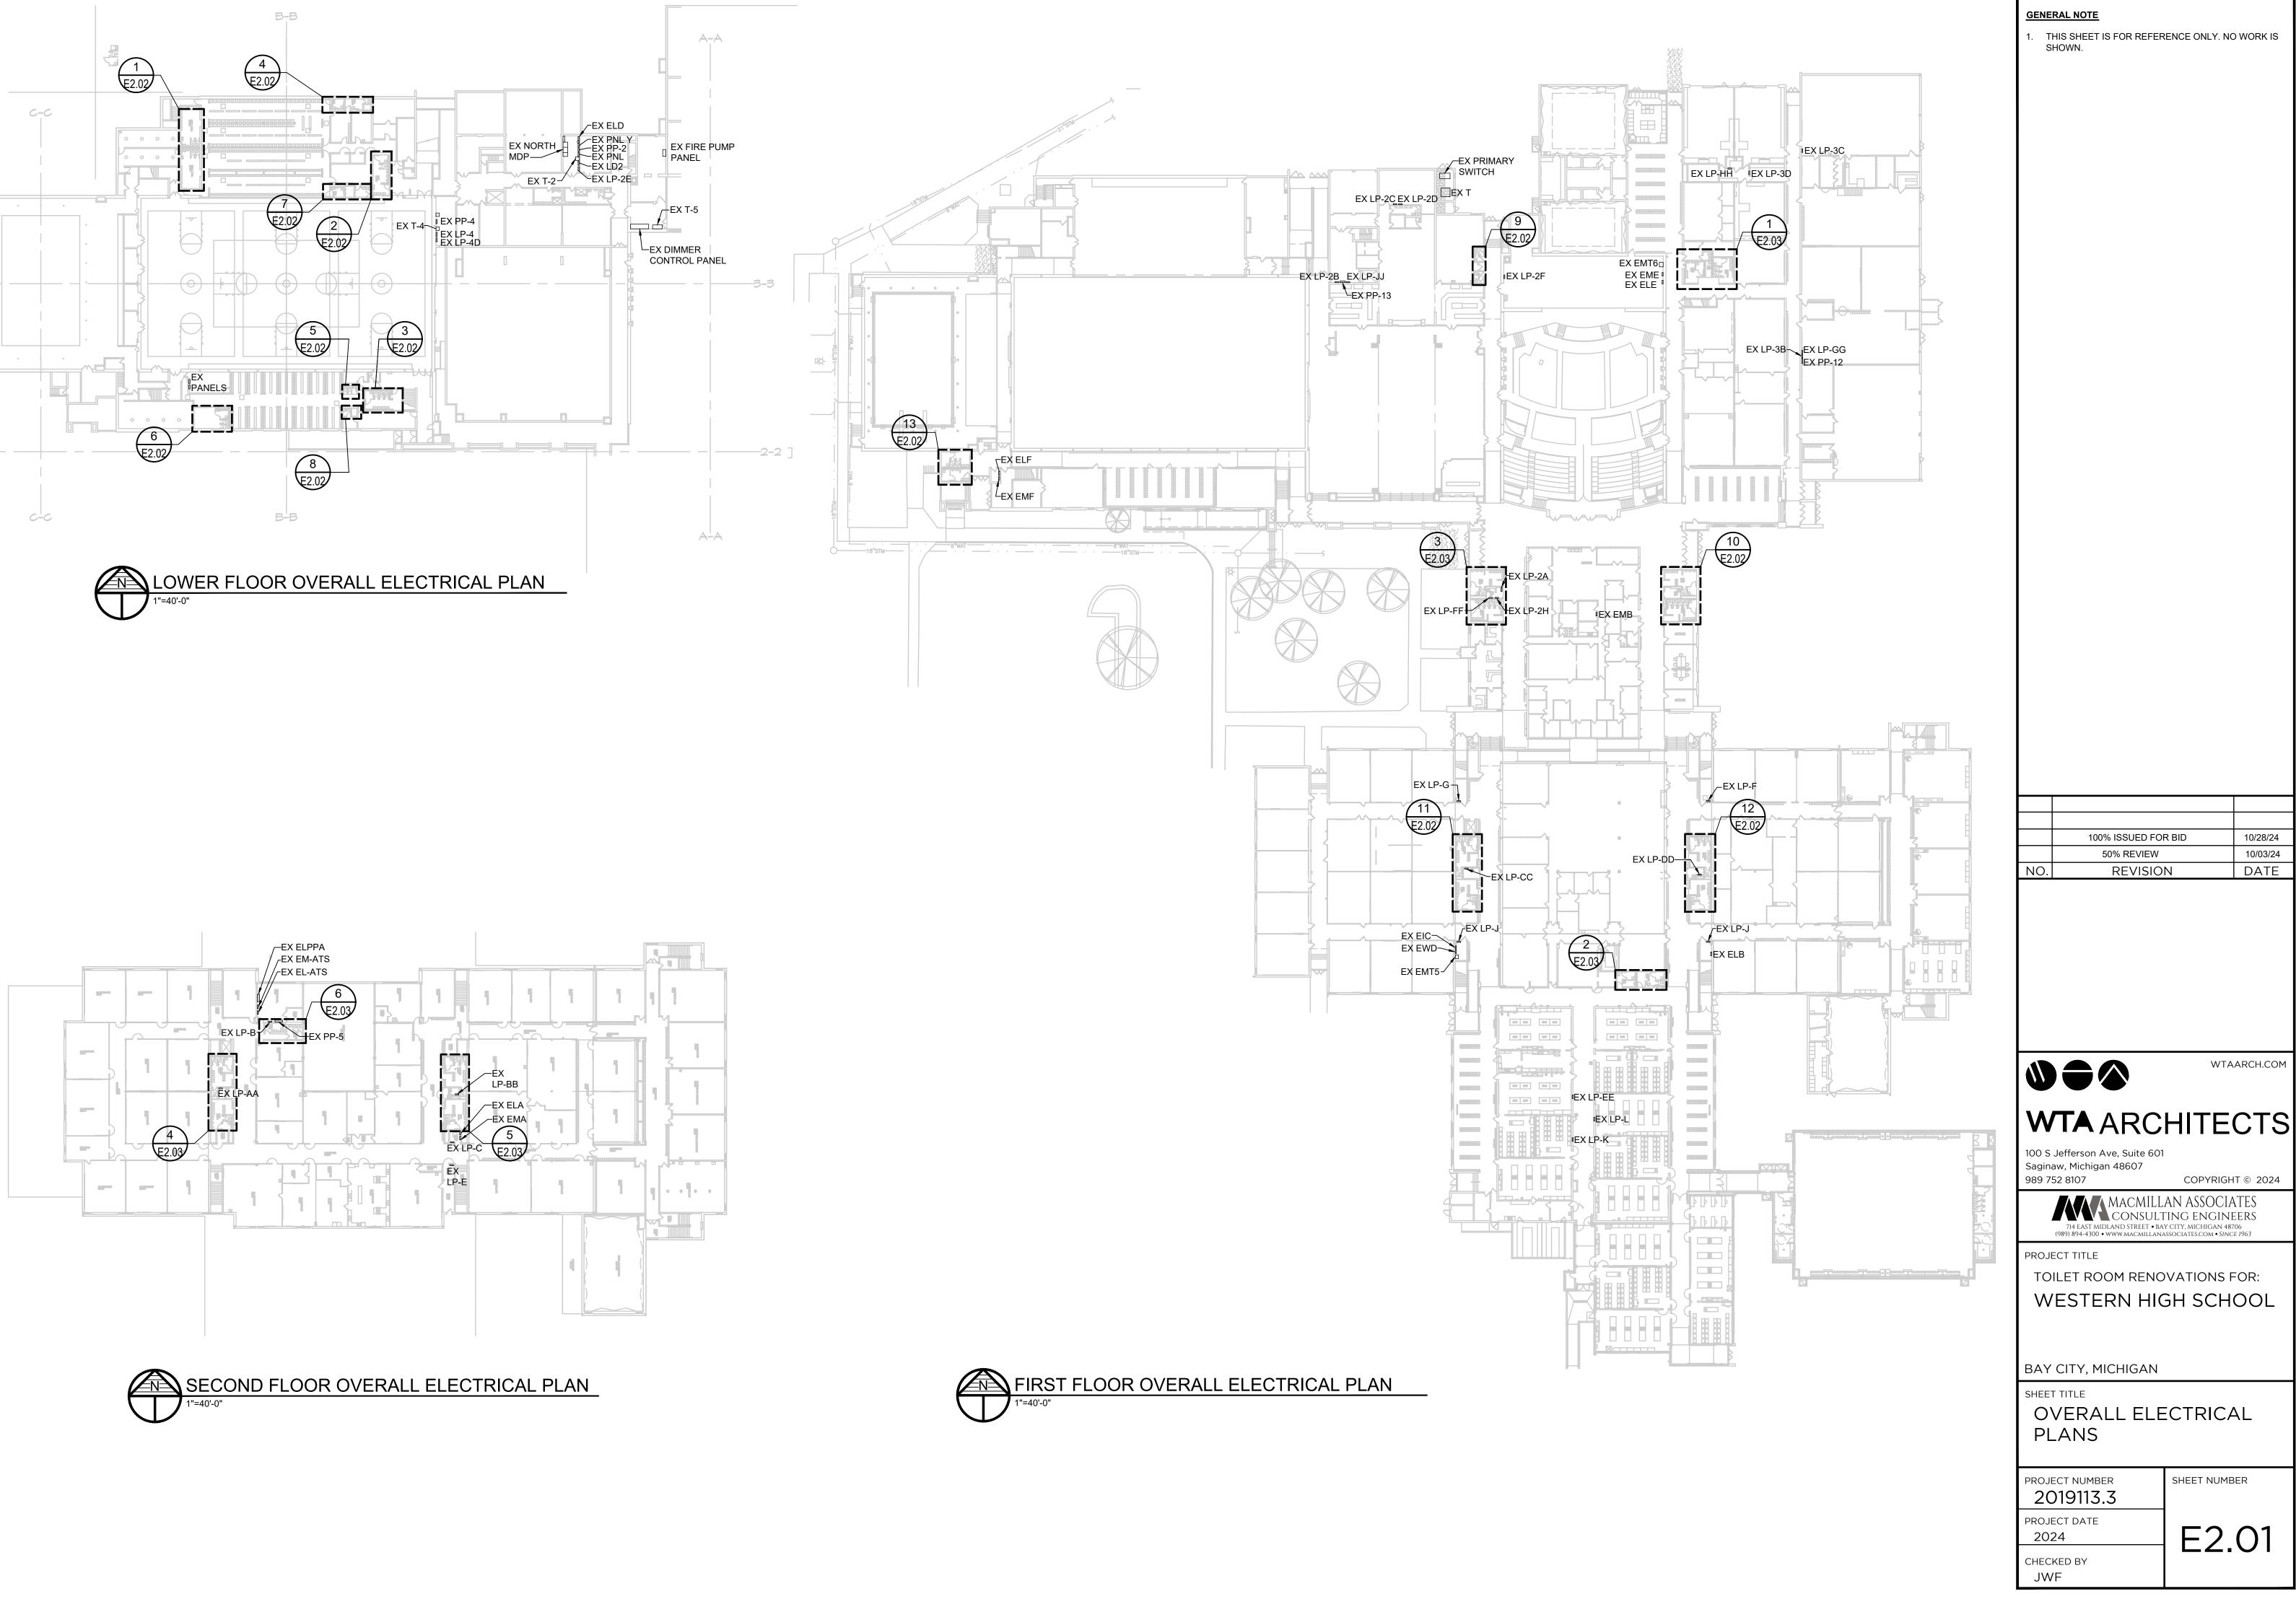
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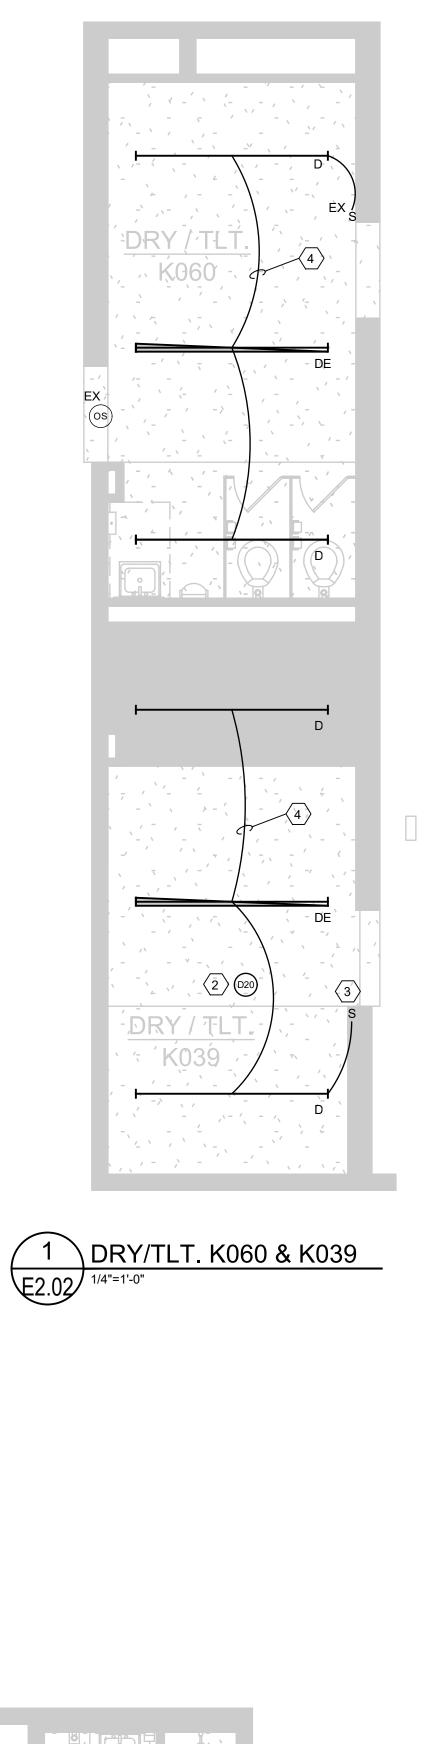
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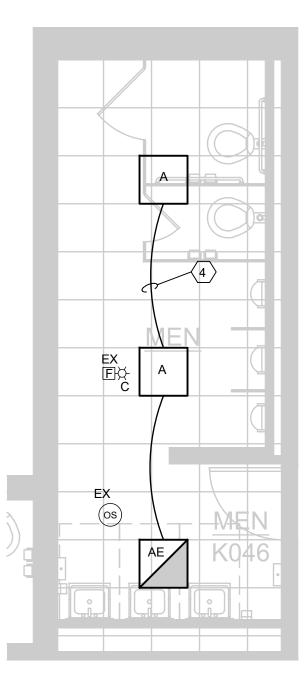
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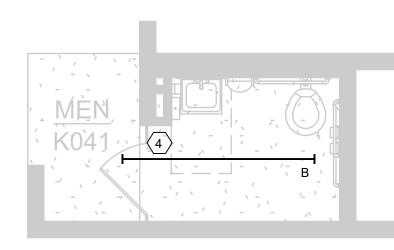











2 MEN K046 E2.02 1/4"=1'-0"

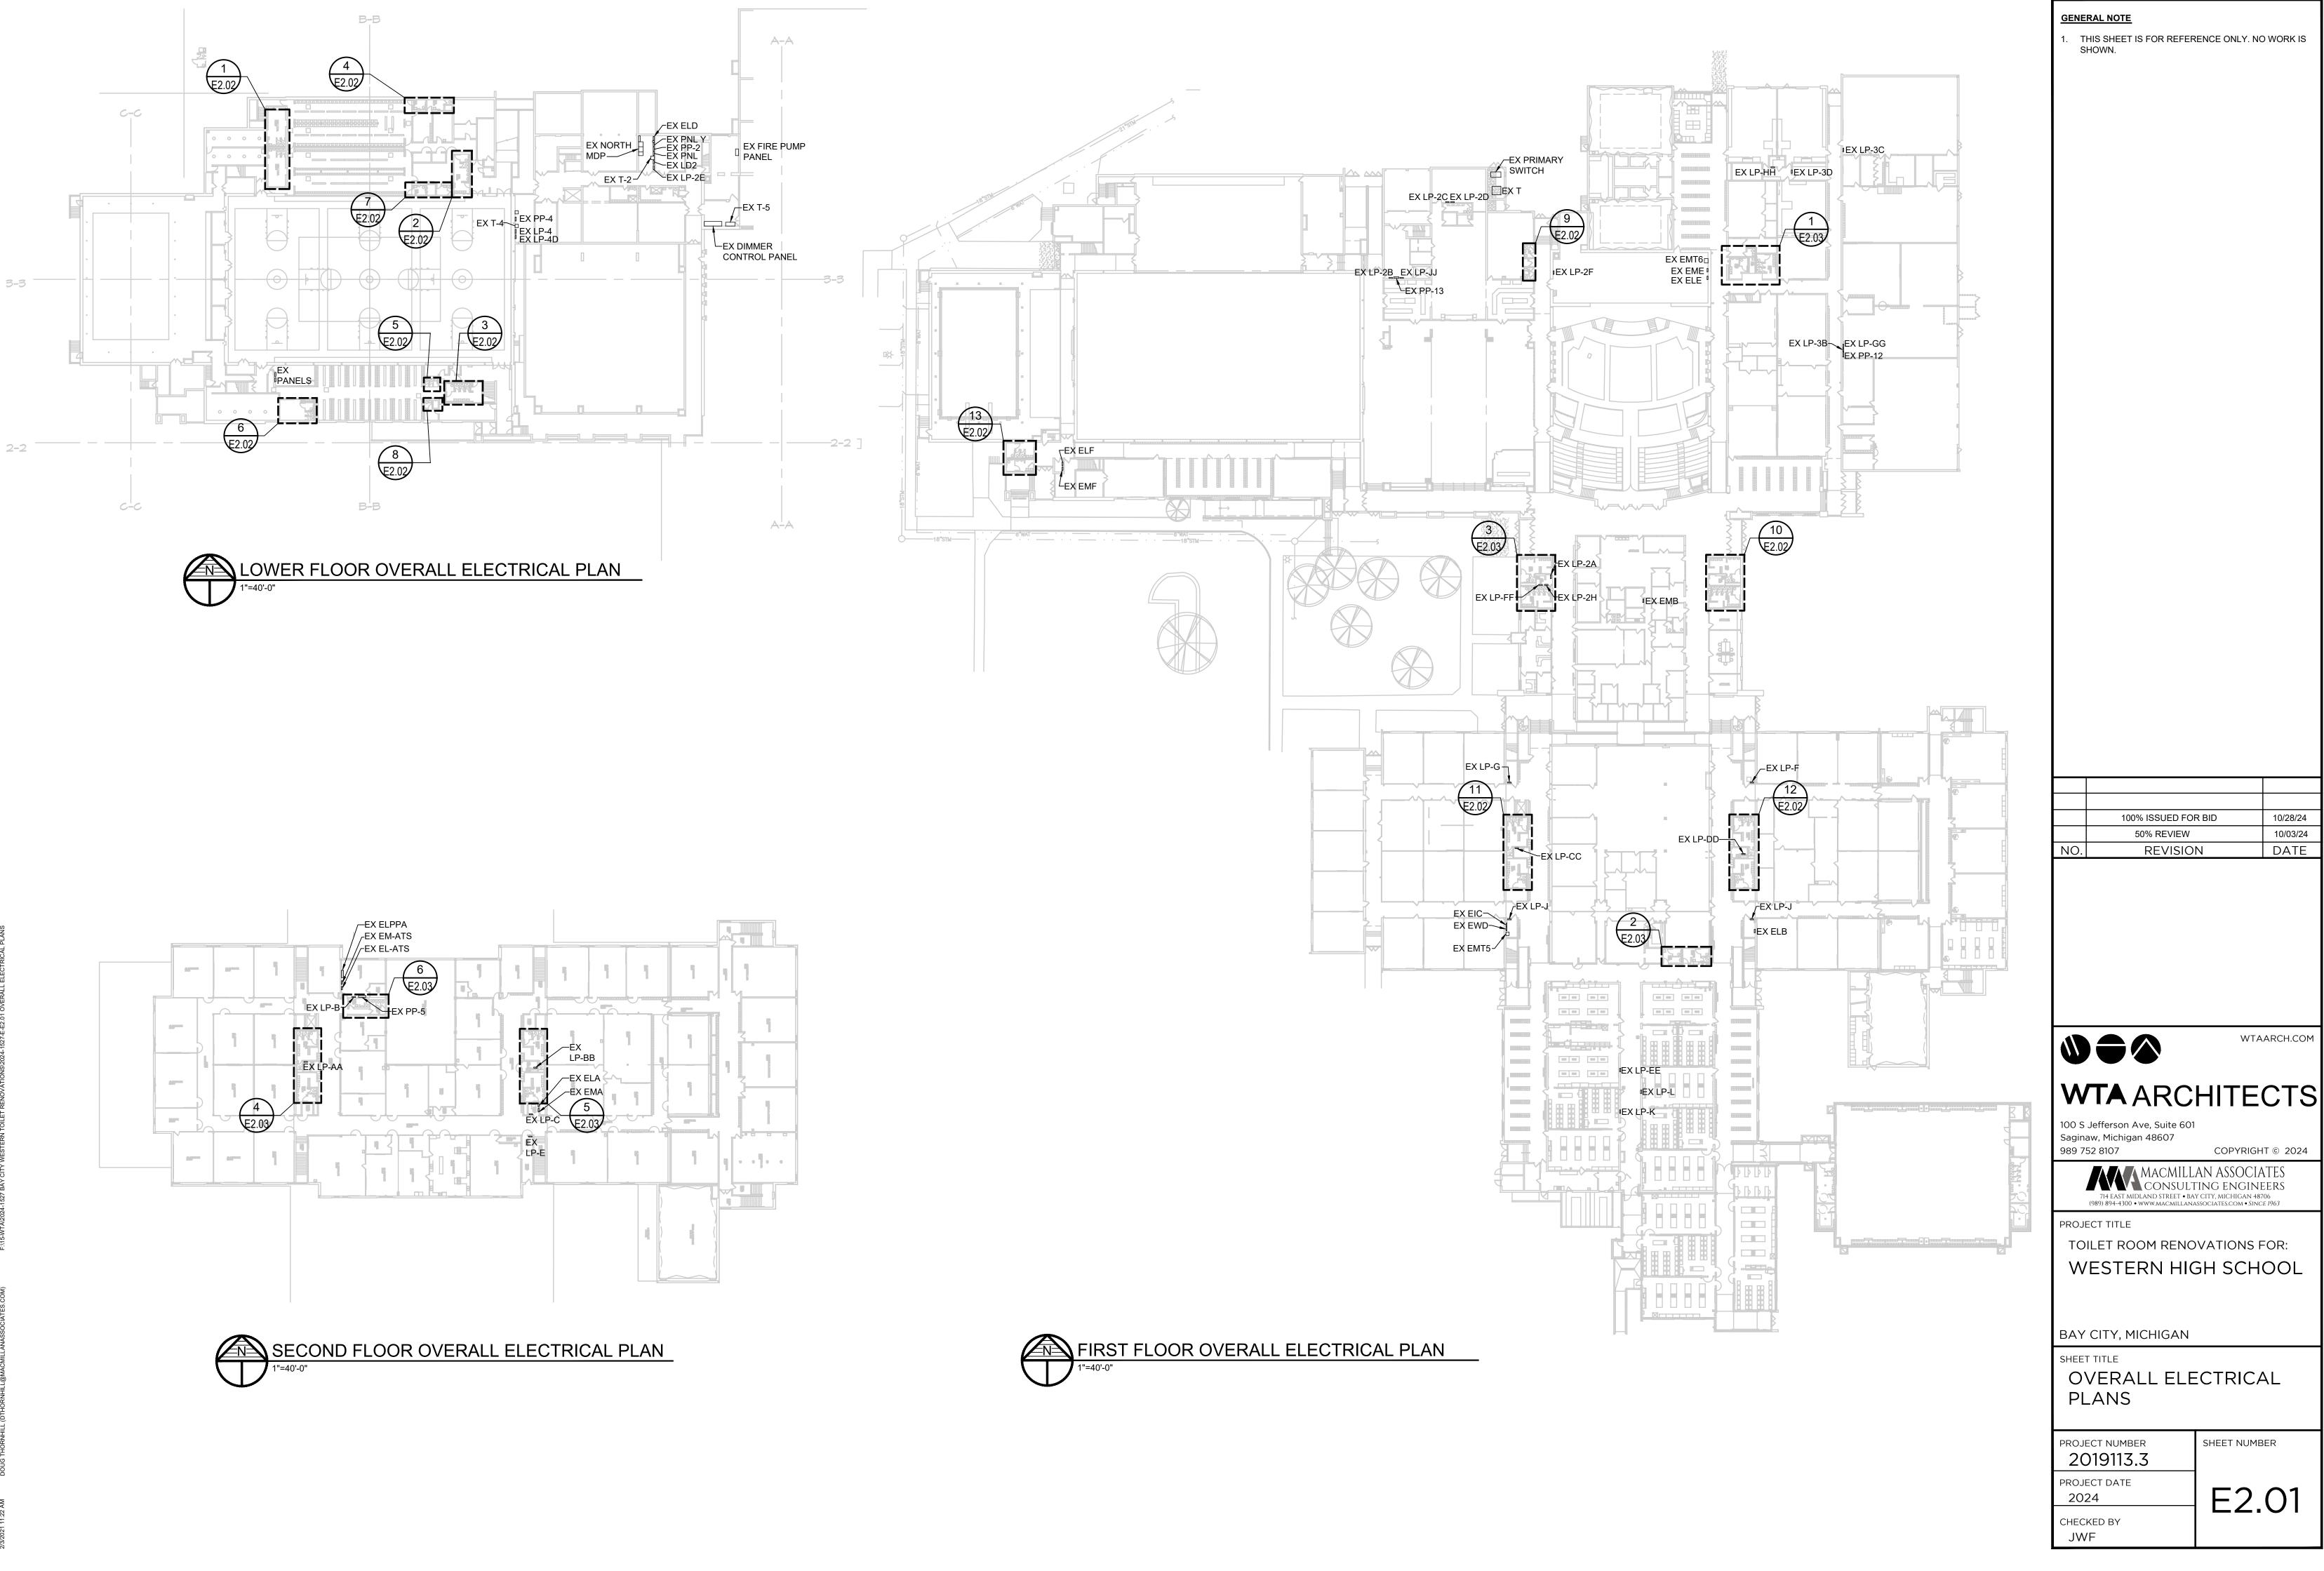


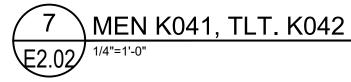


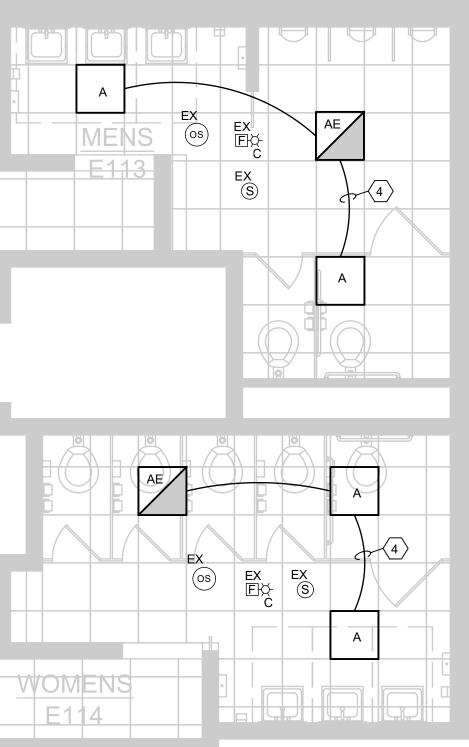

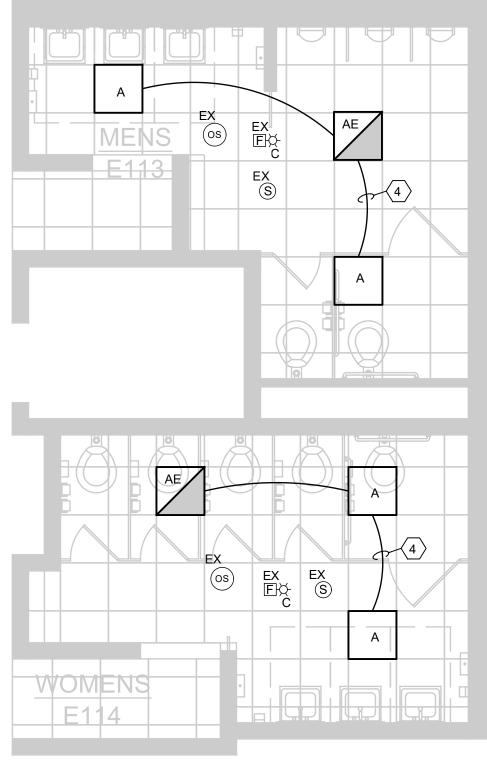



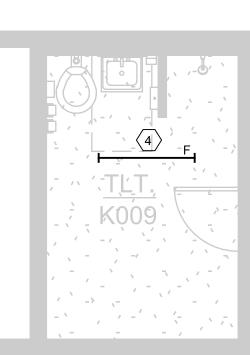

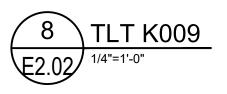



9 WOMEN J117, MEN J118 E2.02 1/4"=1'-0"

J118


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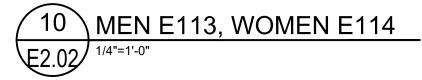
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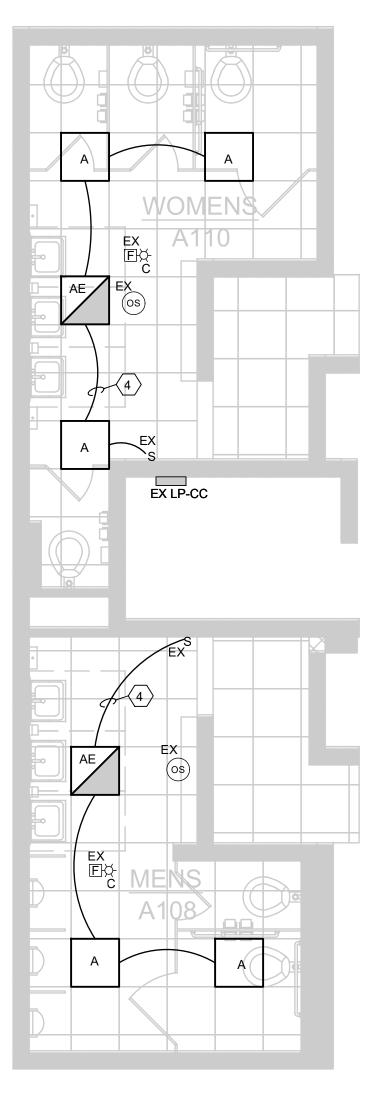





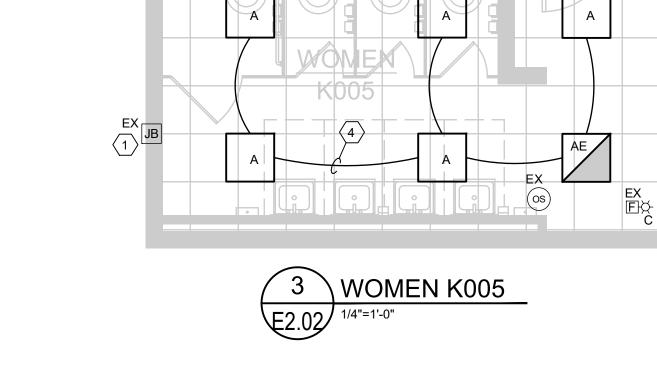


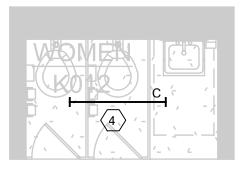





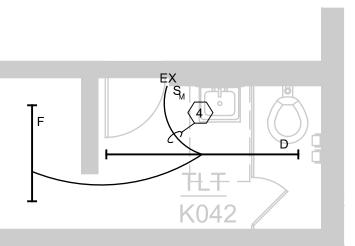


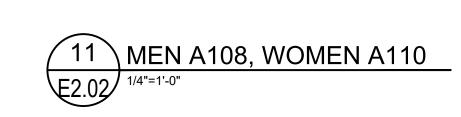


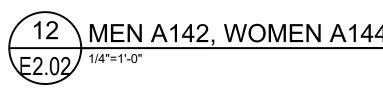

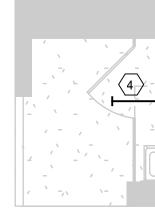

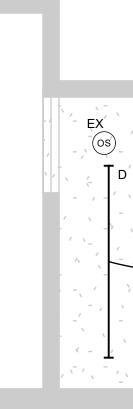

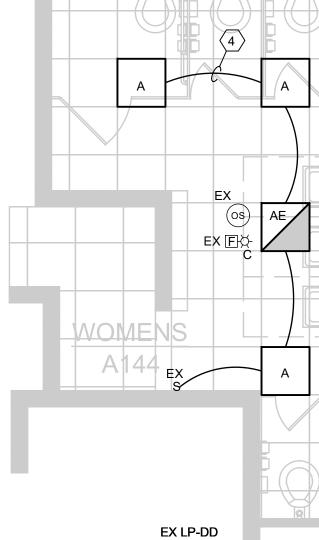

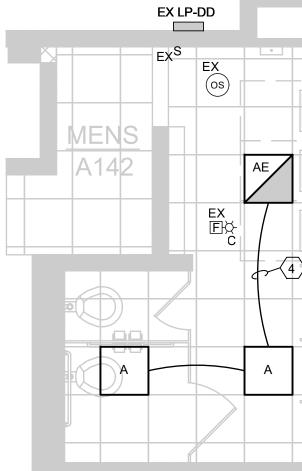

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#### GENERAL NOTES

- EXISTING FIRE ALARM SYSTEMS SHALL BE REINSTALLED IN NEW CEILING IN THE SAME LOCATION. SYSTEM SHALL BE RE-CERTIFIED UPON COMPLETION OF CONSTRUCTION.
- EXISTING OCCUPANCY SENSORS SHALL BE REINSTALLED IN NEW CEILING IN THE SAME LOCATION.
- EXISTING SPEAKERS SHALL BE REINSTALLED IN NEW CEILING IN THE SAME LOCATION.
- EXISTING POWER PACKS ARE TO REMAIN IN SAME LOCATION. ELECTRICAL CONTRACTOR SHALL VERIFY ALL LIGHTING CONTROLS WORK AS IT DID ORIGINALLY BEFORE CONSTRUCTION.

#### LIGHTING WIRING METHODS

- 1. ALL LIGHTING CIRCUITS SHALL BE INSTALLED IN CONDUIT.
- 2. MC CABLE IS AN ACCEPTABLE WIRING METHOD ONLY FOR FISHING EXISTING WALL CAVITIES.
- 3. CEILING OCCUPANCY SENSORS SHALL BE WIRED AHEAD OF THE LOCAL SWITCHING. THIS ALLOWS THE LOCAL SWITCHES TO OVERRIDE THE SENSOR TO TURN OFF THE LIGHTS.

#### KEYED NOTES


- > ELECTRICAL CONTRACTOR SHALL PROVIDE NEW COVER FOR EXISTING JUNCTION BOX.
- ELECTRICAL CONTRACTOR SHALL REPLACE EXISTING OCCUPANCY SENSOR 1 FOR 1. REUSE EXISTING LOW VOLTAGE WIRING.
- 3 ELECTRICAL CONTRACTOR SHALL REPLACE EXISTING SINGLE POLE SWITCH 1 FOR 1. REUSE EXISTING CIRCUIT.
- ELECTRICAL CONTRACTOR SHALL REUSE BATHROOM LIGHT FIXTURES.


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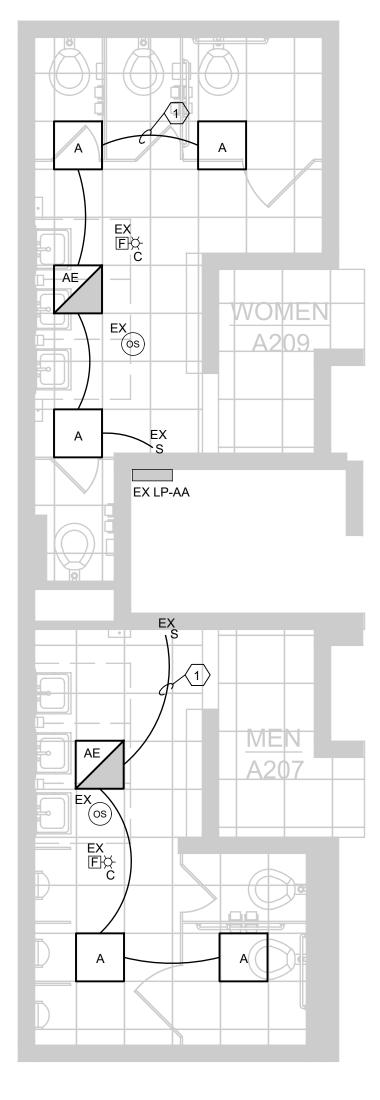
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100 S Jefferson Ave, Suite 601 Saginaw, Michigan 48607 989 752 8107	COPYRIGHT © 2024			
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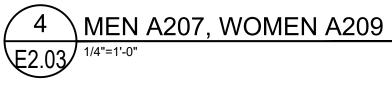
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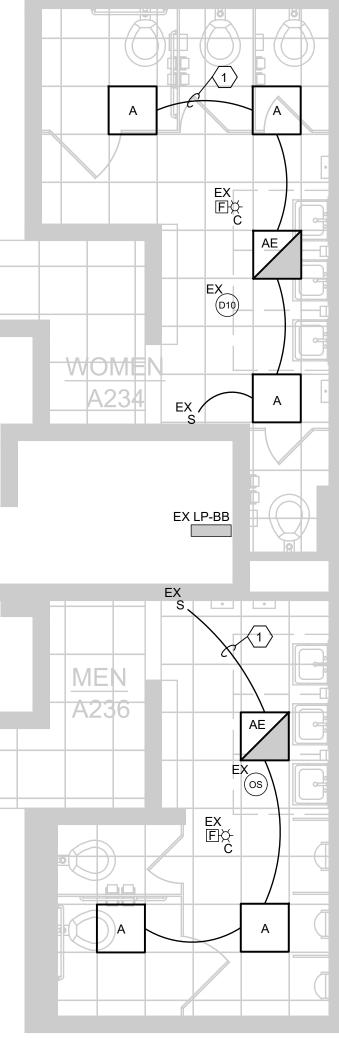











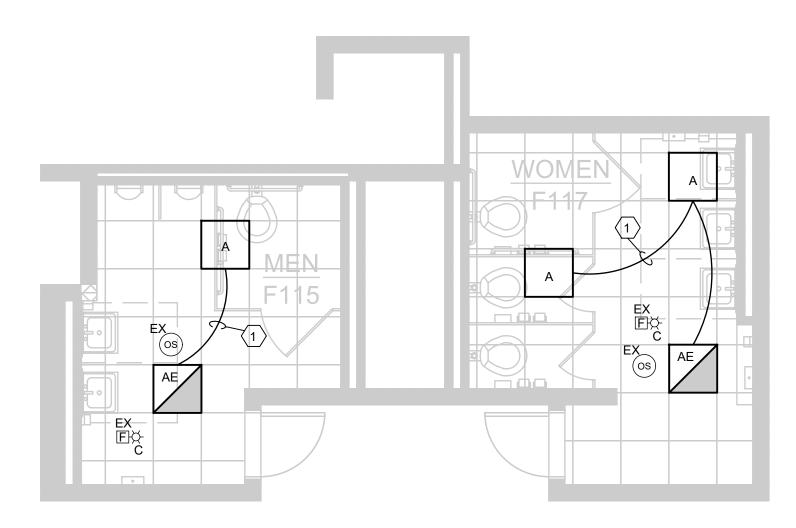


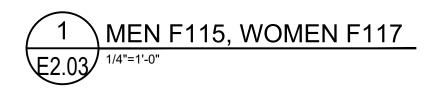


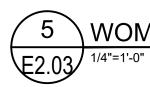

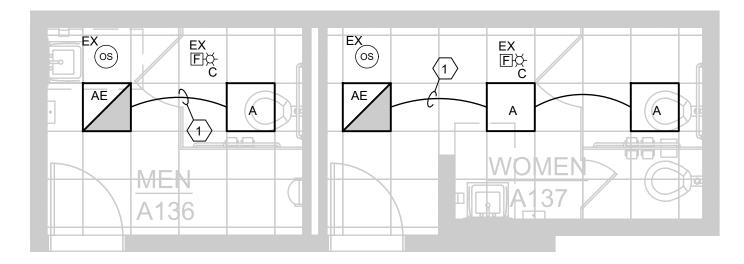

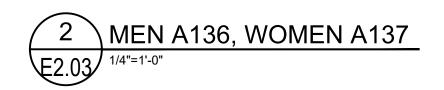


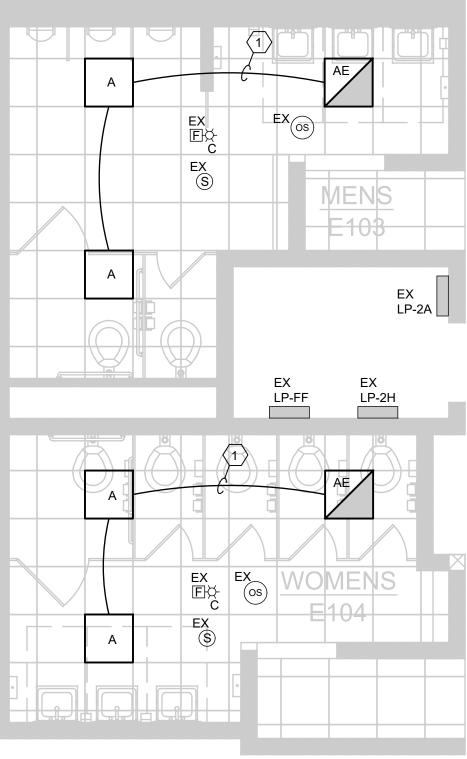


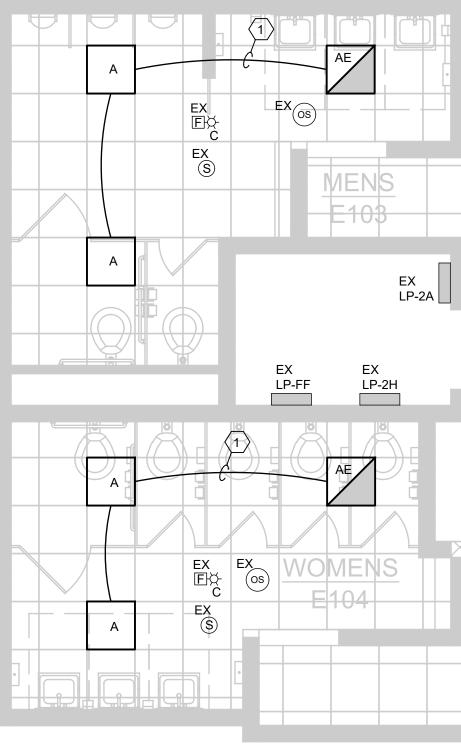



WOMEN A234, MEN A236

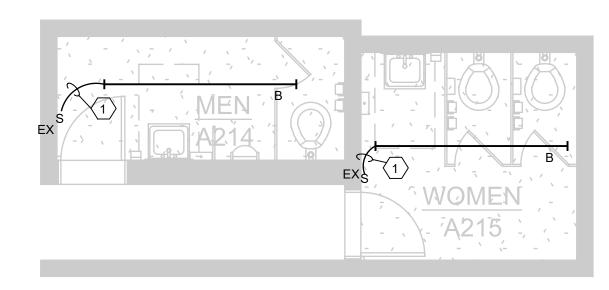

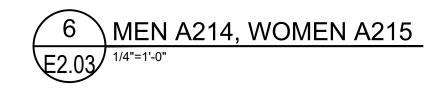

# 3 MEN E103, WOMEN E104 E2.03 1/4"=1'-0"

#### GENERAL NOTES

- EXISTING FIRE ALARM SYSTEMS SHALL BE REINSTALLED IN NEW CEILING IN THE SAME LOCATION. SYSTEM SHALL BE RE-CERTIFIED UPON COMPLETION OF CONSTRUCTION.
- EXISTING OCCUPANCY SENSORS SHALL BE REINSTALLED IN NEW CEILING IN THE SAME LOCATION.
- EXISTING SPEAKERS SHALL BE REINSTALLED IN NEW CEILING IN THE SAME LOCATION.
- EXISTING POWER PACKS ARE TO REMAIN IN SAME LOCATION. ELECTRICAL CONTRACTOR SHALL VERIFY ALL LIGHTING CONTROLS WORK AS IT DID ORIGINALLY BEFORE CONSTRUCTION.

#### LIGHTING WIRING METHODS

- ALL LIGHTING CIRCUITS SHALL BE INSTALLED IN CONDUIT.
- MC CABLE IS AN ACCEPTABLE WIRING METHOD ONLY FOR FISHING EXISTING WALL CAVITIES.
- CEILING OCCUPANCY SENSORS SHALL BE WIRED AHEAD OF THE LOCAL SWITCHING. THIS ALLOWS THE LOCAL SWITCHES TO OVERRIDE THE SENSOR TO TURN OFF THE LIGHTS.

#### KEYED NOTES

1 ELECTRICAL CONTRACTOR SHALL REUSE EXISTING LIGHTING CIRCUIT FOR NEW BATHROOM LIGHT FIXTURES.

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PROJECT TITLE

TOILET ROOM RENOVATIONS FOR: WESTERN HIGH SCHOOL

BAY CITY, MICHIGAN

SHEET TITLE
ENLARGED PLANS -
ELECTRICAL REVISED

PROJECT NUMBER 2019113.3	SHEET NUMBER
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#### LOAD SUMMARY (277V LIGHTING) LOAD DESCRIPTION LOAD (KVA) LIGHTING LOAD REMOVED 5.728 KVA LIGHTING LOAD ADDED 2.886 KVA NET CHANGES -2.842 KVA, 10.26 A

#### LIGHTING FIXTURE SCHEDULE

- A LED 2'X2' FLAT PANEL, SWITCHABLE LUMENS (MID 3200LM), 80 CRI, SWITCHABLE COLOR TEMP, SATIN WHITE DIFFUSER, MVOLT, COMPATIBLE WITH EXISTING AUTO ON/OFF LIGHTING CONTROLS, 34WATTS LITHONIA #CPX 2X2 AL07 80CRI SWW7 SWL MVOLT OR EQUAL.
- AE SAME AS FIXTURE A EXCEPT WITH A 10WATT EMERGENCY BATTERY LITHONIA #CPX 2X2 AL07 80CRI SWW7 SWL MVOLT E10WLCP OR EQUAL.
- B CLX LED LINEAR, 8', 6000 LUMENS, STANDARD EFFICIENCY, LESS LOUVER, FLAT DIFFUSE LENS, GENERAL DISTRIBUTION, MVOLT, 40K, 80CRI, COMPATIBLE WITH EXISTING AUTO ON/OFF LIGHTING CONTROLS, WHITE FINISH, SURFACE MOUNTED, 37WATTS LITHONIA #CLX L96 6000LM SEF FDL MVOLT GZ1 40K 80CRI WH OR EQUAL.
- C CLX LED LINEAR, 4', 3000 LUMENS, STANDARD EFFICIENCY, LESS LOUVER, FLAT DIFFUSE LENS, GENERAL DISTRIBUTION, MVOLT, 40K, 80CRI, COMPATIBLE WITH EXISTING AUTO ON/OFF LIGHTING CONTROLS, WHITE FINISH, SURFACE MOUNTED, 18.5WATTS LITHONIA #CLX L48 3000LM SEF FDL MVOLT GZ1 40K 80CRI WH OR EQUAL.
- D VAPOR TIGHT LED STRIP LIGHT, 8', 6000 LUMENS, MVOLT, SWITCHABLE WHITE, 80CRI, 49 WATTS, SURFACE MOUNTED. LITHONIA #CSVT L96 6000LM MVOLT SWW3 80CRI OR EQUAL.
- DE SAME AS FIXTURE D EXCEPT WITH A 7WATT EMERGENCY BATTERY LITHONIA #CSVT L96 6000LM MVOLT SWW3 80CRI IE7WCP OR EQUAL
- F VAPOR TIGHT LED STRIP LIGHT, 4', 3000 LUMENS, MVOLT, SWITCHABLE WHITE, 80 CRI, 24 WATTS, SURFACE MOUNTED LITHONIA #CSVT L48 3000LM MVOLT SWW3 80CRI OR EQUAL


#### ELECTRICAL SYMBOLS LIST 2X4 LIGHT FIXTURE, TYPE INDICATED 2X2 LIGHT FIXTURE, TYPE INDICATED STRIP LIGHT, TYPE INDICATED HALF SHADED FIXTURES ARE EMERGENCY FIXTURES S SINGLE POLE SWITCH S<sub>M</sub> WALL MOTION SWITCH SENSOR OS OCCUPANCY SENSOR D20) DUAL TECH, CEILING MOUNTED, LARGE-MOTION DETECTION, 2000 SQFT RADIAL COVERAGE SENSOR ACUITY #NCM PDT 10 SERIES OR EQUAL JB JUNCTION BOX PANELBOARD SWITCHBOARD T TRANSFORMER E☆ CEILING MOUNTED FIRE ALARM STROBE ONLY MDP MAIN DISTRIBUTION PANEL PP POWER PANEL LP LIGHTING PANEL RP RECEPTACLE PANEL

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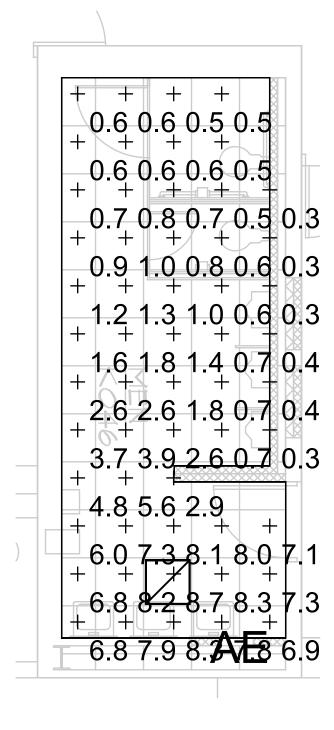
-> -+(-+) + -1.0 1.0 1.0 1.0 1.0 0.6 - ,+` , +, -´ +' - +, . 1.2 1.3 1.3 1.3 1.2 0.8 -+; -+; 1.5 1.6 1.7 1.7 1.6 1.11.8 2.2 2.3 2.3 2.1 1.92.2 2.7 3.0 2.9 2.7 2.2  $\begin{array}{c} 2.5 3.1 3.4 3.4 3.1 2.0 \\ + 2.5 2.9 3.2 3.1 2.9 \\ + 2.5 2.9 3.2 3.1 2.9 \\ + 2.5 4 2.9 \\ + 2.5 4 2.9 \\ + 2.5 4 2.9 \\ + 2.5 4 2.9 \\ + 2.5$ 1.6 1.8 1.9 1.9 1.8 1.2 1.2 1.4 1.4 1.4 1.4 0.91.0 1.1 1.1 1.1 1.1 0.7 ╘╾╝┼┊╶╫(╶╫║┼ 1.0 1 1 1 1 1 1 1 1 1.3 1.4 1.4 1.4 1.3 1.6 1.8 1.9 1.8 1. 2.0 2.3 2.5 2.4 2.2 2.4 2.9 3.1 3.0 2. +2.7 + 3.2 + 3.5 + 3.4 + 3.0+2.4 + 2.9 + 3.1 + 3.0 + 2.7 + 2.32.0 2.3 2.4 2.4 2.2 2.0 1.0 1.0 1.1 1.0 1.0

#### DRY/TLT. K060 & K039 1/4"=1'-0"




### WOMEN J117, MEN J118

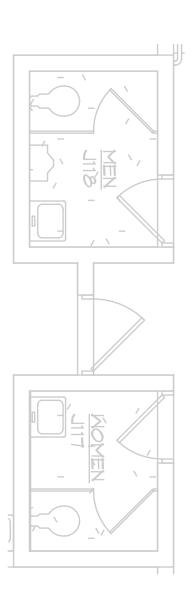
1/4"=1'-0"



MEN K046 1/4"=1'-0"

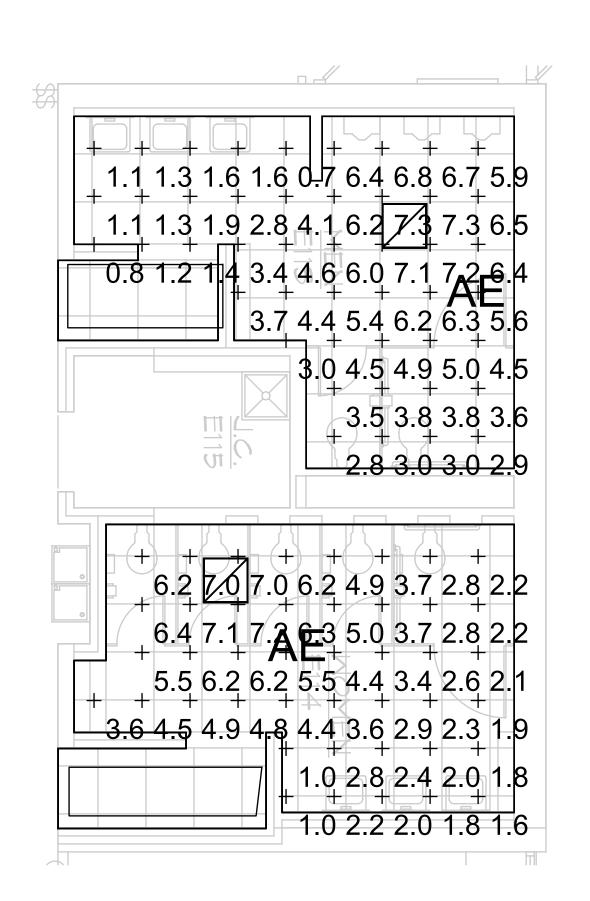


MEN E113, WOMEN E114 1/4"=1'-0"

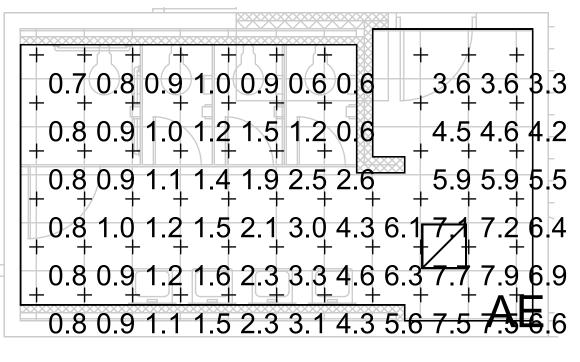


WOMEN K005 1/4"=1'-0"


Statistics
Description
•
DRY/TLT. K0
DRY/TLT. K0
MEN A108
MEN A142
MEN E113
Men K046
MEN K113
WOMEN A11
WOMEN A14
WOMEN E11
WOMEN K00
WOMEN K11
DRY/TLT. K0

Schedule								
Symbol	Label	QTY	Manufacturer	Catalog	Number Lamps	Lamp Output	LLF	Input Power
	AE	10	Lithonia Lighting	CPX 2X2 ALO7 (Mid) SWW7 (35K) SWL MVOLT	1	3432	0.95	27.66
	DE	3	Lithonia Lighting	CSVT L96 6000LM MVOLT 4000K 80CRI	1	6213	0.95	48.5179

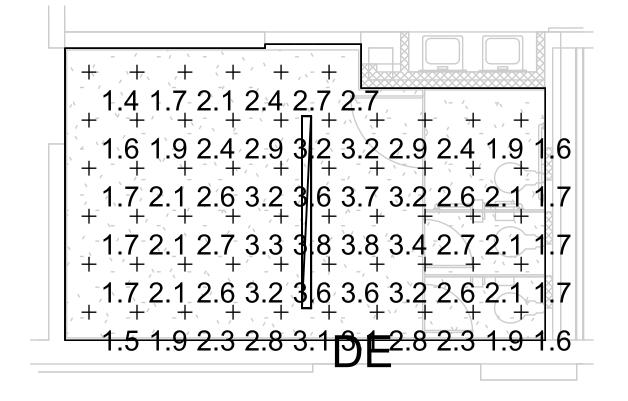


DRY/TLT. K017

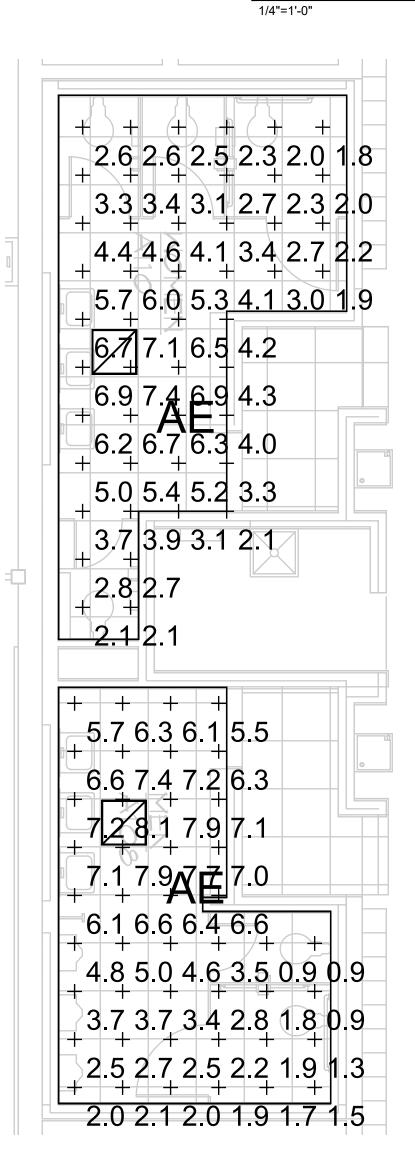

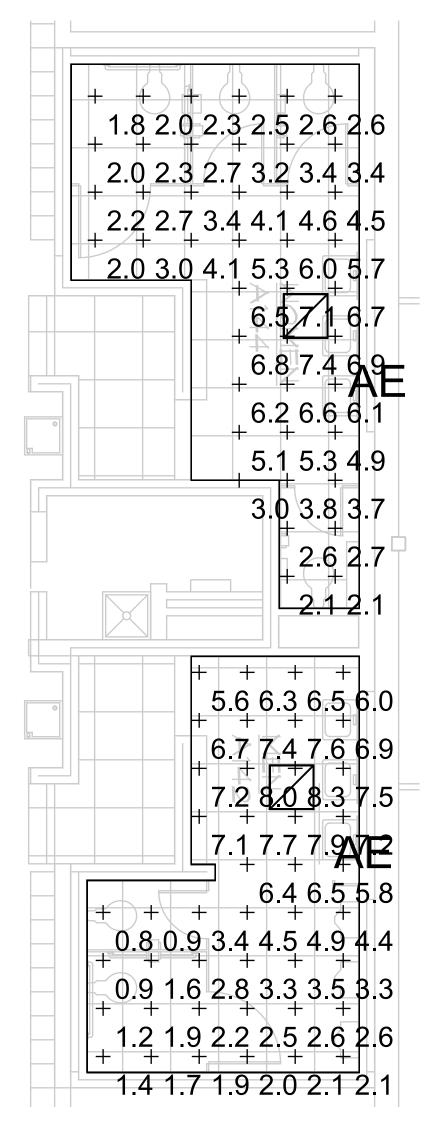

MEN A142, WOMEN A144 1/4"=1'-0"


	-					
	Symbol	Avg	Max	Min	Max/Min	Avg/Min
39	+	2.0 fc	3.5 fc	1.0 fc	3.5:1	2.0:1
60	+	1.8 fc	3.4 fc	0.6 fc	5.7:1	3.0:1
	+	4.5 fc	8.1 fc	0.9 fc	9.0:1	5.0:1
	+	4.4 fc	8.3 fc	0.8 fc	10.4:1	5.5:1
	+	4.1 fc	7.3 fc	0.7 fc	10.4:1	5.9:1
	+	3.0 fc	8.7 fc	0.3 fc	29.0:1	10.0:1
	+	5.3 fc	8.5 fc	2.2 fc	3.9:1	2.4:1
0	+	4.0 fc	7.4 fc	1.8 fc	4.1:1	2.2:1
4	+	4.0 fc	7.4 fc	1.8 fc	4.1:1	2.2:1
4	+	3.9 fc	7.2 fc	1.0 fc	7.2:1	3.9:1
5	+	3.0 fc	7.9 fc	0.6 fc	13.2:1	5.0:1
4	+	5.2 fc	7.3 fc	3.7 fc	2.0:1	1.4:1
17	+	2.5 fc	3.8 fc	1.4 fc	2.7:1	1.8:1

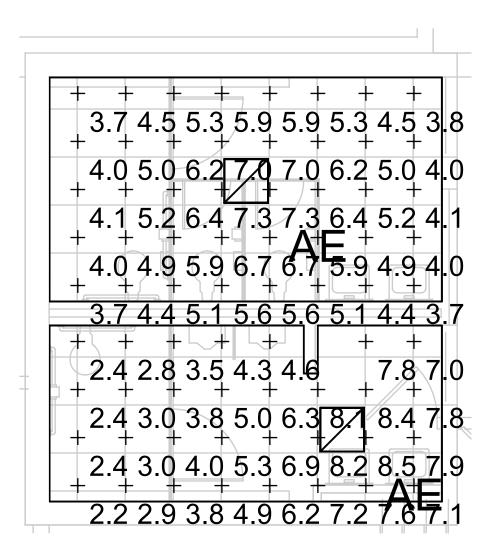


WOMEN K114, MEN K113 1/4"=1'-0"


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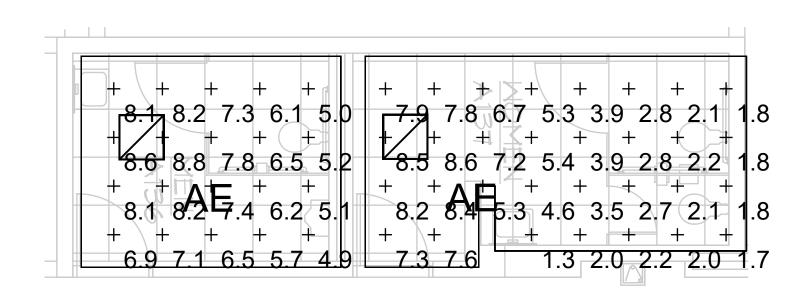


MEN F115, WOMEN F117 1/4"=1'-0"

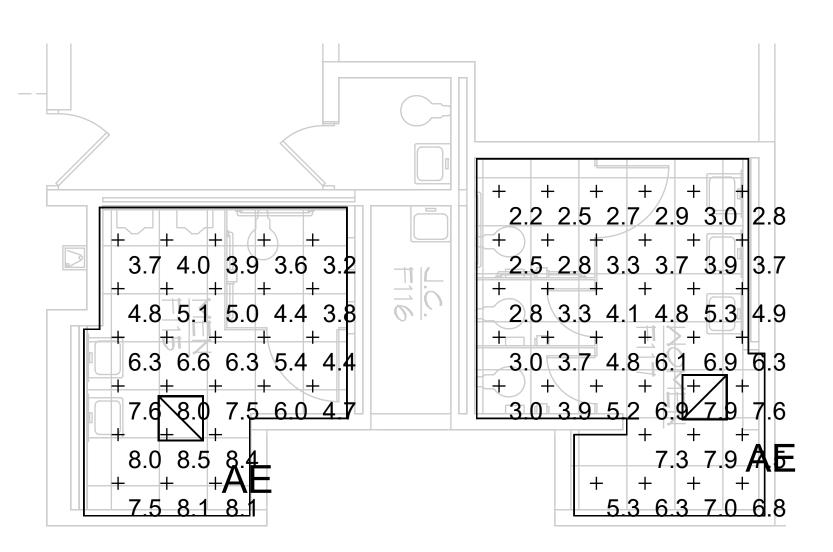


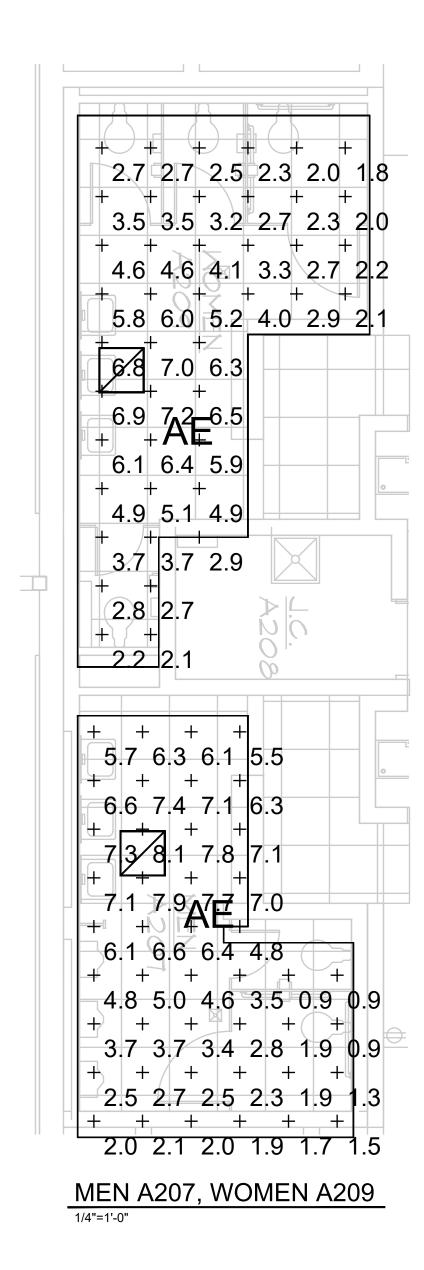

1/4"=1'-0"

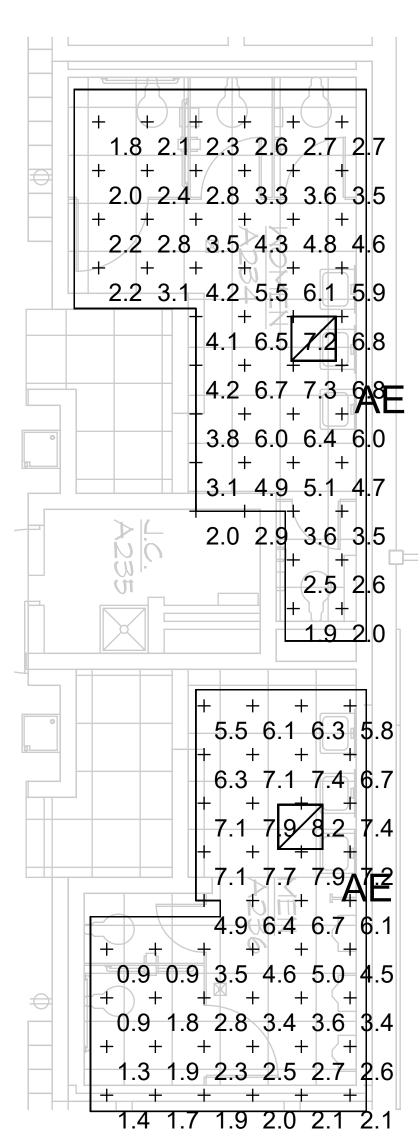

MEN A136, WOMEN A137

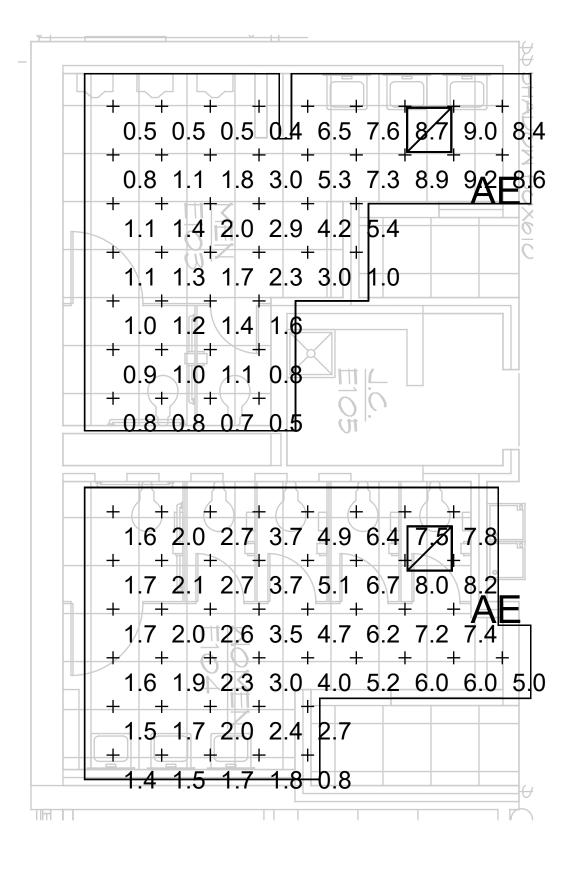

WOMEN A234, MEN A236

1/4"=1'-0"

Statistics						
Description	Symbol	Avg	Max	Min	Max/Min	Avg/Min
MEN A207	+	4.4 fc	8.1 fc	0.9 fc	9.0:1	4.9:1
MEN A236	+	4.4 fc	8.2 fc	0.9 fc	9.1:1	4.9:1
MEN E103	+	3.0 fc	9.2 fc	0.4 fc	23.0:1	7.5:1
MEN F115	+	5.9 fc	8.5 fc	3.2 fc	2.7:1	1.8:1
WOMEN A137	+	4.5 fc	8.6 fc	1.3 fc	6.6:1	3.5:1
WOMEN A209	+	4.0 fc	7.2 fc	1.8 fc	4.0:1	2.2:1
WOMEN A234	+	4.0 fc	7.3 fc	1.8 fc	4.1:1	2.2:1
WOMEN E104	+	3.8 fc	8.2 fc	0.8 fc	10.3:1	4.8:1
WOMEN F117	+	4.7 fc	7.9 fc	2.2 fc	3.6:1	2.1:1
MEN A136	+	6.9 fc	8.8 fc	4.9 fc	1.8:1	1.4:1

Manufac	turer				-	-	-	
Symbol	Label	QTY	Manufacturer	Catalog	Number Lamps	Lamp Output	LLF	Input Power
	AE	10	Lithonia Lighting	CPX 2X2 ALO7 (Mid) SWW7 (35K) SWL MVOLT	1	3432	0.95	27.66

# MEN E103, WOMEN E104

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