

LOCATION MAP

NO SCALE

BULLOCK CREEK SCHOOL DISTRICT 2023 BOND- SERIES 1 2025 IMPROVEMENTS THA PROJECT #24-120

1420 SOUTH BADOUR ROAD MIDLAND MI 48640

PROJECT 'A' RENOVATIONS TO: BULLOCK CREEK HIGH SCHOOL

1420 SOUTH BADOUR ROAD MIDLAND MI 48640

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-A601 DOOR SCHEDULE, ROOM FINISH SCHEDULE, & DETAILS

K-M101 MECHANICAL TOILET ROOM ENLARGED PLUMBING PLAN K-P101 'A' WING ENLARGED TOILET ROOM PLUMBING PLAN


A-P102 'B' WING ENLARGED TOILET ROOM PLUMBING PLAN A-P103 'D' WING ENLARGED TOILET ROOM PLUMBING PLAN A-P104 'E' WING ENLARGED TOILET ROOM PLUMBING PLAN A-P105 'F' WING ENLARGED TOILET ROOM PLUMBING PLAN

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A-E101 TOILET ROOM ELECTRICAL DEMOLITION PLANS

A-E102 TOILET ROOM ELECTRICAL PLANS

-E601 ELECTRICAL DETAILS AND SCHEDULES



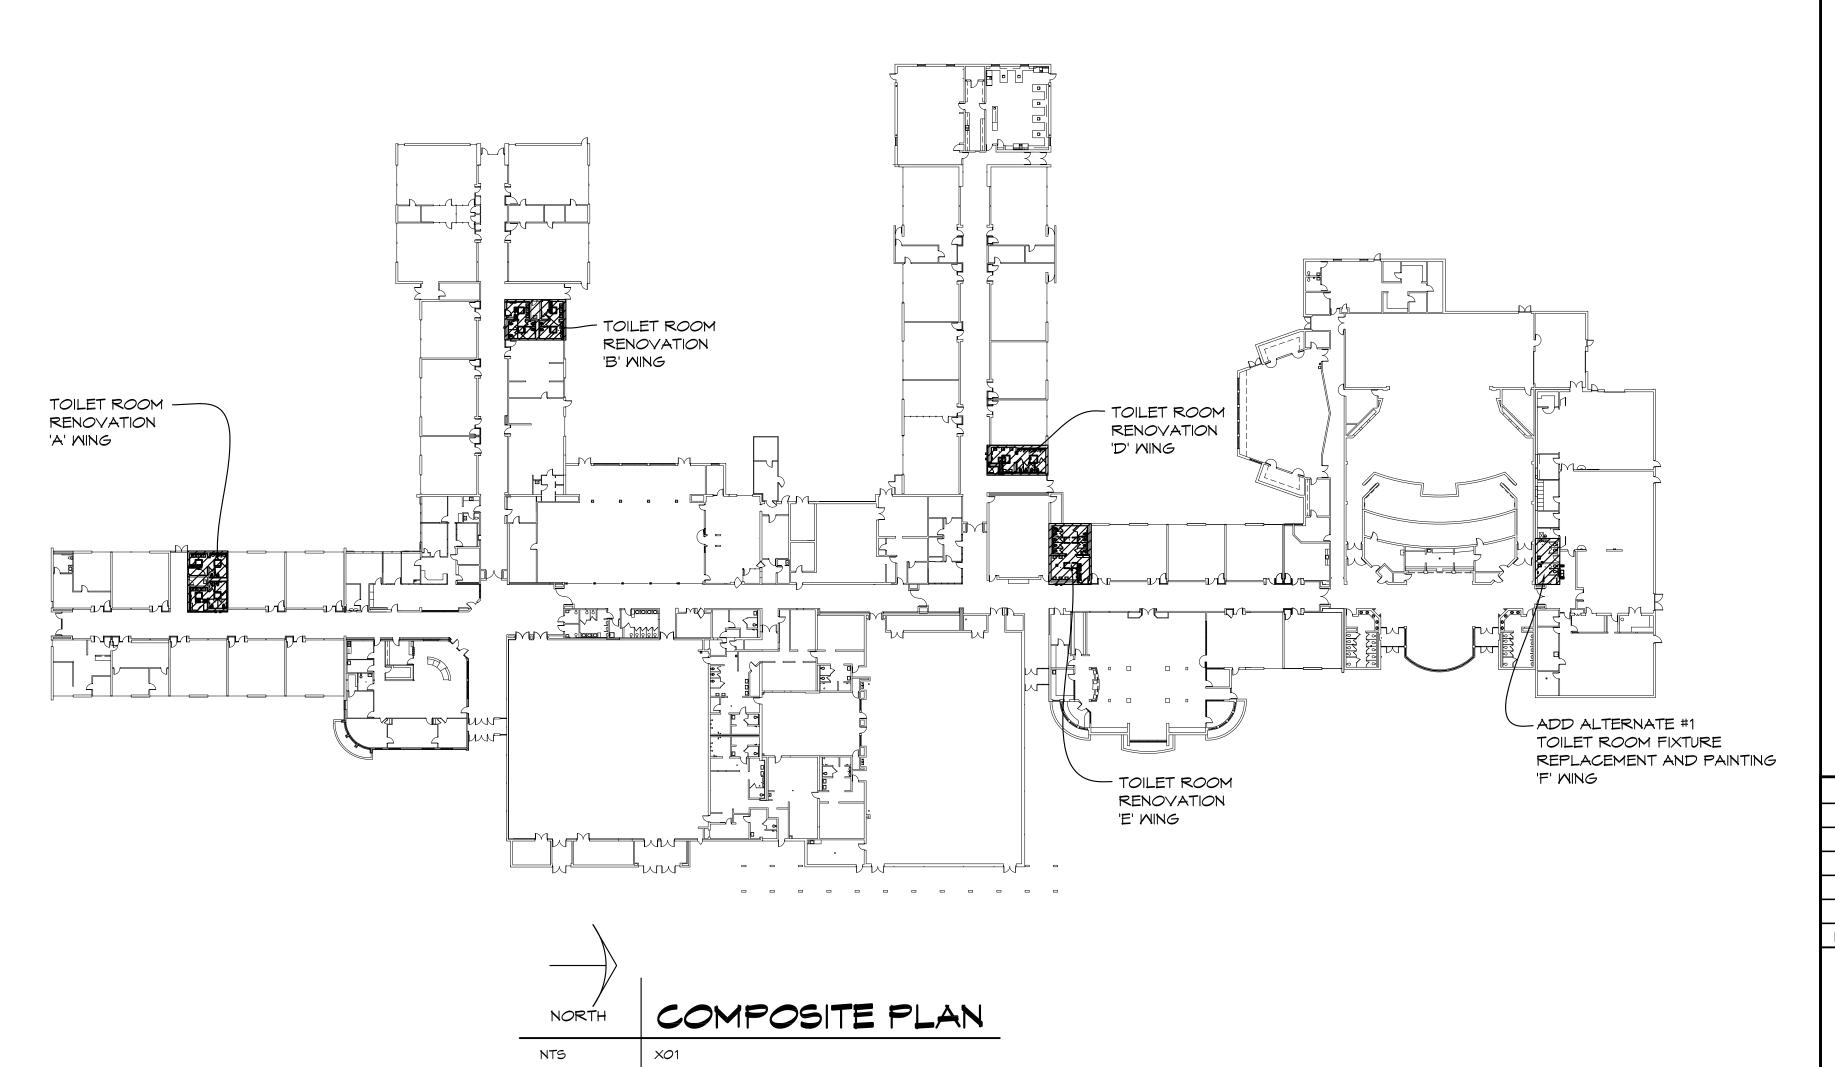



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BULLOCK CREEK SCHOOL DISTRICT 2023 BOND- SERIES 1 2025 IMPROVEMEN THA PROJECT# 24-120 THA PROJECT 7A RENOVATIONS TO: BULLOCK CREEK HIGH SCHOOL 1420 SOUTH BADOUR ROAD MIDLAND MI 48640

NO. REVISIONS / SUBMISSIONS

DATE

SEAL

DRAWN
KRS
24-120

CHECKED
JESS
A-GOO1

REVIEWED
MLB
DATE
OCT 18, 2024

SCALE
N.T.S.
1 OF 15

SCALE
N.T.S.

THA Architects Engineers - P:\Bullock Creek\24-120 2023 Bond Series 1 2025 Improvements\Drafting\01-CAD\BC HS\03-CD\A-C


ENLARGED PLAN

1/4" = 1'-0" XO1


HEIGHT MASONRY WALL 3'-4" - REMOVE SPEAKER, RE: REMOVE SPEAKER, EXISTING SIGN REMOVE WOOD SHELF ELECTRICAL PLANS RE: ELECTRICAL TO REMAIN -M.O. **& PARTIAL HEIGHT** PLANS ---MASONRY WALL-EXISTING SIGN TO REMAIN -REMOVE CEILING FRAMING AT - REMOVE CEILING PREVIOUSLY FRAMING AT REMOVED SKYLIGHT PREVIOUSLY REMOVED SKYLIGHT **E**-04---REMOVE EXISTING LOUVER, RE: MECHANICAL PLANS

- REMOVE WOOD SHELF & PARTIAL


'B' WING TOILET ROOMS ENLARGED PLAN 1/4" = 1'-0"

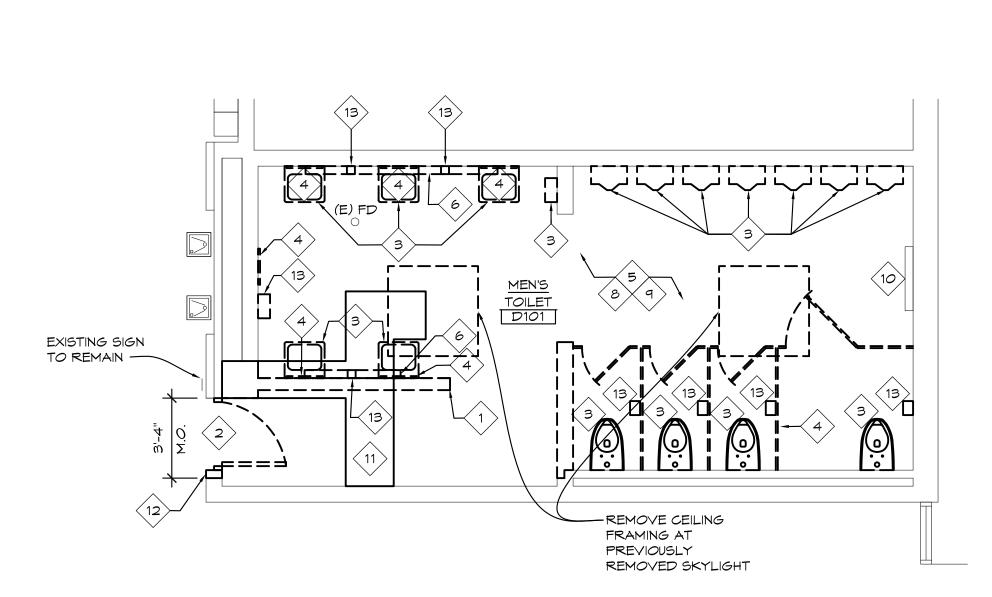



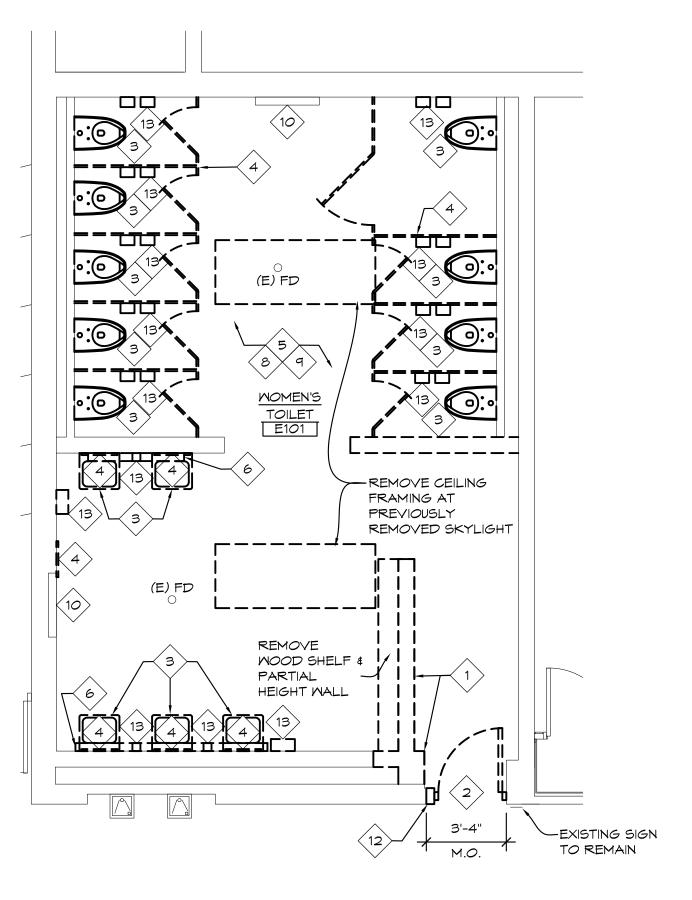

'E' WING TOILET ROOM ENLARGED PLAN 1/4" = 1'-0" ×O1

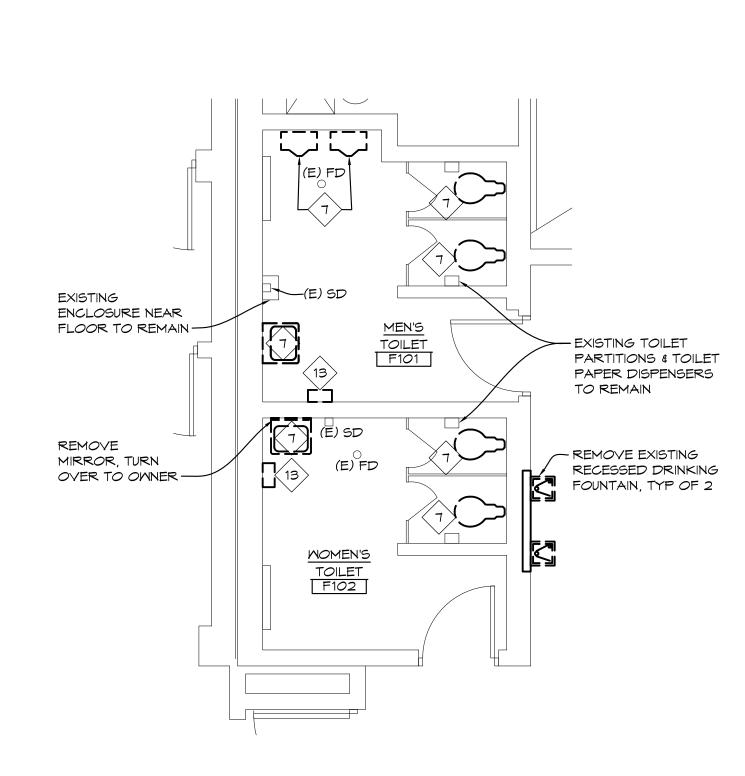

'F' WING TOILET ROOMS ENLARGED PLAN 1/4" = 1'-0" ×O1

REMOVE PORTION OF EXISTING MASONRY WALL ASSEMBLY

DEMOLITION NOTES

- 2. REMOVE WOOD DOOR AND H.M. FRAME ASSEMBLY. REMOVE SECURITY BOOT, STORAGE CASE AND IN-FLOOR SLEEVE AND TURN OVER TO OWNER.
- 3. REMOVE EXISTING PLUMBING FIXTURES, SALVAGE FOR

REINSTALLATION

- 4. REMOVE TOILET PARTITIONS, GRAB BARS, MIRRORS
- 5. REMOVE EXISTING PLYWOOD/PLASTER CEILING ASSEMBLY INCLUDING ALL CEILING MOUNTED LIGHTING, STROBES, SENSORS, ETC.
- 6. REMOVE WALL MOUNTED LIGHT FIXTURE REMOVE EXISTING PLUMBING FIXTURE, EXISTING WALL
- BRACKET TO REMAIN
- 9. EXISTING COVED QUARRY TILE WALL BASE TO REMAIN

8. EXISTING TERRAZZO FLOORING TO REMAIN

- 10. EXISTING CONVECTION UNIT HEATER TO REMAIN. REMOVE
- AND REPLACE UNIT COVER, RE: MECHANICAL PLANS 11. SAW CUT AND REMOVE PORTION OF EXISTING TERRAZZO FLOORING AND CONCRETE SUBFLOOR AS REQUIRED
- FOR NEW UNDER FLOOR PLUMBING, RE: PLUMBING DRAWINGS 12. SAW CUT AND REMOVE PORTION OF EXISTING MASONRY
- WALL AS REQUIRED FOR NEW DOOR FRAME ASSEMBLY. EXISTING MASONRY LINTEL ABOVE TO REMAIN, REMOVE & REINSTALL EXISTING WOOD TRIM ABOVE DOOR HEAD AS REQUIRED (PAINT TO MATCH EXISTING)
- 13. REMOVE EXISTING TOILET PAPER DISPENSERS, SOAP DISPENSERS, AND PAPER TOWER DISPENSERS, SALVAGE FOR REINSTALLATION, TURN OVER EXTRAS TO


DEMOLITION GENERAL NOTES


FIELD VERIFY ALL EXISTING CONDITIONS AND DIMENSIONS. NOTIFY DESIGN PROFESSIONAL OF ANY DISCREPANCIES PRIOR TO BEGINNING WORK. COORDINATE DEMOLITION WORK WITH NEW WORK SHOWN

ELECTRICAL TRADES. VERIFY EXACT SIZE AND LOCATION

- 2. OWNER HAS FIRST RIGHT OF REFUSAL ON ALL MATERIAL AND EQUIPMENT BEING REMOVED 3. COORDINATE ALL WORK WITH MECHANICAL AND
- OF ALL WALL, FLOOR AND ROOF OPENINGS REQUIRED OF THESE AND OTHER TRADES. 4. REPAIR ALL WALLS, FLOORS AND CEILINGS AT ALL
- AREAS DISTURBED BY DEMOLITION TO MATCH EXISTING FINISHES, UNLESS NOTED OTHERWISE. COORDINATE WITH
- MECHANICAL AND ELECTRICAL TRADES. 5. AT AREAS OF DEMOLITION, CONTRACTOR IS RESPONSIBLE FOR REMOVING, CAPPING AND DISCONNECTING ALL INCIDENTAL ITEMS.
- 6. CONTRACTOR SHALL BE RESPONSIBLE FOR PROVIDING ALL NECESSARY TEMPORARY BRACING AND/OR SHORING REQUIRED TO MAINTAIN THE INTEGRITY AND STRUCTURAL STABILITY OF THE BUILDING AND IT'S
- ELEMENTS. 1. CONTRACTOR SHALL PROVIDE TEMPORARY PROTECTION FOR ALL COMPONENTS OF THE BUILDING DURING CONSTRUCTION TO PREVENT DAMAGE,
- INCLUDING WEATHERPROOFING AT ALL OPENINGS. 8. NOTATIONS ARE MADE IN VARIOUS PLACES ON THE DRAWING TO CALL ATTENTION TO DEMOLITION WHICH IS REQUIRED, HOMEVER, THESE DRAWINGS ARE NOT INTENDED TO SHOW EACH AND EVERY ITEM TO BE REMOVED. THE CONTRACTOR AND THE SUBCONTRACTORS FOR THE VARIOUS TRADES SHALL REMOVE THE MATERIALS RELATED TO THEIR
- RESPECTIVE TRADES ASA REQUIRED TO PERMIT THE CONSTRUCTION OF THE NEW WORK AS SHOWN. 9. SEE MECHANICAL AND ELECTRICAL DRAWINGS FOR
- ADDITIONAL DEMOLITION WORK. 10. REFER TO SHEET A602 FOR GENERAL NOTES REGARDING DEMOLITION AND NEW CONSTRUCTION 11. CONTRACTOR TO FIELD VERIFY ALL EXISTING MOUNTING BRACKETS TO BE REUSED AND NOTIFY DESIGN

PROFESSIONAL OF ANY DEFICIENCY

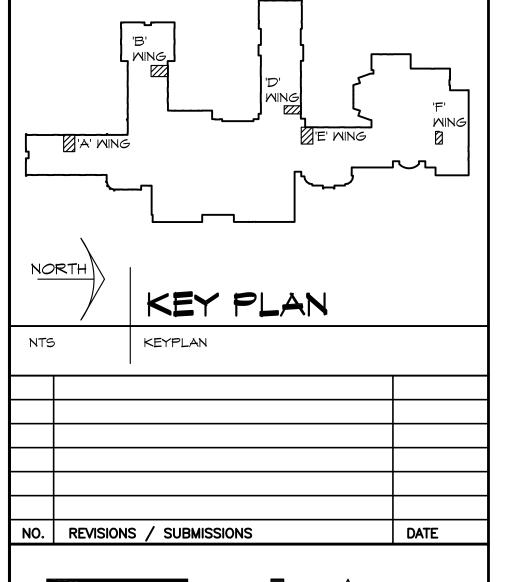

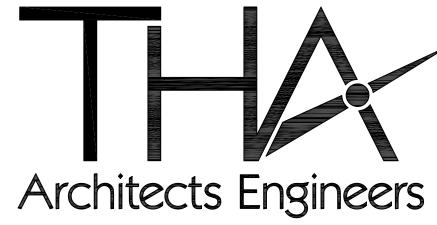

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PROJECT 'A' RENOVATIONS TO:

BULLOCK CREEK HIGH SCHOOL

1420 SOUTH BADOUR ROAD


MIDLAND, MI


DRAWING TITLE

THA Architects Engineers - P:\Bullock C
Plot date: 10/22/2024 10:45 AM


TOILET ROOM DEMOLITION PLANS

SEAL	DRAWN KRS	PROJECT NO. 24-12 <i>0</i>
	CHECKED JESS	CAD FILE NO. A-A101
	REVIEWED MLB	DRAWING NO.
	DATE OCT 18, 2024	A-A101
	SCALE AS NOTED	SHEET NO. 2 OF 15

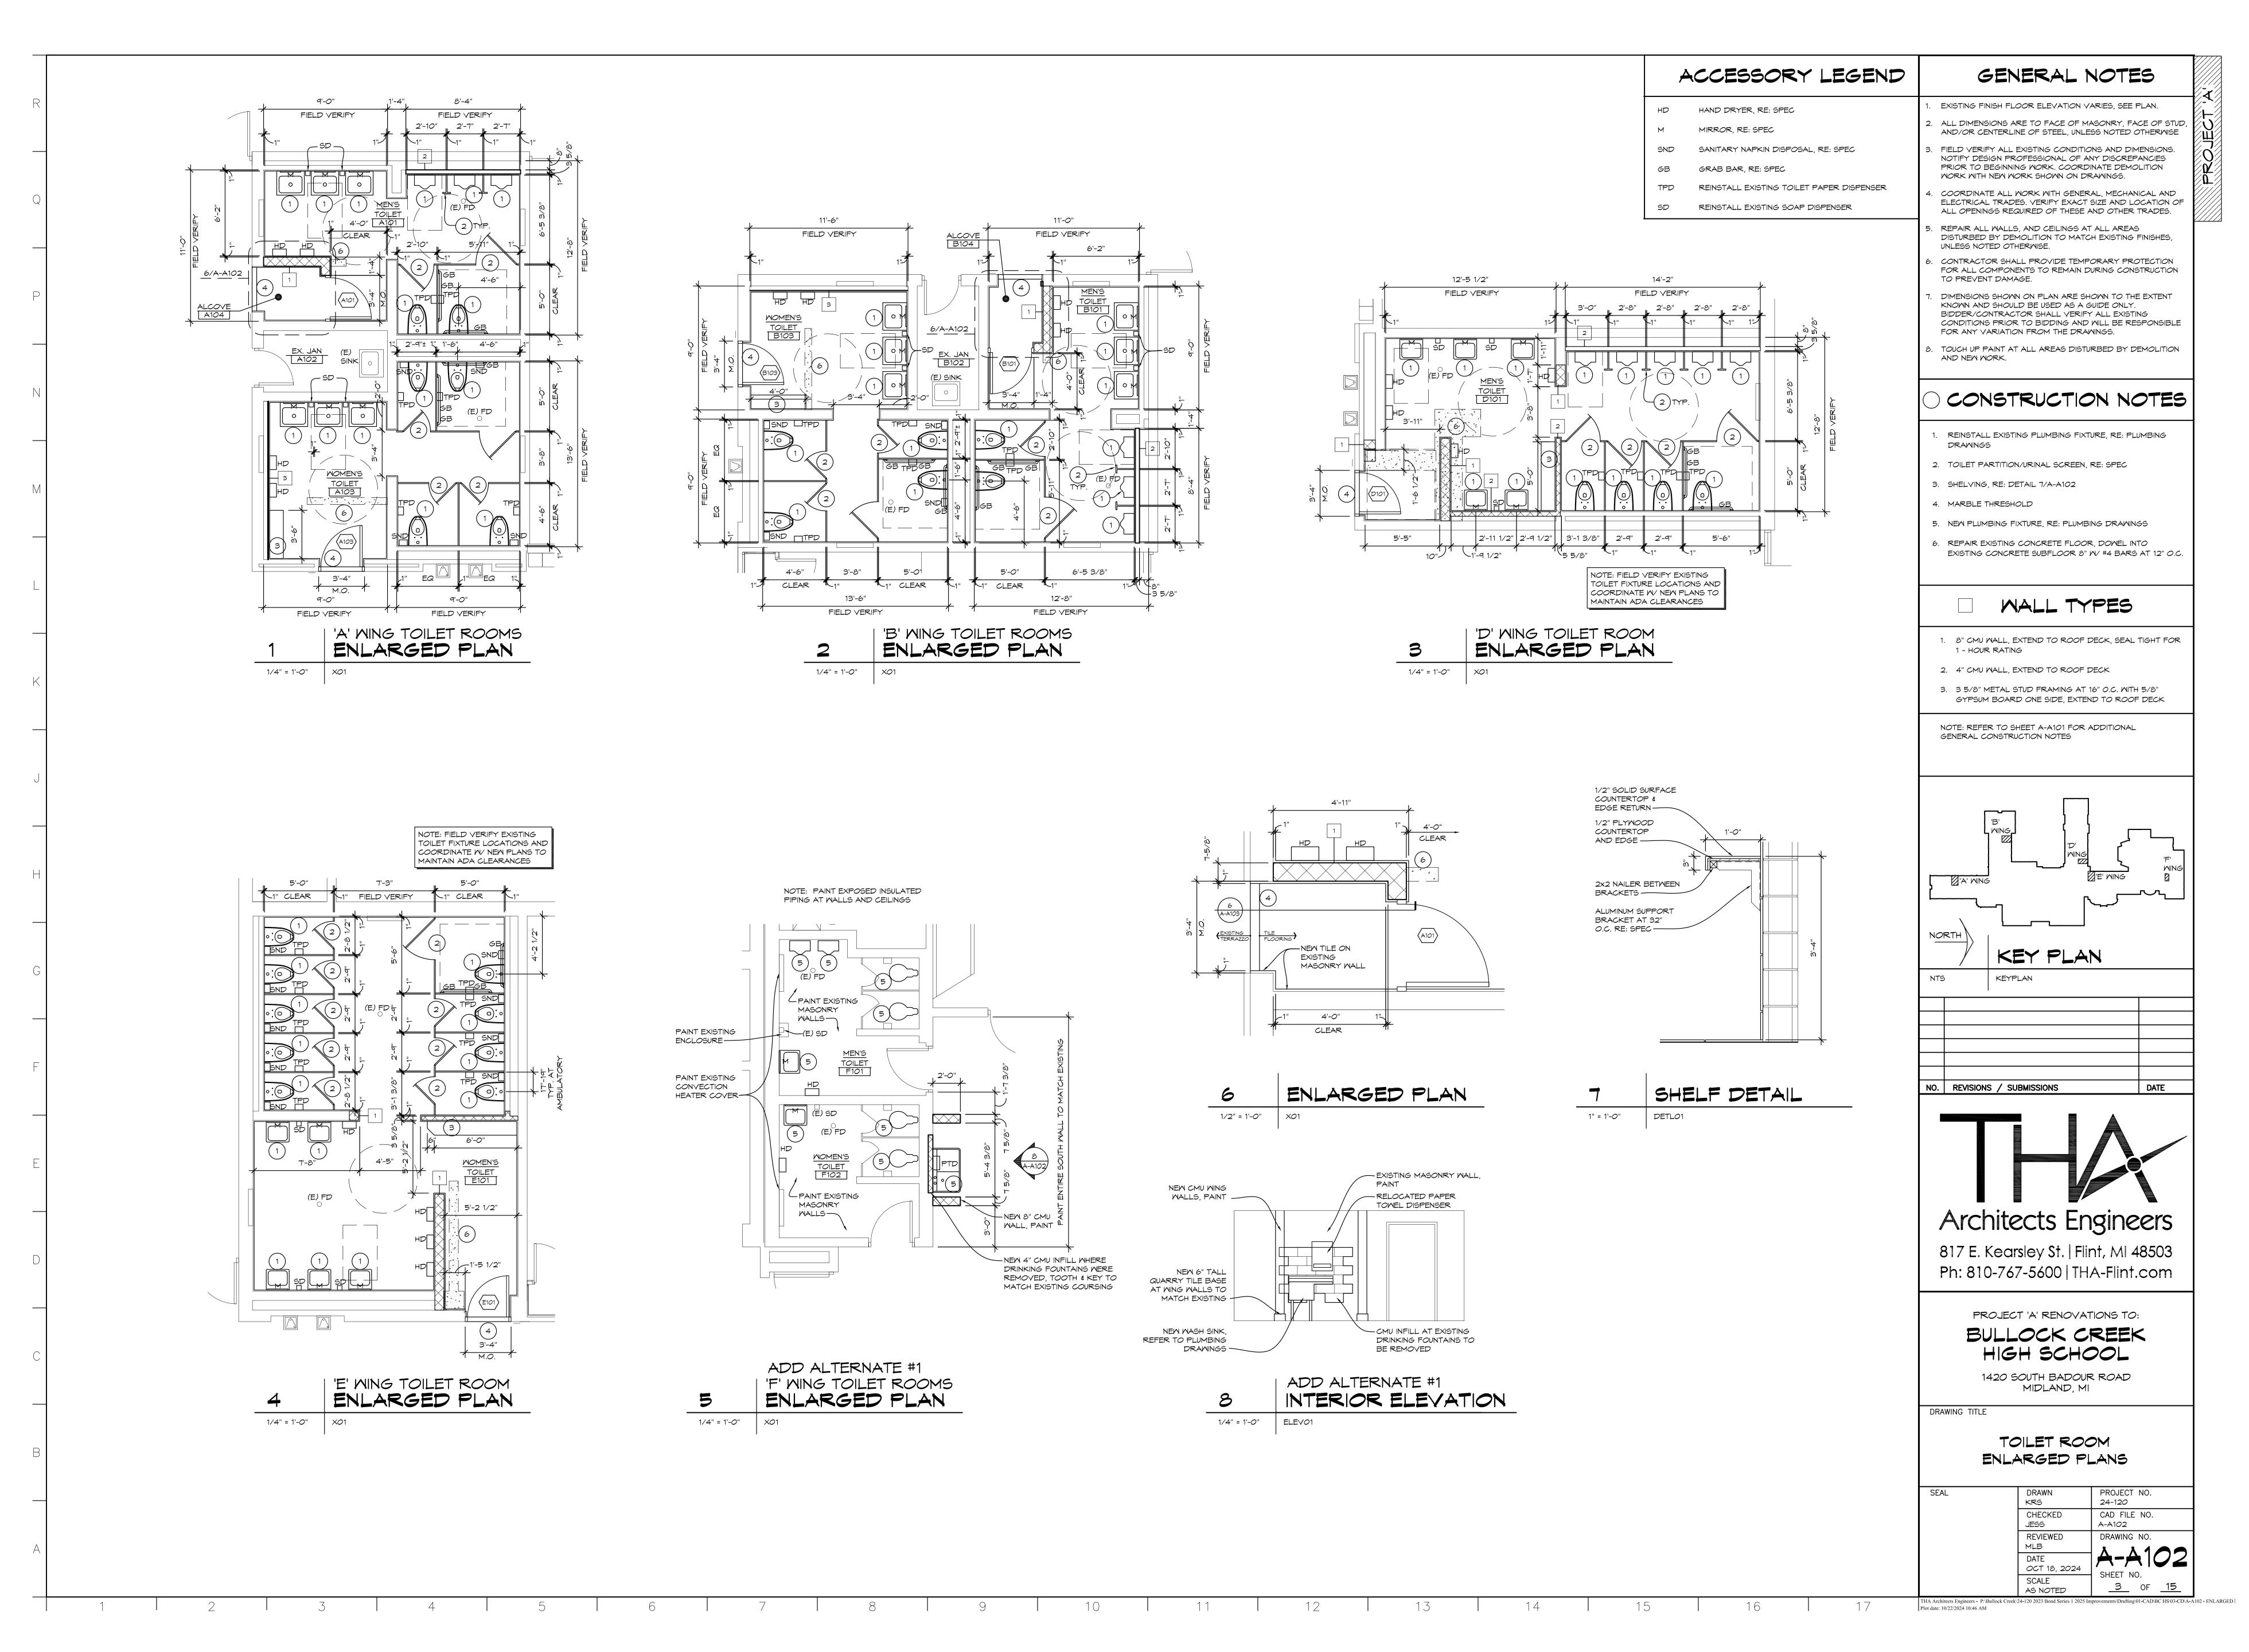


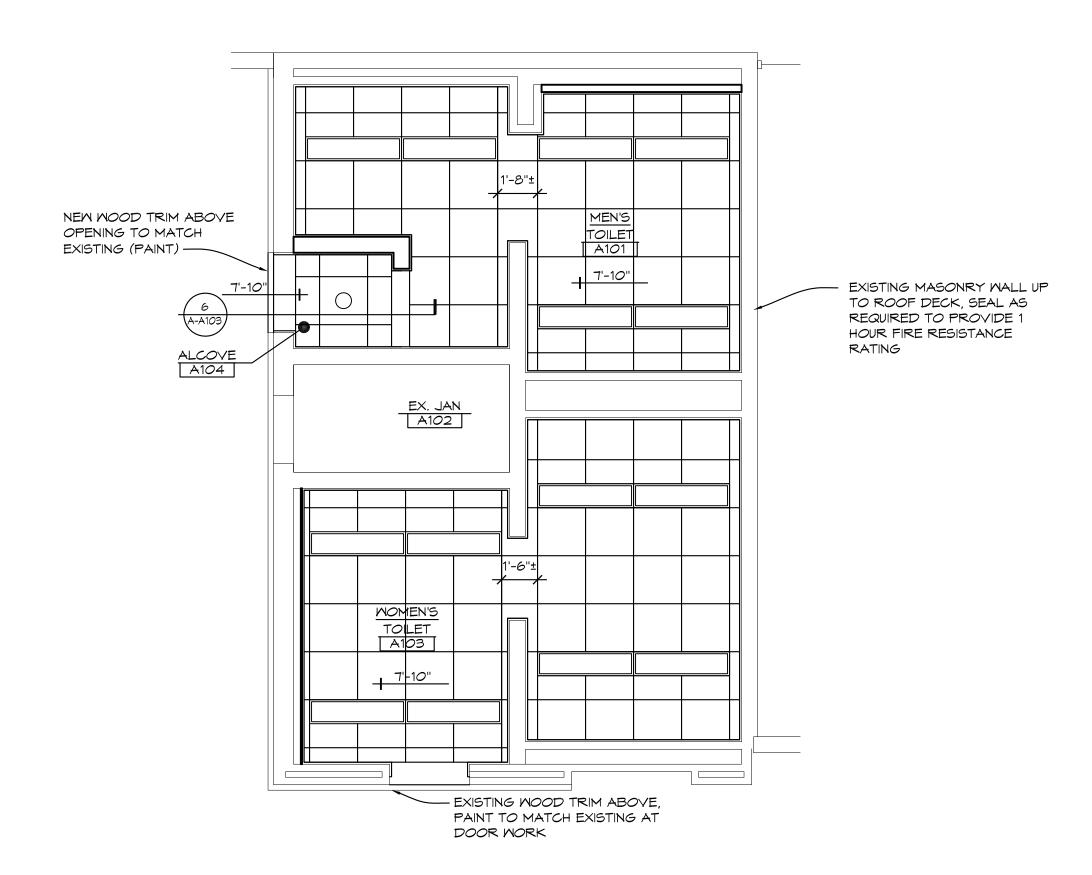


'A' WING TOILET ROOMS
REFLECTED CEILING PLAN 1/4" = 1'-0" ×01

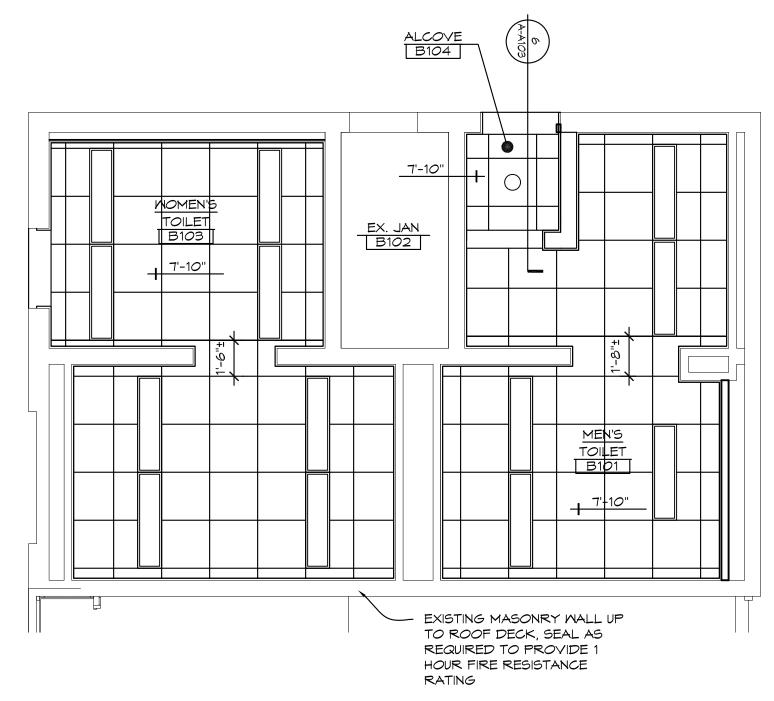


'B' WING TOILET ROOMS REFLECTED CEILING PLAN 1/4" = 1'-0" XO1

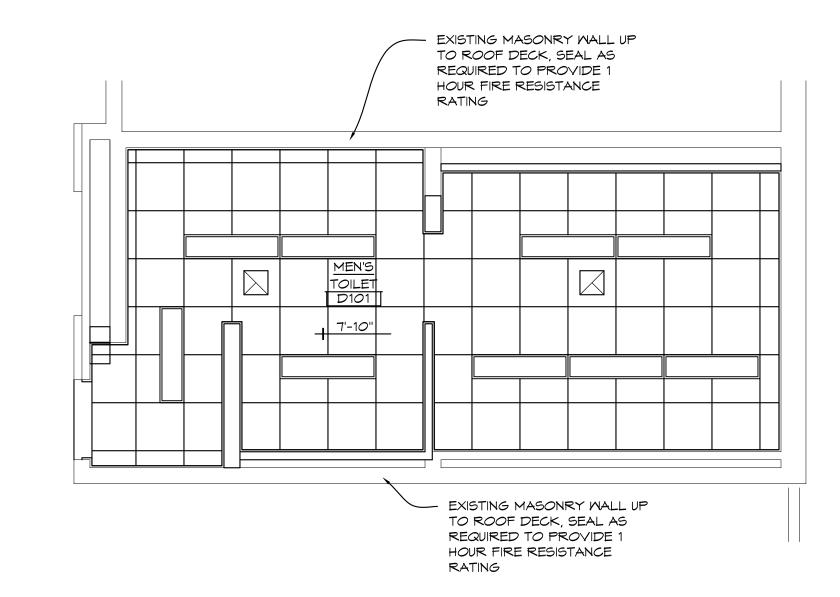


'D' WING TOILET ROOM REFLECTED CEILING PLAN 1/4" = 1'-0" XO1

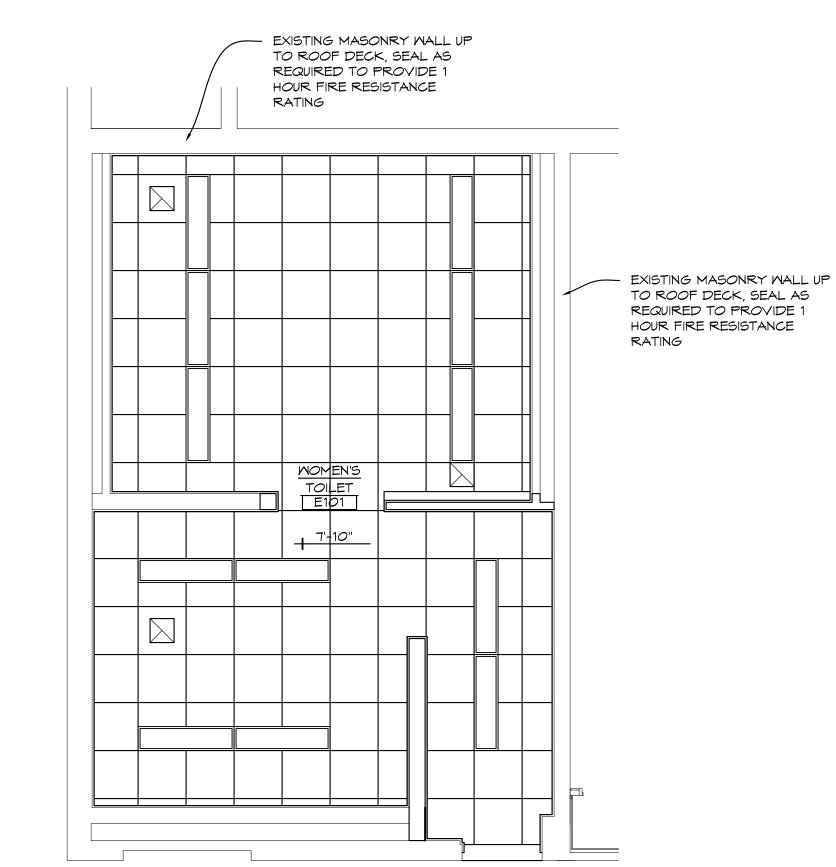

'E' WING TOILET ROOM
REFLECTED CEILING PLAN 1/4" = 1'-0" ×01

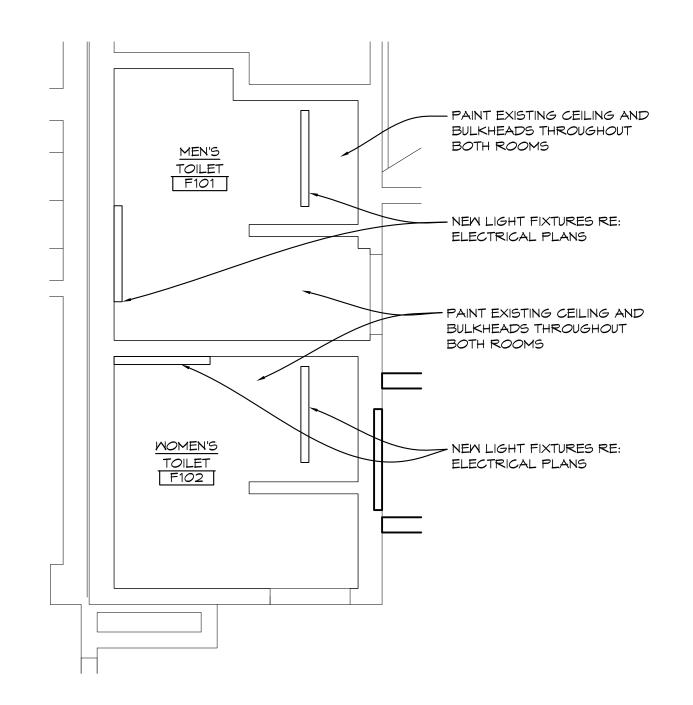

ADD ALTERNATE #1 'F' WING TOILET ROOMS REFLECTED CEILING PLAN 1/4" = 1'-0"

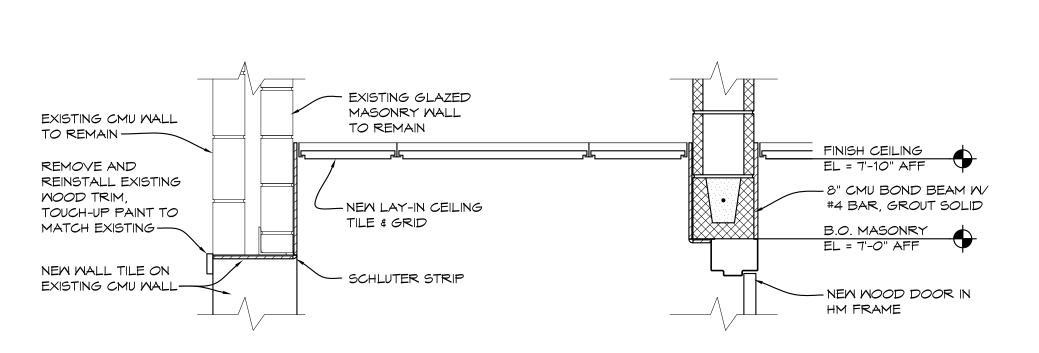

BULKHEAD DETAIL DETLO2 1" = 1'-0"

GENERAL NOTES

- EXISTING FINISH FLOOR ELEVATION VARIES, SEE PLAN.
- . ALL DIMENSIONS ARE TO FACE OF MASONRY, FACE OF STUD, AND/OR CENTERLINE OF STEEL, UNLESS NOTED OTHERWISE
- FIELD VERIFY ALL EXISTING CONDITIONS AND DIMENSIONS. NOTIFY DESIGN PROFESSIONAL OF ANY DISCREPANCIES PRIOR TO BEGINNING WORK. COORDINATE DEMOLITION WORK WITH NEW WORK SHOWN ON DRAWINGS.
- COORDINATE ALL WORK WITH GENERAL, MECHANICAL AND ELECTRICAL TRADES. VERIFY EXACT SIZE AND LOCATION OF ALL OPENINGS REQUIRED OF THESE AND OTHER TRADES.
- REPAIR ALL WALLS, AND CEILINGS AT ALL AREAS DISTURBED BY DEMOLITION TO MATCH EXISTING FINISHES, UNLESS NOTED OTHERWISE.
- CONTRACTOR SHALL PROVIDE TEMPORARY PROTECTION FOR ALL COMPONENTS TO REMAIN DURING CONSTRUCTION TO PREVENT DAMAGE.
- DIMENSIONS SHOWN ON PLAN ARE SHOWN TO THE EXTENT KNOWN AND SHOULD BE USED AS A GUIDE ONLY. BIDDER/CONTRACTOR SHALL VERIFY ALL EXISTING CONDITIONS PRIOR TO BIDDING AND WILL BE RESPONSIBLE
- TOUCH UP PAINT AT ALL AREAS DISTURBED BY DEMOLITION AND NEW MORK.

FOR ANY VARIATION FROM THE DRAWINGS.

CEILING LEGEND


2X2 SUSPENDED LAY-IN CEILING W/ HOLD DOWN CLIPS

NEW 1x4 LIGHT FIXTURE, RE: ELECTRICAL PLANS

> NEW DOWNLIGHT FIXTURE, RE: ELECTRICAL PLANS

NEW SURFACE MOUNTED LIGHT FIXTURE, RE: ELECTRICAL PLANS

NEW EXHAUST GRILLE RE: MECHANICAL PLANS

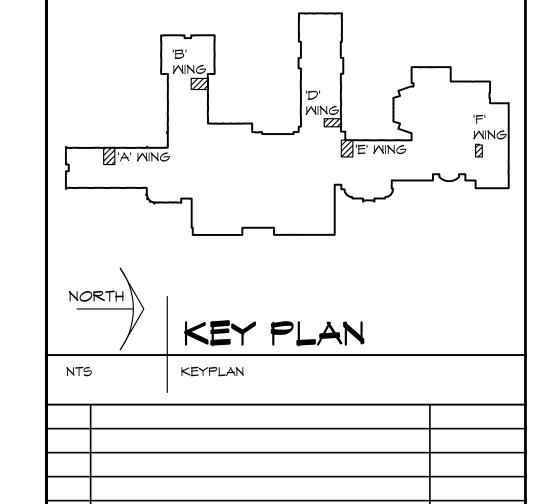

NO. REVISIONS / SUBMISSIONS DATE Architects Engineers

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> PROJECT 'A' RENOVATIONS TO: BULLOCK CREEK

HIGH SCHOOL

1420 SOUTH BADOUR ROAD MIDLAND, MI

DRAWING TITLE

TOILET ROOM REFLECTED CEILING PLANS


PROJECT NO. KRS 24-120 CHECKED CAD FILE NO. **JESS** A-A103 REVIEWED DRAWING NO. OCT 18, 2024 SCALE <u>4</u> of <u>15</u>

AS NOTED


THA Architects Engineers - P:\Bullock Creek\24-120 2023 Bond Series 1 2025 Improv Plot date: 10/22/2024 10:50 AM

	DOOR & FRAME SC						E SC	HE	DL	ルビ	
\exists		D00	R			FF	RAME				
	DOOR NO.	SIZE	TYPE	MATERIAL	TYPE	MATERIAL	HEAD	LAMB B	FIRE RATING (IN MINUTES)	HARDWARE	NOTES
	A101	3'-0" × 6'-8"	А	ND	2	НМ	3/A-A601	4 \$ 5/A-A601	0	07	1
	A103	3'-0" × 6'-8"	А	ND	1	нм	1/A-A601	2/A-A601	0	08	1
E	B101	3'-0" × 6'-8"	А	ND	2	нм	3/A-A601	4 \$ 5/A-A601	0	07	1
Ð	B103	3'-0" × 6'-8"	А	ND	1	нм	1/A-A601	2/A-A601	0	08	1
	D101	3'-0" × 6'-8"	А	ND	1	НМ	1/A-A601	2/A-A601	0	07	1
Ī	E101	3'-0" × 6'-8"	А	ND	1	нм	1/A-A601	2/A-A601	0	07	1



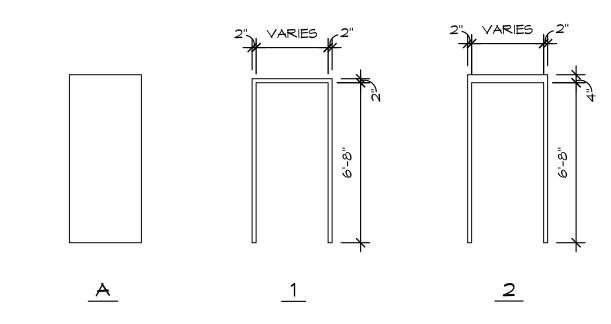

	DOOR AND FRAME ELEVATIONS
1/4" = 1'-0"	

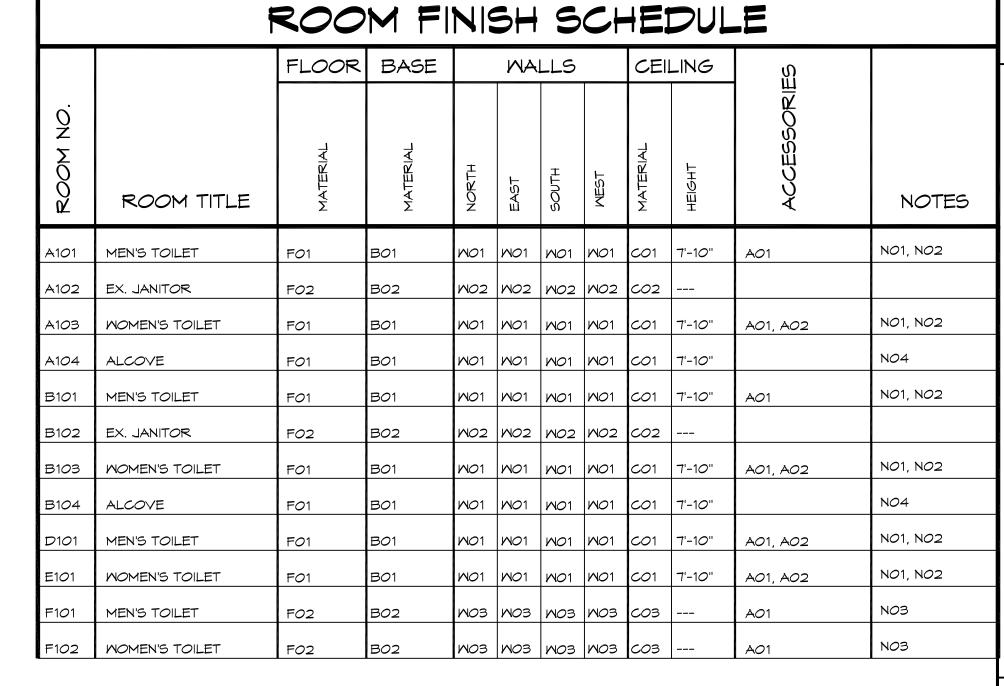

ROOM FINISH LEGEND FLOOR FOI PORCELAIN TILE OVER EXISTING TERAZZO FLOOR FO2 EXISTING BASE BO1 6" PORCELAIN TILE BO2 EXISTING NO1, NO2 WALLS WO1 PORCELAIN TILE, RE: 6/A-A601 WO2 EXISTING WO3 PAINT EXISTING MASONRY NO1, NO2 CEILING CO1 2x2 LAY-IN CEILING TILE CO2 EXISTING CO3 EXISTING CO3 EXISTING CONC. PAINT ACCESSORIES AO1 TOILET ROOM ACCESSORIES, RE: SPEC AO2 SHELF, RE: T/A-A102 NO1, NO2 NO1 NO2 NO1 REMOVE EXISTING CONVECTION HEATER UNIT COVERS

NO1 REMOVE EXISTING CONVECTION HEATER UNIT COVERS
AND INSTALL NEW, RE: MECHANICAL PLANS

NO2 REINSTALL EXISTING FIRE ALARM NOTIFICATION DEVICES

NO3 PAINT EXISTING CONVECTION HEATER UNIT COVERS

NO4 PAINT HEADER WHERE EXISTING DOOR WAS REMOVED

GENERAL NOTES

ALL DIMENSIONS ARE TO FACE OF MASONRY, FACE OF STUD

AND/OR CENTERLINE OF STEEL, UNLESS NOTED OTHERWISE

FIELD VERIFY ALL EXISTING CONDITIONS AND DIMENSIONS.

NOTIFY DESIGN PROFESSIONAL OF ANY DISCREPANCIES

PRIOR TO BEGINNING WORK. COORDINATE DEMOLITION

MORK MITH NEW MORK SHOWN ON DRAWINGS.


EXISTING FINISH FLOOR ELEVATION VARIES, SEE PLAN.


CORRIDOR EXISTING MASONRY MALL TO REMAIN, TOUCH-UP PAINT AS REQUIRED -REMOVE PORTION OF EXISTING MASONRY CAVITY SOLID AS REQUIRED TO —NEM MALL TILE INSTALL NEW STEEL LINTEL. INSTALL NEW - REMOVE PORTION OF CMU SOAP COURSE -EXISTING MASONRY AS REQUIRED TO INSTALL N STEEL LINTEL. INSTALL N CMU SOAP COURSE HOLLOW METAL —NEW SCHLUTER FRAME ---


-NEW STEEL LINTEL,


LINTEL SIZING

RE: SPEC FOR TYPICAL

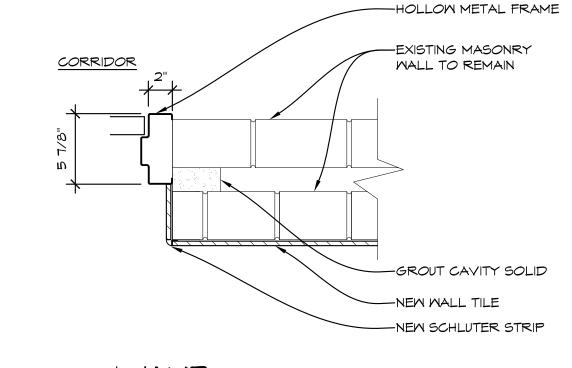

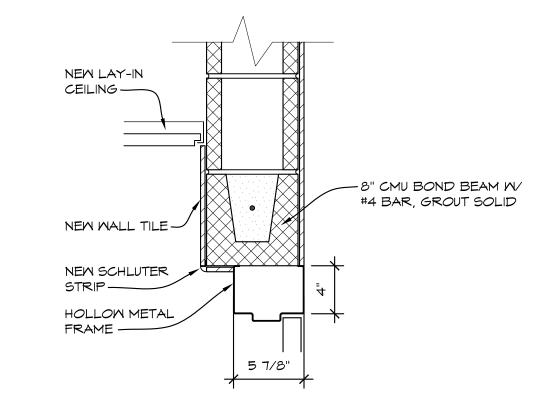

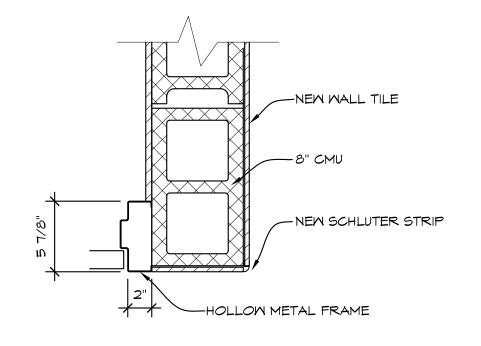

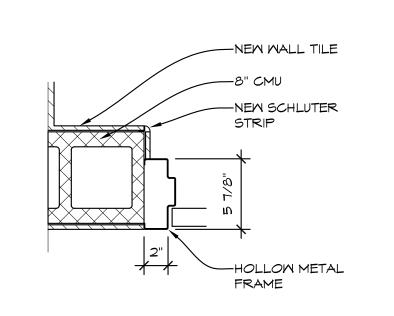

4.	COORDINATE ALL WORK WITH GENERAL, MECHANICAL AND ELECTRICAL TRADES. VERIFY EXACT SIZE AND LOCATION OF ALL OPENINGS REQUIRED OF THESE AND OTHER TRADES.
_	PEDAID ALL MALLS AND CELLINGS AT ALL AREAS

REPAIR ALL WALLS, AND CEILINGS AT ALL AREAS
DISTURBED BY DEMOLITION TO MATCH EXISTING FINISHES,
UNLESS NOTED OTHERWISE.

 CONTRACTOR SHALL PROVIDE TEMPORARY PROTECTION FOR ALL COMPONENTS TO REMAIN DURING CONSTRUCTION TO PREVENT DAMAGE.

7. DIMENSIONS SHOWN ON PLAN ARE SHOWN TO THE EXTENT KNOWN AND SHOULD BE USED AS A GUIDE ONLY.
BIDDER/CONTRACTOR SHALL VERIFY ALL EXISTING CONDITIONS PRIOR TO BIDDING AND WILL BE RESPONSIBLE FOR ANY VARIATION FROM THE DRAWINGS.

TOUCH UP PAINT AT ALL AREAS DISTURBED BY DEMOLITION AND NEW WORK.




5 7/8"











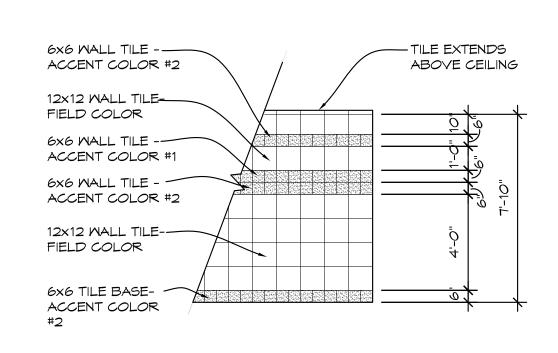


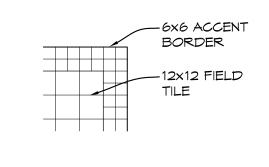





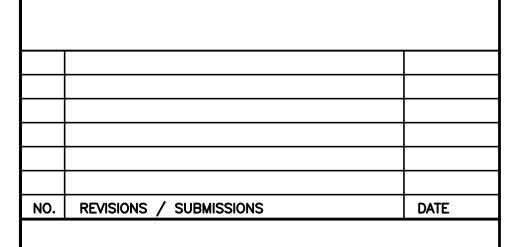

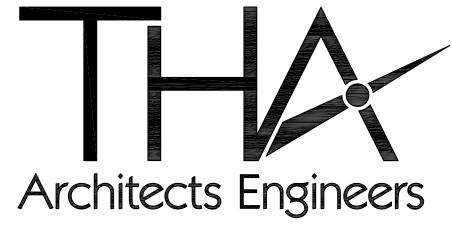

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PROJECT 'A' RENOVATIONS TO:
BULLOCK CREEK

HIGH SCHOOL


1420 SOUTH BADOUR ROAD


MIDLAND, MI


DOOR SCHEDULES,
ROOM FINISH SCHEDULE,
& DETAILS

SEAL	DRAWN KRS	PROJECT NO. 24-12 <i>0</i>
	CHECKED JESS	CAD FILE NO. A-A601
	REVIEWED MLB	DRAWING NO.
	DATE OCT 18, 2024	A-A601 SHEET NO.
	SCALE AS NOTED	5 OF 15


<u>p</u> <u>p</u> <u>w</u>	39"-41" 20
TOILET - MALL HUNG	

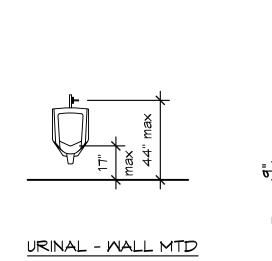


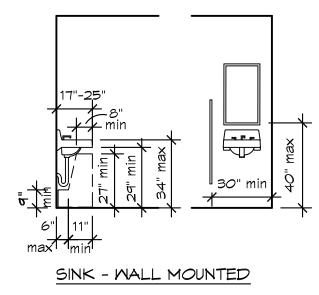

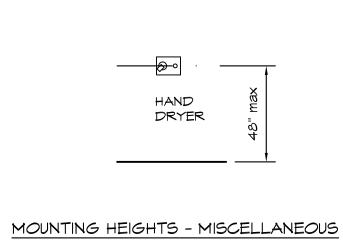



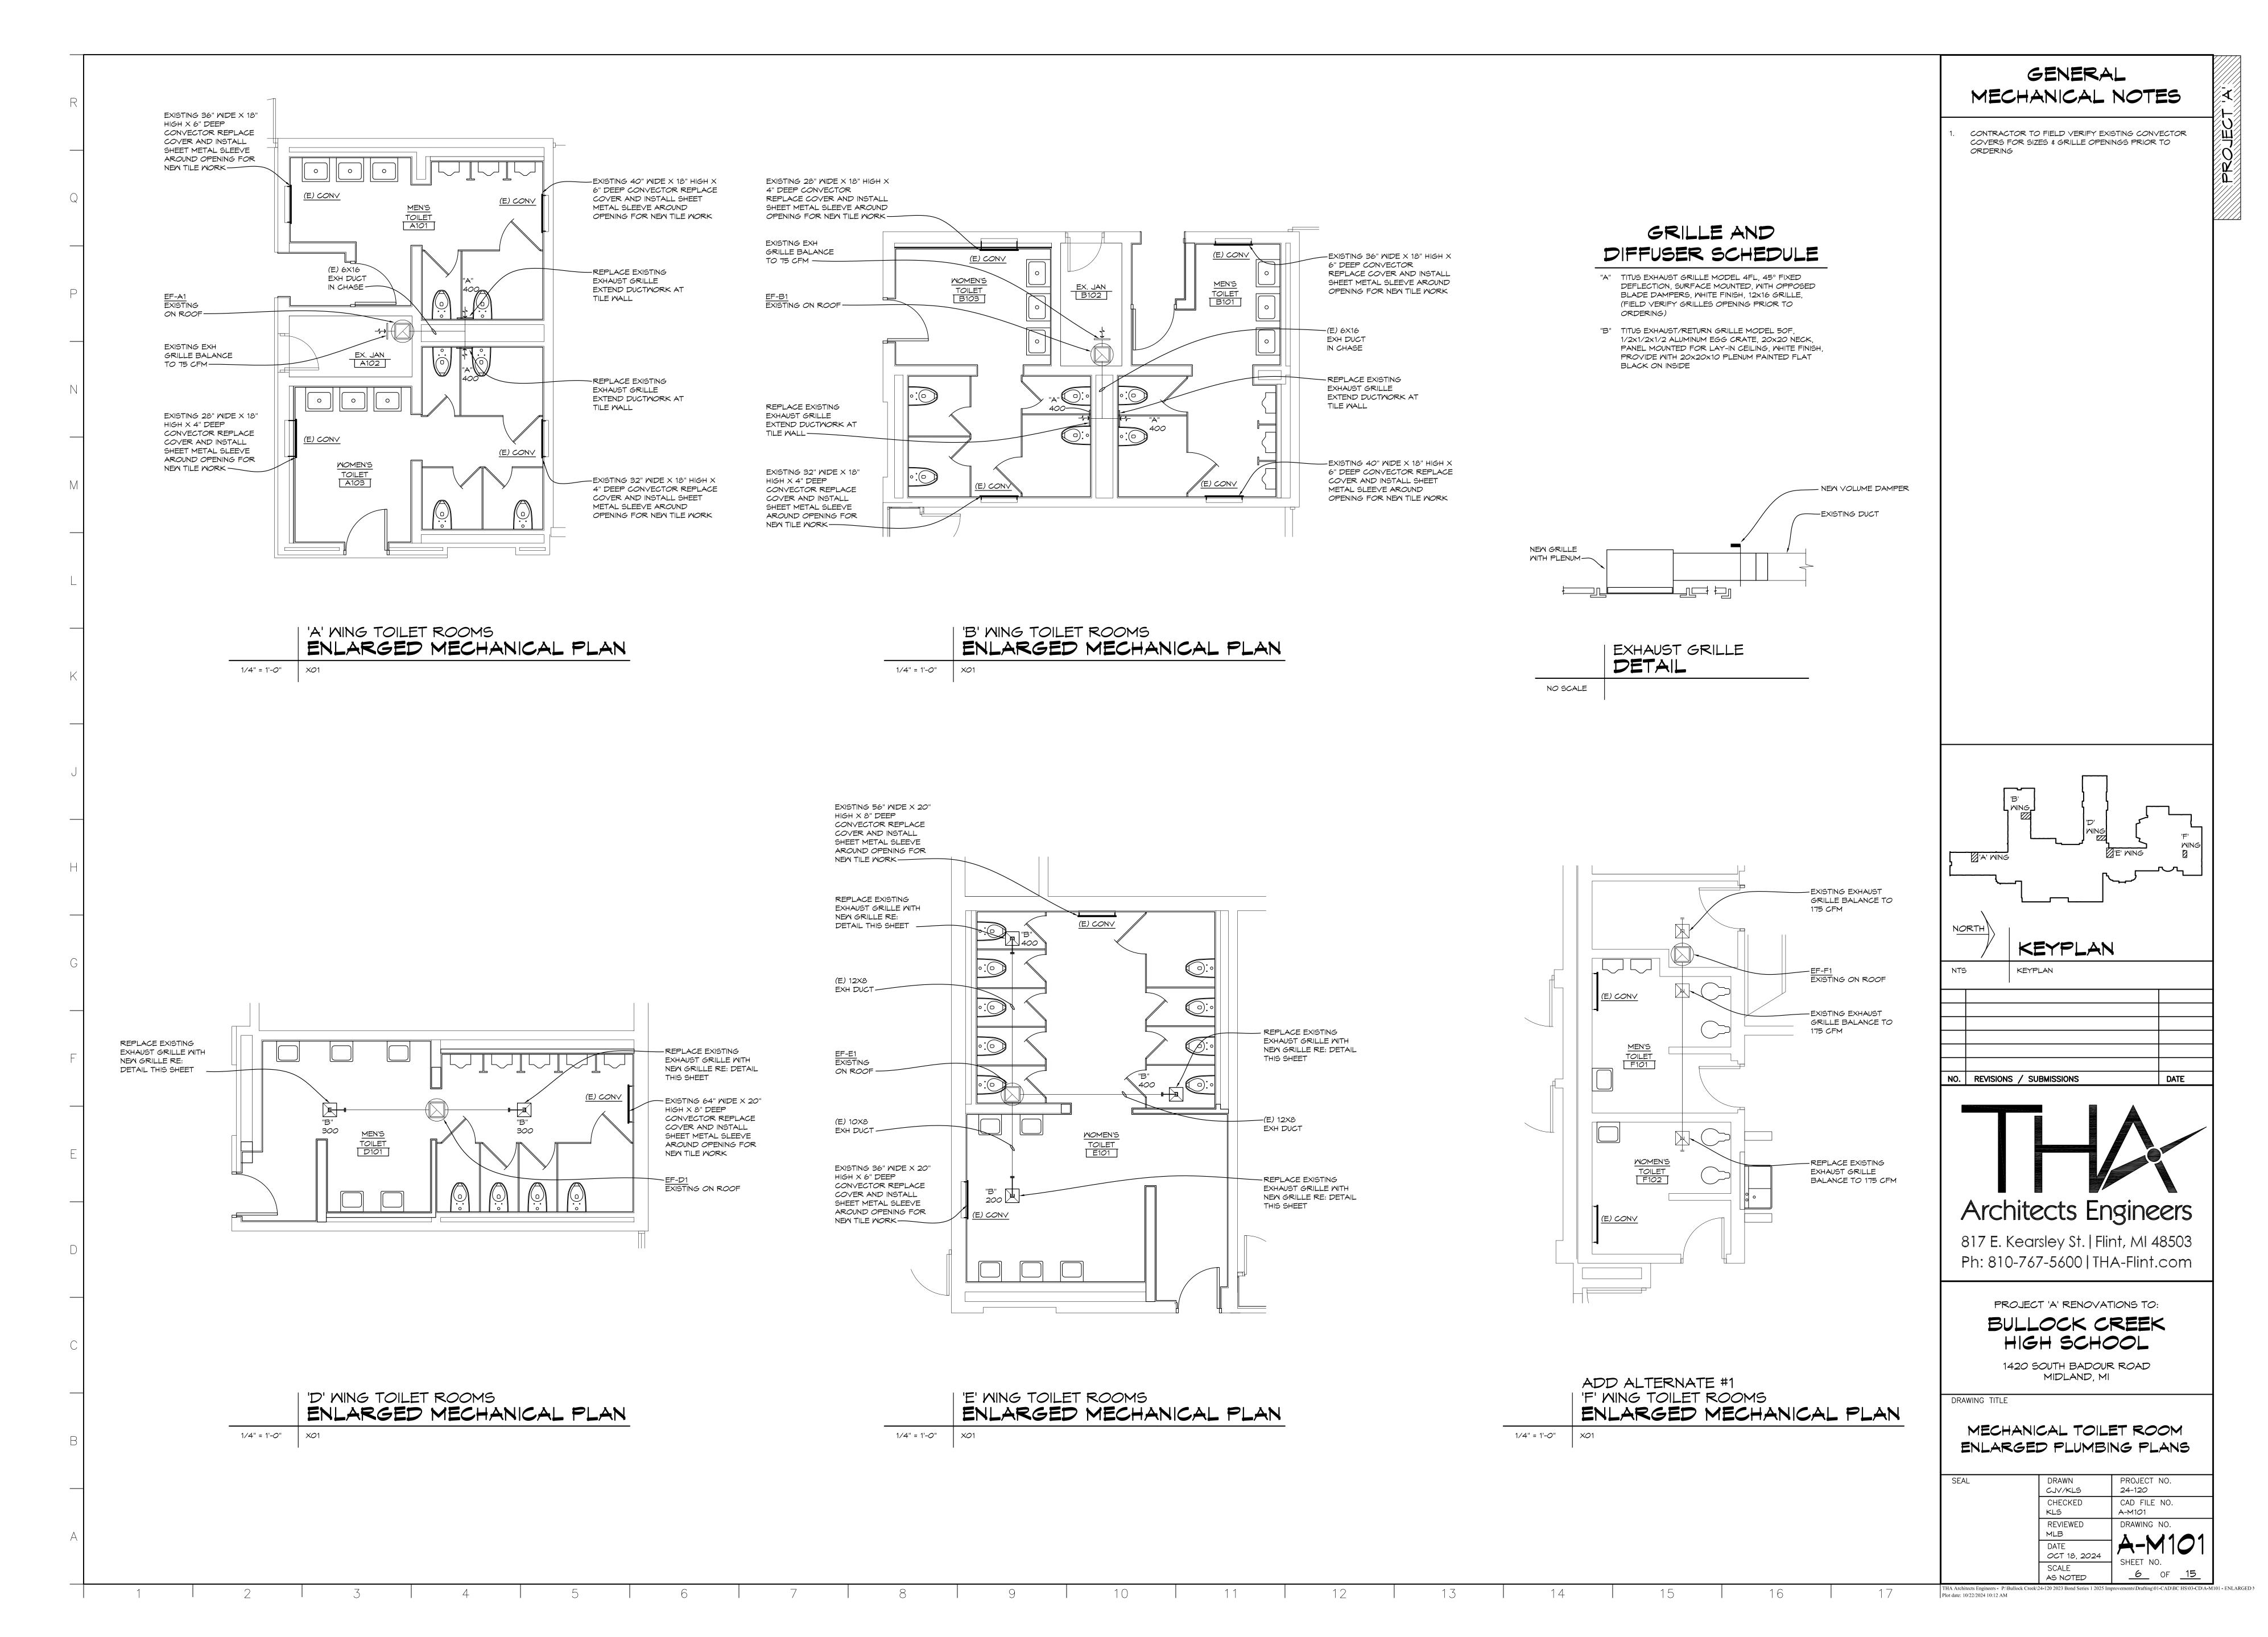


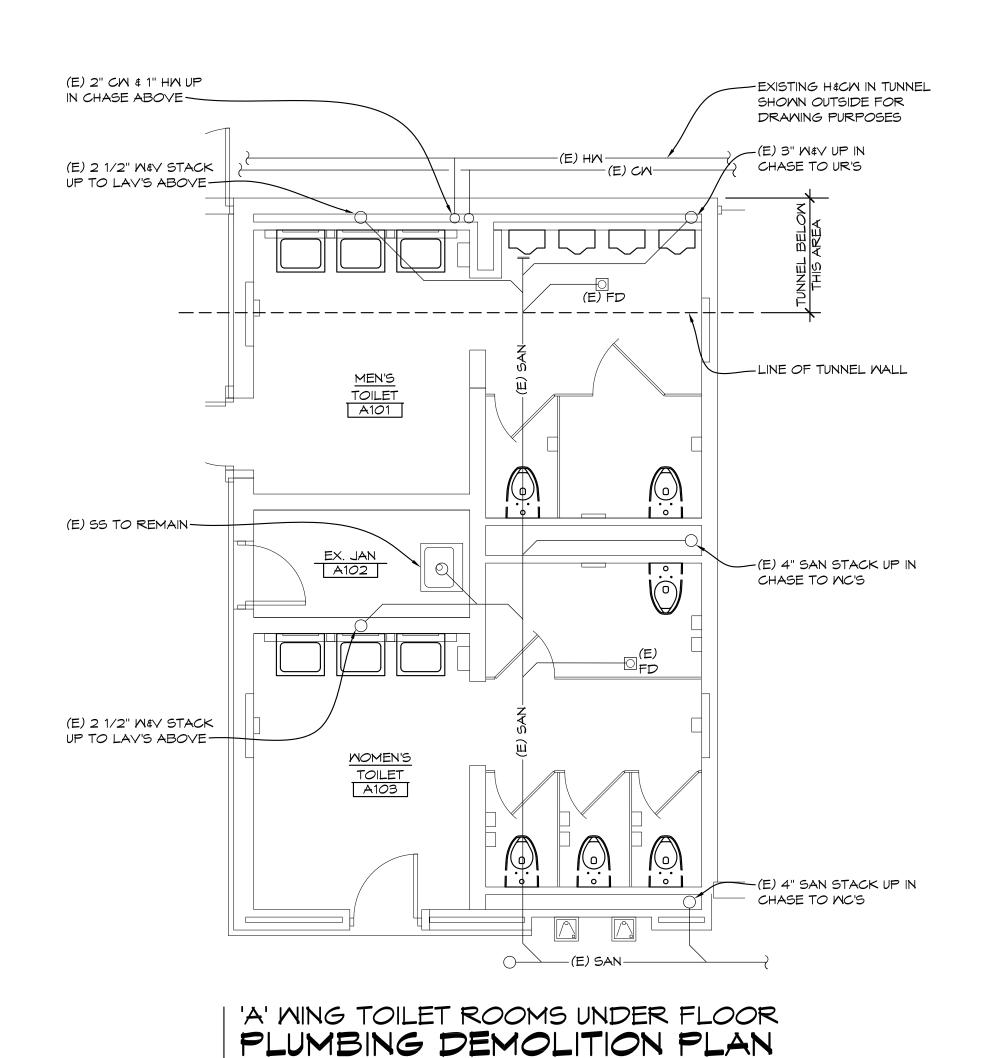


1/4" = 1'-0" XO1

W&V

MASTE & VENT

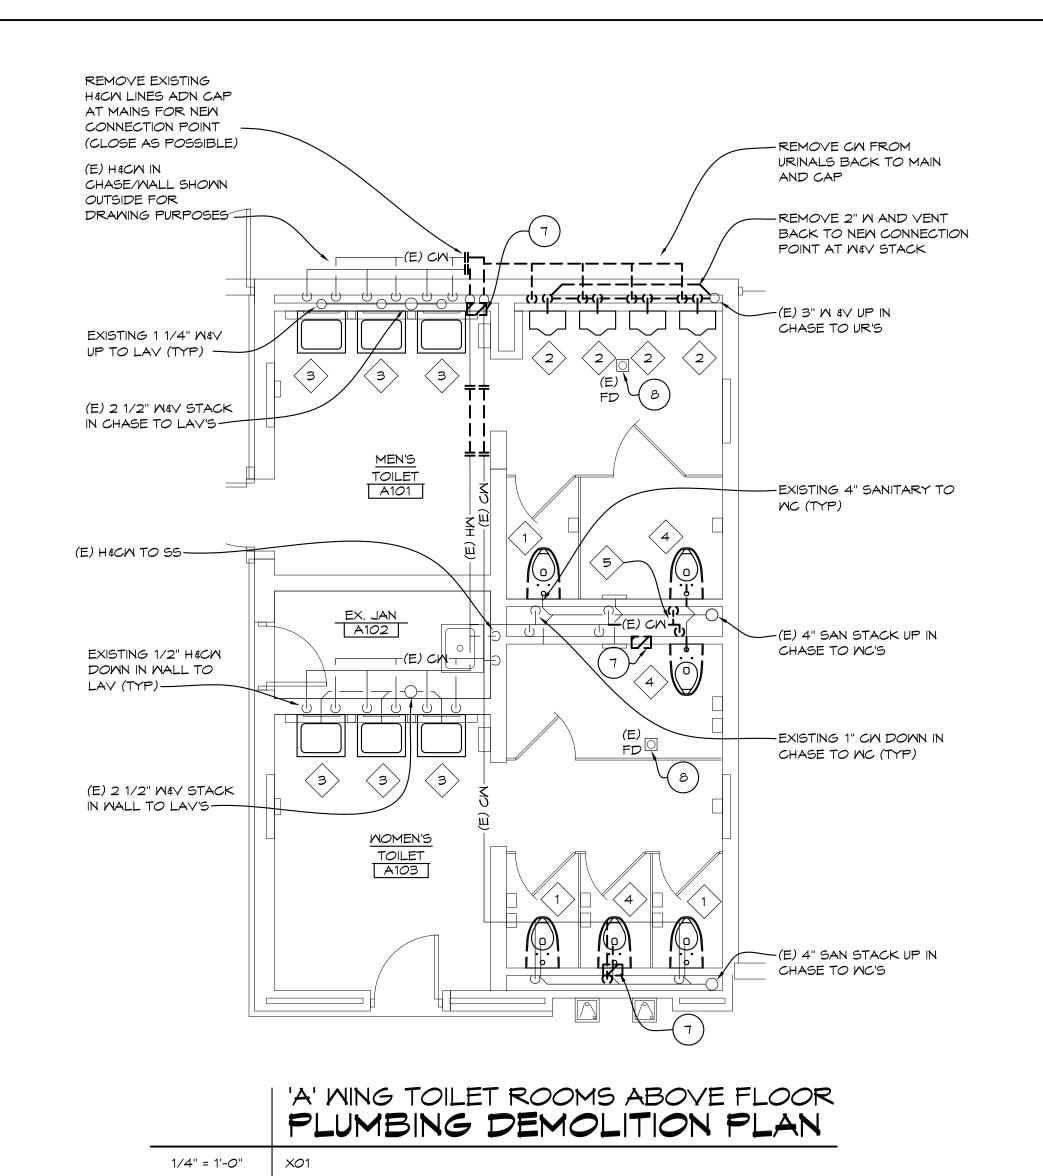

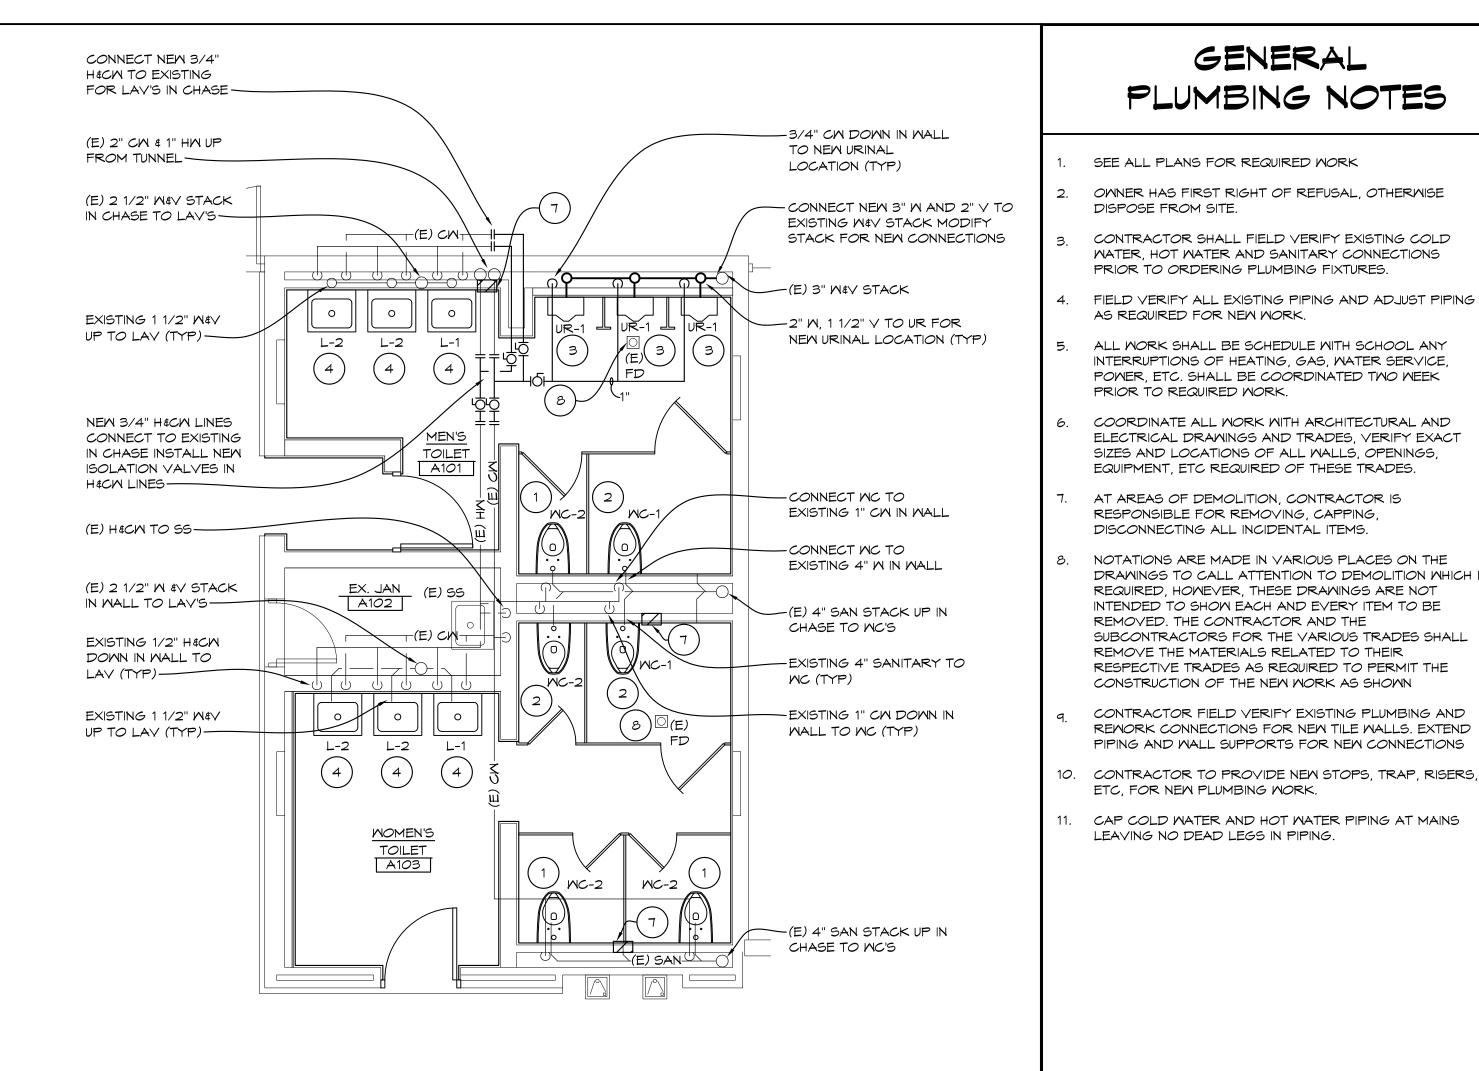

'A' WING TOILET ROOMS ABOVE FLOOR ENLARGED PLUMBING PLAN

1/4" = 1'-0" XO1

PLUMBING FIXTURE SCHEDULE

MC-1 (PH) (SEE GENERAL NOTES) EXISTING WATER CLOSET, 3-BOLT WALL MOUNTED, REINSTALL WATER CLOSET & FLUSH VALVE AT PH HEIGHT, REMORK CARRIER, BOLTS, HEIGHT (WHERE REQUIRED FOR PH), EXTEND CM FOR NEW TILE WORK AND INSTALL EXISTING FLUSH VALVE

MC-2 EXISTING WATER CLOSET, 3-BOLT WALL MOUNTED, REINSTALL WATER CLOSET & FLUSH VALVE AT PH HEIGHT, REMORK CARRIER, BOLTS, EXTEND CM FOR NEW TILE WORK AND INSTALL EXISTING FLUSH VALVE

MC-3 NEW WATER CLOSET - AMERICAN STANDARD MODEL "MADERA" - 2234.001, 15" HIGH, SIPHON JET VITREOUS CHINA, ELONGATED BOWL. PROVIDE MANUAL FLUSH VALVE ZURN MODEL Z6000AV, ALL METAL, DUAL SEAL DIAPHRAGM, BEMIS SEAT MODEL 1955SSCT, WHITE OPEN FRONT, SELF-SUSTAINING HINGE.

NEW URINAL AMERICAN STANDARD MODEL "WASHBROOK" 6590.001, WALL HUNG, VITREOUS CHINA 3/4" TOP SPUD, WHITE, WASH OUT URINAL, INTEGRAL TRAP. PROVIDE WITH MANUAL FLUSH VALVE ZURN MODEL Z6003-WS1, ALL METAL, DUAL SEAL DIAPHRAGM, 1.0 GALLON FLUSH, STOP, VACUUM BREAKER, ETC. PROVIDE CARRIER & HANGERS FOR SUPPORT.

<u>UR-2</u> NEM URINAL AMERICAN STANDARD MODEL "WASHBROOK" 6590.001, WALL HUNG, VITREOUS CHINA, 3/4" TOP SPUD, WHITE, WASH OUT URINAL, INTEGRAL TRAP. PROVIDE WITH MANUAL FLUSH VALVE ZURN MODEL Z6003-MS1, ALL METAL, DUAL SEAL DIAPHRAGM, 1.0 GALLON FLUSH, STOP, VACUUM BREAKER, ETC. REMORK EXISTING WALL SUPPORTS & SANITARY CONNECTION.

EXISTING LAVATORY AMERICAN STANDARD "LUCERNE" MODEL 0355.012, WALL MOUNTED, VITREOUS CHINA, 4" CENTERS. PROVIDE NEW AMERICAN STANDARD FAUCET MODEL 6114.116.002

L-2
EXISTING LAVATORY AMERICAN STANDARD "LUCERNE" MODEL 0355.012, WALL MOUNTED, VITREOUS CHINA, 4" CENTERS. EXISTING AMERICAN STANDARD FAUCET MODEL 6114.116.002. REINSTALL & PROVIDE WITH NEW STOPS, RISERES, TRAP, ETC. REMORK (EXTEND FOR NEW TILE MORK)

L-3
NEW LAVATORY AMERICAN STANDARD "LUCERNE" MODEL 0355.012, WALL MOUNTED, VITREOUS CHINA, 4" CENTERS. PROVIDE AMERICAN STANDARD FAUCET MODEL 6114.116.002, CHROME PLATED BRASS, CERAMIC DISC VALVE CARTRIDGE, LEAD FREE, HOT HIGH LIMIT, VANDAL-RESISTANT AERATOR, ASSE 1070 MIXING VALVE, OFFSET GRID STRAINER, CHROME PLATED P-TRAP, STOPS, ETC. REMORK SUPPORTS FOR NEW LAVATORY SUPPORTS

NEW SINGLE COMPARTMENT WALL MOUNTED SINK BY ADVANCE TABCO (OR EQUAL) MODEL FE-1-1812-18R. 18×18×12 BOWL, 18" DRAIN BOARD, 18 GAUGE 304 STAINLESS STEEL WITH BACK SPLASH, ROLLED EDGE, LEGS, ETC. PROVIDE WITH WRIST BLADE CHROME PLATED BRASS FAUCET, FOR MOUNTING AT 8" CNETERS ON BACK SPLASH AND JAY R SMITH PLASTER TRAP MODEL 871-TO150 (MOUNTED WITH ACCESS ABOVE TRAP).

SEE PLUMBING SPECIFICATIONS FOR ADDITIONAL REQUIREMENTS AND LISTED EQUIVALENT MANUFACTURES. PROVIDE NEW TRAPS, STOPS, RISERS, TAIL PIECES, ETC. FOR NEW AND EXISTING FIXTURES FOR COMPLETE

KEYED PLUMBING DEMOLITION NOTES

- REMOVE EXISTING WATER CLOSET & FLUSH VALVE FOR NEW TILE WORK, FIXTURE TO BE REINSTALLED AT CURRENT LOCATION.
- REMOVE URINAL & FLUSH VALVE
- REMOVE EXISTING LAVATORY, FAUCET, TRAP, ETC. FIXTURE TO BE REINSTALLED AT CURRENT LOCATION.
- REMOVE EXISTING WATER CLOSET & FLUSH VALVE. FIXTURE TO BE REINSTALLED AT NEW LOCATION, SEAL SANITARY & COLD WATER IN WALL. REMOVE ANY SUPPORTS, BOLTS, ETC. THAT PENETRATE OUT WALL & INTERFERE WITH NEW TILE WORK.
- REMOVE SECTION OF COLD WATER PIPING IN CHASE CAP & PROVIDE NEW AIR CHAMBER. REMOVE BLOCK FOR WORK REQUIRED, COORDINATE WITH GENERAL
- REMOVE LAVATORY HW, CW, VENT, SANITARY, STOPS, ETC. LAVATORY TO BE REINSTALLED AT A NEW
- REMOVE EXISTING URINAL, FLUSH VALVE BACK TO NEW CONNECTION POINT FOR NEW URINAL
- REMOVE EXISTING FLOOR MOUNTED WATER CLOSET \$ FLUSH VALVE FOR NEW WATER CLOSET REMOVE EXISTING LAVATORY, FAUCET, RISER, TRAP. ETC. FOR NEW LAVATORY
- REMOVE DRINKING FOUNTAIN & PIPING BACK TO NEW CONNECTION POINT AT NEW SINK

* KEYED PLUMBING NOTES

- REINSTALL EXISTING WATER CLOSET AT EXISTING WATER CLOSET LOCATION (REMOVE & REINSTALL FOR NEW TILE WORK) EXTEND BOLTS & SANITARY COUPLING. PROVIDE NEW GASKET, EXTEND WATER CONNECTION REINSTALL EXISTING FLUSH VALVE AND STOP AT WALL.
- INSTALL EXISTING WATER CLOSET AT ABANDONED WC LOCATION REMOVE CAP AND EXTEND BOLTS & SANITARY COUPLING AND PROVIDE NEW GASKET, EXTEND WATER CONNECTION REINSTALL EXISTING FLUSH VALVE AND STOP AT WALL.
- INSTALL NEW URINAL AT NEW LOCATION. PROVIDE NEW CARRIER, SUPPORTS, CM, WASTE & VENT CONNECTIONS. COORDINATE WITH NEW WALL.
- INSTALL EXISTING LAVATORY AT EXISTING LAVATORY LOCATION, REMOVE & REINSTALL FOR NEW TILE WORK. EXTEND SUPPORTS, HW, CW, WASTE & VENT CONNECTIONS,
- (5) INSTALL EXISTING LAVATORY AT NEW LAVATORY LOCATION. CONNECT TO NEW HECM, WEY, PROVIDE NEW

PROVIDE NEW STOPS, RISERS, TRAP & PIPING.

- CARRIER, SUPPORTS, STOPS, RISERS, TRAP & PIPING. INSTALL NEW URINAL AT EXISTING LOCATION. PROVIDE NEW SUPPORT AND SANITARY CONNECTION RECONNECT
- OPEN EXISTING WALL FOR NEW PIPING WORK COORDINATE WITH GENERAL TRADES FOR INFILL BELOW NEW TILE WORK

NEW FLOOR TILE HEIGHT

ADJUST/REPLACE STRAINER AT FLOOR DRAIN TO MATCH

EXISTING FLUSH VALVE TO EXISTING CW AT WALL. CHECKED REVIEWED

Plot date: 10/22/2024 10:14 AM

DRAWING NO. MLB OCT 18, 2024

L MING_ E' MING 'A' MING _____ NORTH KEYPLAN KEYPLAN



GENERAL

PLUMBING NOTES

OWNER HAS FIRST RIGHT OF REFUSAL, OTHERWISE

CONTRACTOR SHALL FIELD VERIFY EXISTING COLD

MATER, HOT MATER AND SANITARY CONNECTIONS

. FIELD VERIFY ALL EXISTING PIPING AND ADJUST PIPING

ALL WORK SHALL BE SCHEDULE WITH SCHOOL ANY

INTERRUPTIONS OF HEATING, GAS, WATER SERVICE POWER, ETC. SHALL BE COORDINATED TWO WEEK

COORDINATE ALL WORK WITH ARCHITECTURAL AND

EQUIPMENT, ETC REQUIRED OF THESE TRADES.

NOTATIONS ARE MADE IN VARIOUS PLACES ON THE

REQUIRED, HOMEVER, THESE DRAWINGS ARE NOT

INTENDED TO SHOW EACH AND EVERY ITEM TO BE

SUBCONTRACTORS FOR THE VARIOUS TRADES SHALL

RESPECTIVE TRADES AS REQUIRED TO PERMIT THE

CONTRACTOR FIELD VERIFY EXISTING PLUMBING AND

REMORK CONNECTIONS FOR NEW TILE WALLS. EXTEND

PIPING AND WALL SUPPORTS FOR NEW CONNECTIONS

1. CAP COLD WATER AND HOT WATER PIPING AT MAINS

DRAWINGS TO CALL ATTENTION TO DEMOLITION WHICH IS

AT AREAS OF DEMOLITION, CONTRACTOR IS

RESPONSIBLE FOR REMOVING, CAPPING,

DISCONNECTING ALL INCIDENTAL ITEMS.

REMOVED. THE CONTRACTOR AND THE

ETC, FOR NEW PLUMBING WORK.

LEAVING NO DEAD LEGS IN PIPING.

REMOVE THE MATERIALS RELATED TO THEIR

CONSTRUCTION OF THE NEW WORK AS SHOWN

ELECTRICAL DRAWINGS AND TRADES, VERIFY EXACT SIZES AND LOCATIONS OF ALL WALLS, OPENINGS,

PRIOR TO ORDERING PLUMBING FIXTURES.

AS REQUIRED FOR NEW WORK.

PRIOR TO REQUIRED WORK.

SEE ALL PLANS FOR REQUIRED WORK

DISPOSE FROM SITE.

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PROJECT 'A' RENOVATIONS TO:


BULLOCK CREEK HIGH SCHOOL

1420 SOUTH BADOUR ROAD MIDLAND, MI

DRAWING TITLE

'A' WING ENLARGED TOILET ROOM PLUMBING PLANS

PROJECT NO. CJV/KLS 24-120 CAD FILE NO. A-P101 AS NOTED

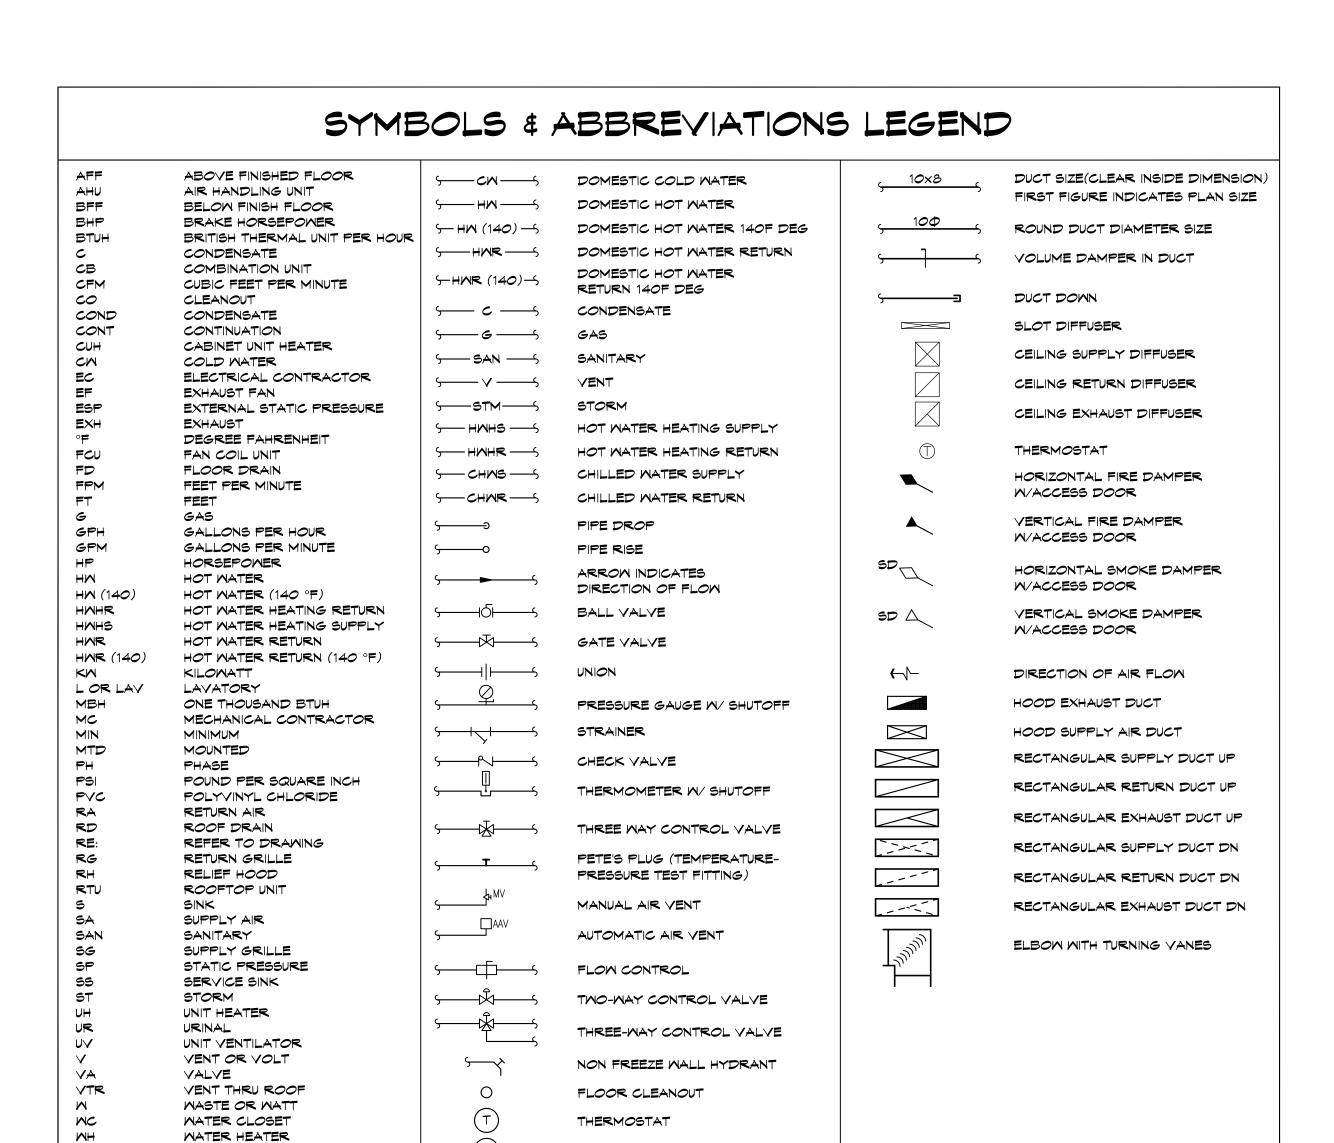

CARBON DIOXIDE SENSOR

OMNER HAS FIRST RIGHT OF REFUSAL, OTHERWISE

CONTRACTOR SHALL FIELD VERIFY EXISTING COLD MATER, HOT MATER AND SANITARY CONNECTIONS

4. FIELD VERIFY ALL EXISTING PIPING AND ADJUST PIPING

ALL WORK SHALL BE SCHEDULE WITH SCHOOL ANY

INTERRUPTIONS OF HEATING, GAS, WATER SERVICE,

POWER, ETC. SHALL BE COORDINATED TWO WEEK

COORDINATE ALL WORK WITH ARCHITECTURAL AND

NOTATIONS ARE MADE IN VARIOUS PLACES ON THE

REQUIRED, HOMEVER, THESE DRAWINGS ARE NOT

INTENDED TO SHOW EACH AND EVERY ITEM TO BE

SUBCONTRACTORS FOR THE VARIOUS TRADES SHALL

RESPECTIVE TRADES AS REQUIRED TO PERMIT THE

CONTRACTOR FIELD VERIFY EXISTING PLUMBING AND

REMORK CONNECTIONS FOR NEW TILE WALLS. EXTEND

PIPING AND WALL SUPPORTS FOR NEW CONNECTIONS

10. CONTRACTOR TO PROVIDE NEW STOPS, TRAP, RISERS,

11. CAP COLD WATER AND HOT WATER PIPING AT MAINS

DRAWINGS TO CALL ATTENTION TO DEMOLITION WHICH IS

AT AREAS OF DEMOLITION, CONTRACTOR IS

RESPONSIBLE FOR REMOVING, CAPPING, DISCONNECTING ALL INCIDENTAL ITEMS.

REMOVED. THE CONTRACTOR AND THE

ETC, FOR NEW PLUMBING WORK.

LEAVING NO DEAD LEGS IN PIPING.

REMOVE THE MATERIALS RELATED TO THEIR

CONSTRUCTION OF THE NEW WORK AS SHOWN


ELECTRICAL DRAWINGS AND TRADES, VERIFY EXACT SIZES AND LOCATIONS OF ALL WALLS, OPENINGS, EQUIPMENT, ETC REQUIRED OF THESE TRADES.


PRIOR TO ORDERING PLUMBING FIXTURES.

AS REQUIRED FOR NEW WORK.

PRIOR TO REQUIRED WORK.

DISPOSE FROM SITE.

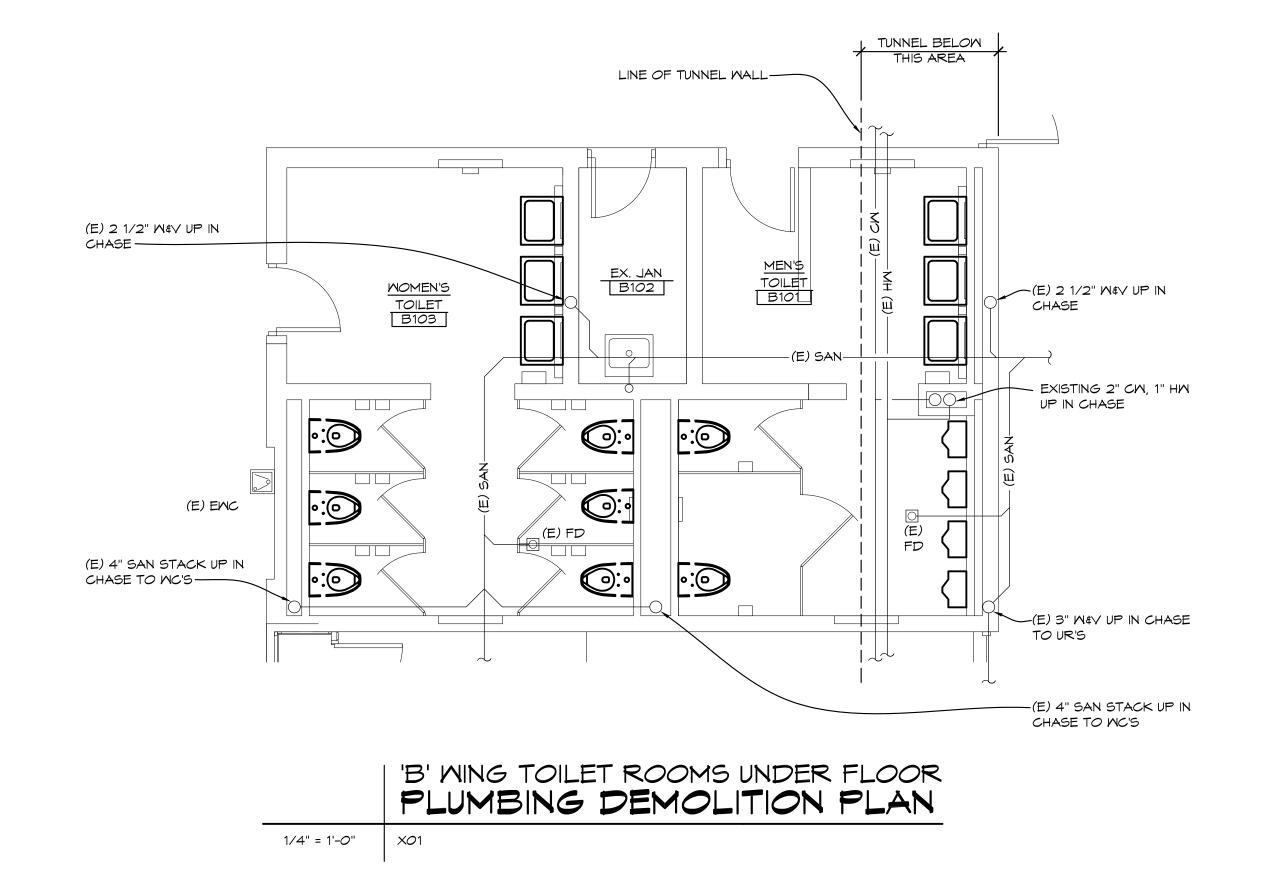

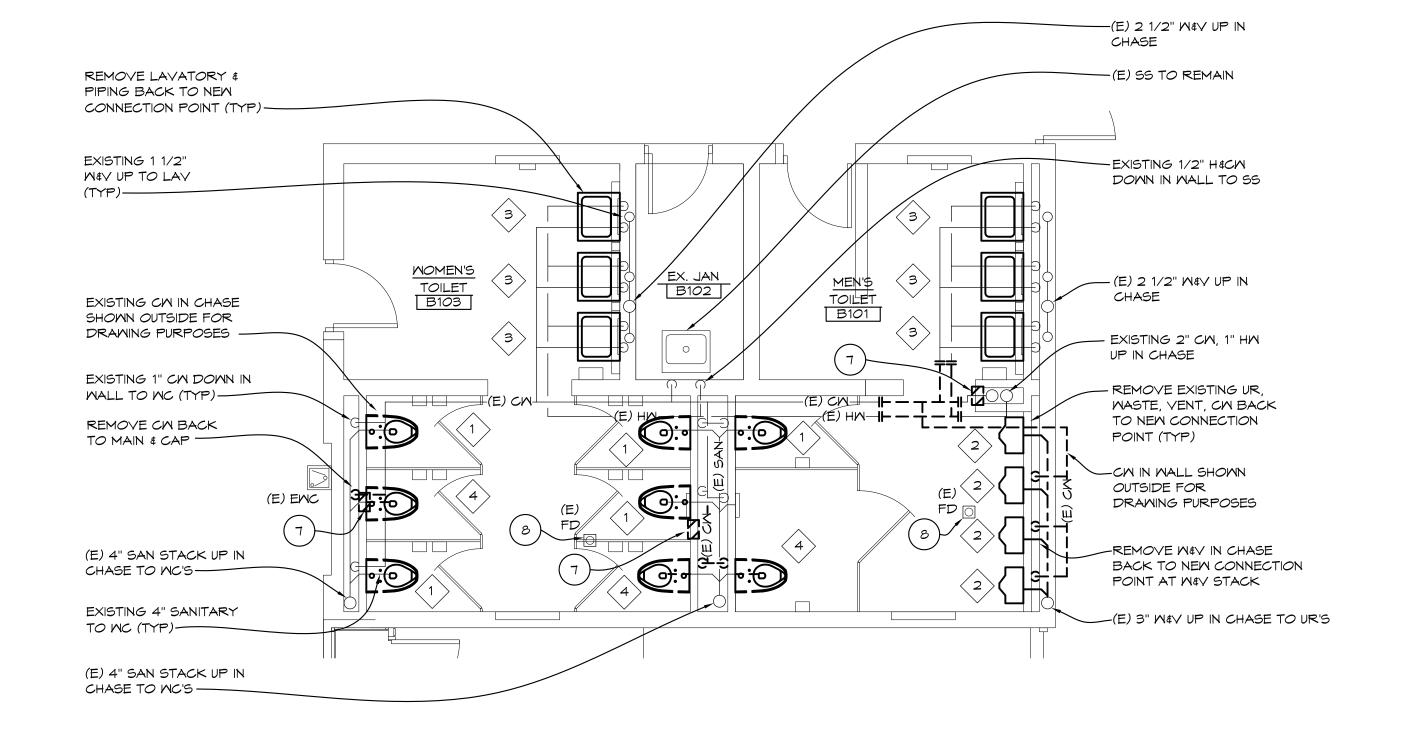

'B' WING TOILET ROOMS ABOVE FLOOR

PLUMBING DEMOLITION PLAN

1/4" = 1'-0" ×01

EXISTING 1/2" H&CM -(E) 2 1/2" M&V UP IN DOWN IN WALL TO LAV (TYP)----EXISTING H&CM DOWN IN EXISTING 1 1/2" MALL TO SS M&V UP TO LAV —(E) 2 1/2" M&V UP IN CHASE -CONNECT NEM 3/4" H&CM TO EXISTING FOR LAV'S —(E) 2" CM & 1" HM EXISTING 1" CM DOMN IN UP FROM TUNNEL MALL TO MC (TYP) — -3/4" CM DOWN IN MALL TO NEW URINAL LOCATION (TYP) EXISTING 4" SANITARY TO MC (TYP) (E) ENC -2" W \$ 1 1/2" ∨ TO UR FOR NEW URINAL LOCATION (TYP) (E) 4" SAN STACK UP IN -(E) 3" W&V UP IN CHASE TO UR'S CHASE TO MC'S — -CONNECT NEW 3" W & 2" VENT TO EXISTING W&V (E) 4" SAN STACK UP IN CHASE TO MC'S —

> 'B' WING TOILET ROOMS ABOVE FLOOR ENLARGED PLUMBING PLAN 1/4" = 1'-0" ×O1

KEYED PLUMBING DEMOLITION NOTES

- REMOVE EXISTING WATER CLOSET & FLUSH VALVE FOR NEW TILE WORK, FIXTURE TO BE REINSTALLED AT CURRENT LOCATION.
- REMOVE URINAL & FLUSH VALVE
- REMOVE EXISTING LAVATORY, FAUCET, TRAP, ETC. FIXTURE TO BE REINSTALLED AT CURRENT LOCATION.
- REMOVE EXISTING WATER CLOSET & FLUSH VALVE. FIXTURE TO BE REINSTALLED AT NEW LOCATION, SEAL SANITARY & COLD WATER IN WALL. REMOVE ANY SUPPORTS, BOLTS, ETC. THAT PENETRATE OUT WALL & INTERFERE WITH NEW TILE WORK.
- REMOVE SECTION OF COLD WATER PIPING IN CHASE, CAP & PROVIDE NEW AIR CHAMBER. REMOVE BLOCK FOR WORK REQUIRED, COORDINATE WITH GENERAL
- REMOVE LAVATORY HM, CM, VENT, SANITARY, STOPS. ETC. LAVATORY TO BE REINSTALLED AT A NEW
- REMOVE EXISTING URINAL, FLUSH VALVE BACK TO NEW CONNECTION POINT FOR NEW URINAL
- REMOVE EXISTING FLOOR MOUNTED WATER CLOSET \$ FLUSH VALVE FOR NEW WATER CLOSET
- REMOVE EXISTING LAVATORY, FAUCET, RISER, TRAP. ETC. FOR NEW LAVATORY REMOVE DRINKING FOUNTAIN & PIPING BACK TO NEW


CONNECTION POINT AT NEW SINK


* KEYED PLUMBING NOTES

- REINSTALL EXISTING WATER CLOSET AT EXISTING WATER CLOSET LOCATION (REMOVE & REINSTALL FOR NEW TILE MORK) EXTEND BOLTS & SANITARY COUPLING. PROVIDE NEW GASKET, EXTEND WATER CONNECTION REINSTALL EXISTING FLUSH VALVE AND STOP AT WALL.
- INSTALL EXISTING WATER CLOSET AT ABANDONED MC LOCATION REMOVE CAP AND EXTEND BOLTS & SANITARY COUPLING AND PROVIDE NEW GASKET, EXTEND WATER CONNECTION REINSTALL EXISTING FLUSH VALVE AND STOP AT WALL.
- INSTALL NEW URINAL AT NEW LOCATION. PROVIDE NEW CARRIER, SUPPORTS, CM, WASTE & VENT CONNECTIONS. COORDINATE WITH NEW WALL.
- INSTALL EXISTING LAVATORY AT EXISTING LAVATORY LOCATION, REMOVE & REINSTALL FOR NEW TILE WORK. EXTEND SUPPORTS, HW, CM, WASTE & VENT CONNECTIONS, PROVIDE NEW STOPS, RISERS, TRAP & PIPING.
- 5 INSTALL EXISTING LAVATORY AT NEW LAVATORY LOCATION. CONNECT TO NEW HECM, MEY, PROVIDE NEW
- CARRIER, SUPPORTS, STOPS, RISERS, TRAP & PIPING. 6 INSTALL NEW URINAL AT EXISTING LOCATION. PROVIDE NEW SUPPORT AND SANITARY CONNECTION RECONNECT
- (7) OPEN EXISTING WALL FOR NEW PIPING WORK COORDINATE WITH GENERAL TRADES FOR INFILL BELOW NEW TILE WORK
- ADJUST/REPLACE STRAINER AT FLOOR DRAIN TO MATCH NEW FLOOR TILE HEIGHT

EXISTING FLUSH VALVE TO EXISTING CM AT WALL.

A' MING NORTH KEYPLAN

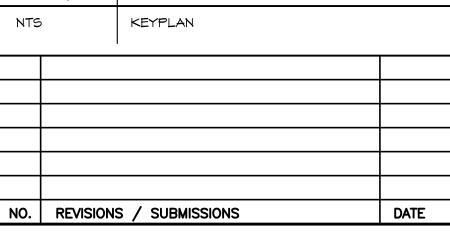

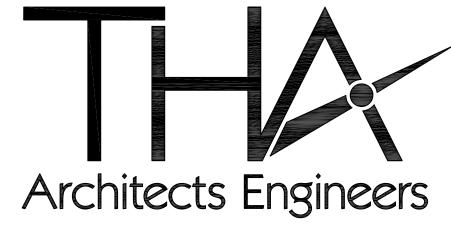

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PROJECT 'A' RENOVATIONS TO:

BULLOCK CREEK HIGH SCHOOL

1420 SOUTH BADOUR ROAD MIDLAND, MI

DRAWING TITLE

Plot date: 10/22/2024 10:15 AM

'B' WING ENLARGED TOILET ROOM PLUMBING PLANS

EAL	DRAWN	PROJECT NO.
	CJV/KLS	24-120
	CHECKED	CAD FILE NO.
	KLS	A-P102
	REVIEWED	DRAWING NO.
	MLB	A 2100
	DATE	
	OCT 18, 2024	CHEET NO
	COALE	SHEET NO.

AS NOTED

OWNER HAS FIRST RIGHT OF REFUSAL, OTHERWISE

CONTRACTOR SHALL FIELD VERIFY EXISTING COLD WATER, HOT WATER AND SANITARY CONNECTIONS

FIELD VERIFY ALL EXISTING PIPING AND ADJUST PIPING

ALL WORK SHALL BE SCHEDULE WITH SCHOOL ANY INTERRUPTIONS OF HEATING, GAS, WATER SERVICE, POWER, ETC. SHALL BE COORDINATED TWO WEEK

COORDINATE ALL WORK WITH ARCHITECTURAL AND

SIZES AND LOCATIONS OF ALL WALLS, OPENINGS,

NOTATIONS ARE MADE IN VARIOUS PLACES ON THE

REQUIRED, HOMEVER, THESE DRAWINGS ARE NOT INTENDED TO SHOW EACH AND EVERY ITEM TO BE

SUBCONTRACTORS FOR THE VARIOUS TRADES SHALL

CONTRACTOR FIELD VERIFY EXISTING PLUMBING AND

REMORK CONNECTIONS FOR NEW TILE WALLS. EXTEND

PIPING AND WALL SUPPORTS FOR NEW CONNECTIONS

10. CONTRACTOR TO PROVIDE NEW STOPS, TRAP, RISERS,

1. CAP COLD WATER AND HOT WATER PIPING AT MAINS

RESPECTIVE TRADES AS REQUIRED TO PERMIT THE

DRAWINGS TO CALL ATTENTION TO DEMOLITION WHICH IS

EQUIPMENT, ETC REQUIRED OF THESE TRADES.

AT AREAS OF DEMOLITION, CONTRACTOR IS

RESPONSIBLE FOR REMOVING, CAPPING,

DISCONNECTING ALL INCIDENTAL ITEMS.

REMOVED. THE CONTRACTOR AND THE

ETC, FOR NEW PLUMBING WORK.

LEAVING NO DEAD LEGS IN PIPING.

REMOVE THE MATERIALS RELATED TO THEIR

CONSTRUCTION OF THE NEW WORK AS SHOWN


ELECTRICAL DRAWINGS AND TRADES, VERIFY EXACT

PRIOR TO ORDERING PLUMBING FIXTURES.

AS REQUIRED FOR NEW WORK.

PRIOR TO REQUIRED WORK.

DISPOSE FROM SITE.

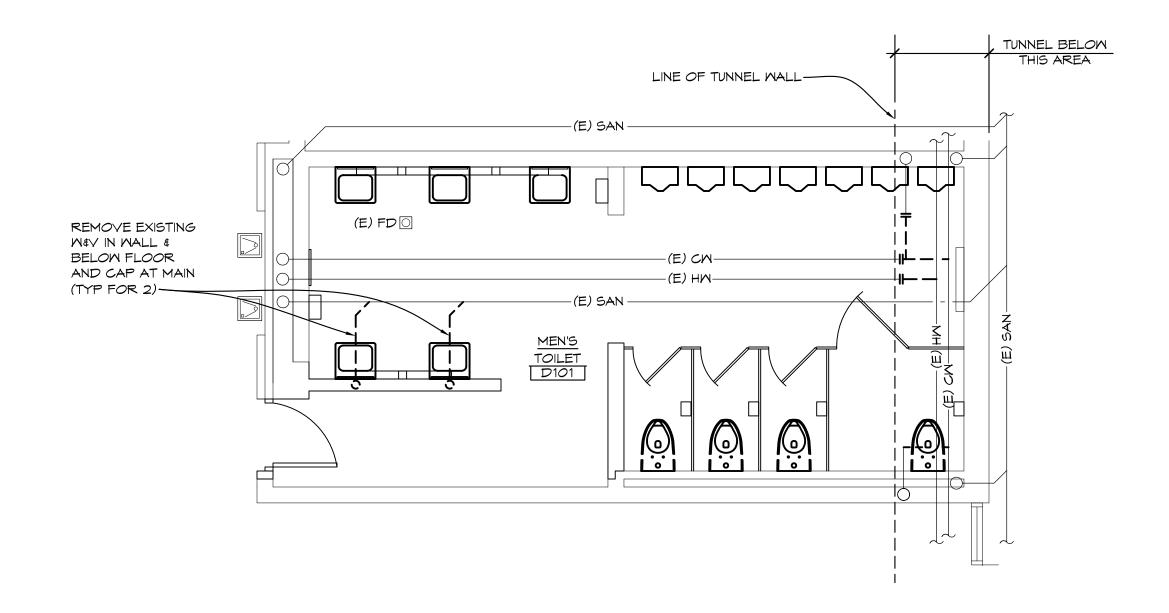

'D' WING TOILET ROOM UNDER FLOOR

PLUMBING DEMOLITION PLAN

—(E) CM IN MALL SHOWN OUTSIDE FOR DRAWING (E) SAN IN MALL PURPOSES SHOWN OUTSIDE FOR DRAWING PURPOSES — —(E) CM UP IN MALL TO UR'S EXISTING 1/2" H&CM DOMN IN WALL TO LAV (TYP)-—(E) SANITARY STACK -REMOVE EXISTING UR & (E) SANITARY STACK— CM BACK TO NEW CONNECTION POINT (TYP) -REMOVE EXISTING 2" W, 1 1/2" V BACK TO NEW CONNECTION POINT (TYP) REMOVE LAVATORY & PIPING BACK TO NEW CONNECTION POINT--REMOVE EXISTING MC & CM BACK TO NEW (E) SANITARY STACK-CONNECTION POINT (TYP) -REMOVE EXISTING 4" W (E) SAN IN MALL BACK MAIN SHOWN OUTSIDE FOR DRAWING PURPOSES —(E) 4" SAN STACK UP IN CHASE TO MC'S -(E) CM IN MALL SHOMN OUTSIDE FOR DRAWING PURPOSES

'D' WING TOILET ROOM ABOVE FLOOR
PLUMBING DEMOLITION PLAN

KEYED PLUMBING DEMOLITION NOTES

- REMOVE EXISTING WATER CLOSET & FLUSH VALVE FOR NEW TILE WORK, FIXTURE TO BE REINSTALLED AT CURRENT LOCATION.
- 2 REMOVE URINAL & FLUSH VALVE
- REMOVE EXISTING LAVATORY, FAUCET, TRAP, ETC. FIXTURE TO BE REINSTALLED AT CURRENT LOCATION.
- REMOVE EXISTING WATER CLOSET & FLUSH VALVE.
 FIXTURE TO BE REINSTALLED AT NEW LOCATION, SEAL
 SANITARY & COLD WATER IN WALL. REMOVE ANY
 SUPPORTS, BOLTS, ETC. THAT PENETRATE OUT WALL &
 INTERFERE WITH NEW TILE WORK.
- REMOVE SECTION OF COLD WATER PIPING IN CHASE, CAP & PROVIDE NEW AIR CHAMBER. REMOVE BLOCK FOR WORK REQUIRED, COORDINATE WITH GENERAL TRADES.
- REMOVE LAVATORY HW, CW, VENT, SANITARY, STOPS, ETC. LAVATORY TO BE REINSTALLED AT A NEW LOCATION
- REMOVE EXISTING URINAL, FLUSH VALVE BACK TO NEW CONNECTION POINT FOR NEW URINAL
- REMOVE EXISTING FLOOR MOUNTED WATER CLOSET & FLUSH VALVE FOR NEW WATER CLOSET
- REMOVE EXISTING LAVATORY, FAUCET, RISER, TRAP, ETC. FOR NEW LAVATORY

 REMOVE DRINKING FOUNTAIN & PIPING BACK TO NEW

* KEYED PLUMBING NOTES

CONNECTION POINT AT NEW SINK

- REINSTALL EXISTING WATER CLOSET AT EXISTING WATER CLOSET LOCATION (REMOVE & REINSTALL FOR NEW TILE WORK) EXTEND BOLTS & SANITARY COUPLING. PROVIDE NEW GASKET, EXTEND WATER CONNECTION REINSTALL EXISTING FLUSH VALVE AND STOP AT WALL.
- 2 INSTALL EXISTING WATER CLOSET AT ABANDONED MC LOCATION REMOVE CAP AND EXTEND BOLTS & SANITARY COUPLING AND PROVIDE NEW GASKET, EXTEND WATER CONNECTION REINSTALL EXISTING FLUSH VALVE AND STOP AT WALL.
- 3 INSTALL NEW URINAL AT NEW LOCATION. PROVIDE NEW CARRIER, SUPPORTS, CM, WASTE & VENT CONNECTIONS. COORDINATE WITH NEW WALL.
- INSTALL EXISTING LAVATORY AT EXISTING LAVATORY
 LOCATION, REMOVE & REINSTALL FOR NEW TILE WORK.
 EXTEND SUPPORTS, HW, CW, WASTE & VENT CONNECTIONS,
 PROVIDE NEW STOPS, RISERS, TRAP & PIPING.
- 5 INSTALL EXISTING LAVATORY AT NEW LAVATORY
 LOCATION. CONNECT TO NEW HECM, WEV, PROVIDE NEW
- LOCATION. CONNECT TO NEW H&CM, W&V, PROVIDE NEW CARRIER, SUPPORTS, STOPS, RISERS, TRAP & PIPING.

 6 INSTALL NEW URINAL AT EXISTING LOCATION. PROVIDE NEW SUPPORT AND SANITARY CONNECTION RECONNECT
- OPEN EXISTING WALL FOR NEW PIPING WORK COORDINATE WITH GENERAL TRADES FOR INFILL BELOW NEW TILE WORK
- 8 ADJUST/REPLACE STRAINER AT FLOOR DRAIN TO MATCH NEW FLOOR TILE HEIGHT


EXISTING FLUSH VALVE TO EXISTING CM AT MALL.

NORTH

KEYPLAN

NO. REVISIONS / SUBMISSIONS

DATE

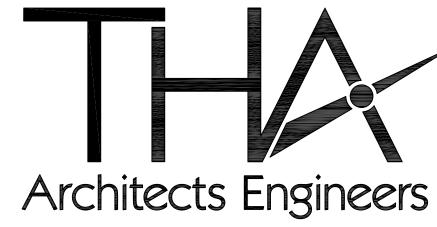

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PROJECT 'A' RENOVATIONS TO:

BULLOCK CREEK HIGH SCHOOL

1420 SOUTH BADOUR ROAD MIDLAND, MI

DRAWING TITLE

Plot date: 10/22/2024 10:16 AM

'D' WING ENLARGED TOILET ROOM PLUMBING PLANS

AS NOTED


DRAWN
CJV/KLS

CHECKED
CHECKED
KLS

REVIEWED
MLB


DATE
OCT 18, 2024

SHEET NO.

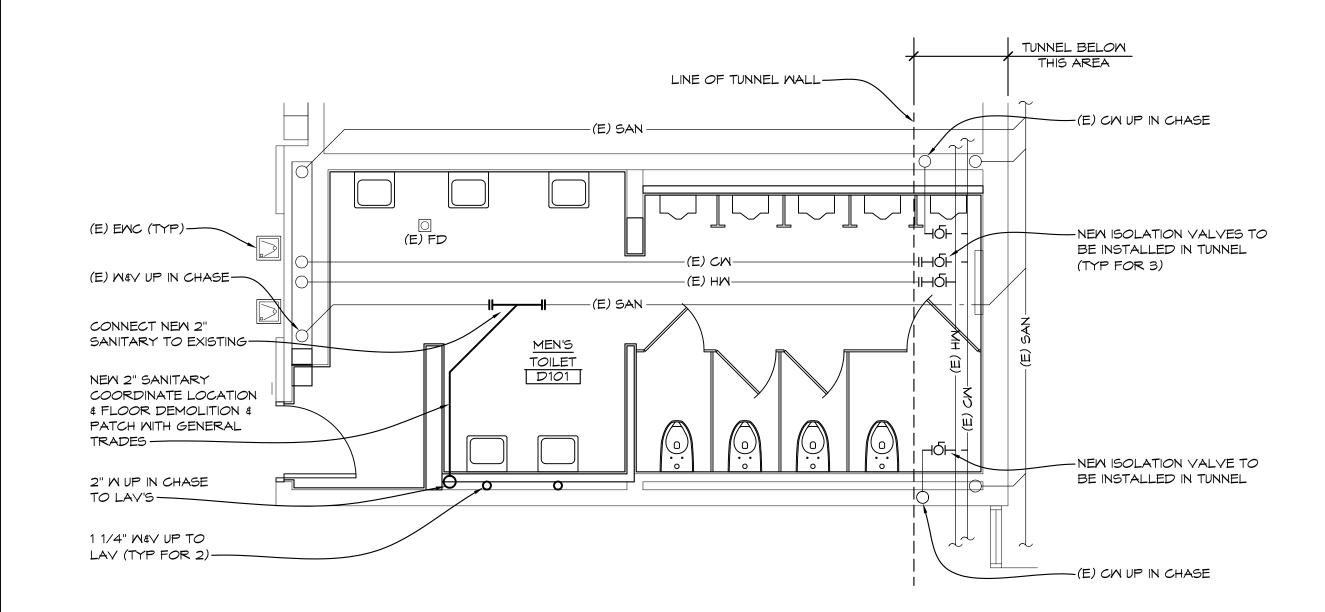


'D' WING TOILET ROOM UNDER FLOOR ENLARGED PLUMBING PLAN

1/4" = 1'-0" X01

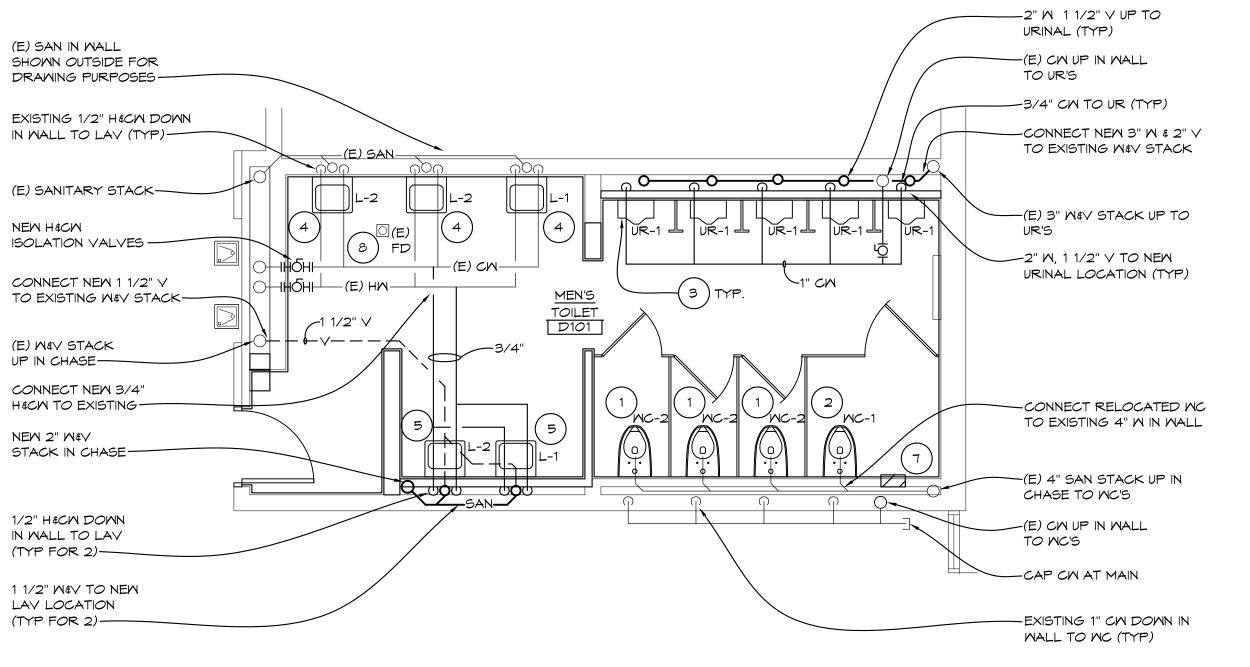


'D' WING TOILET ROOM ABOVE FLOOR ENLARGED PLUMBING PLAN

1/4" = 1'-0" X01

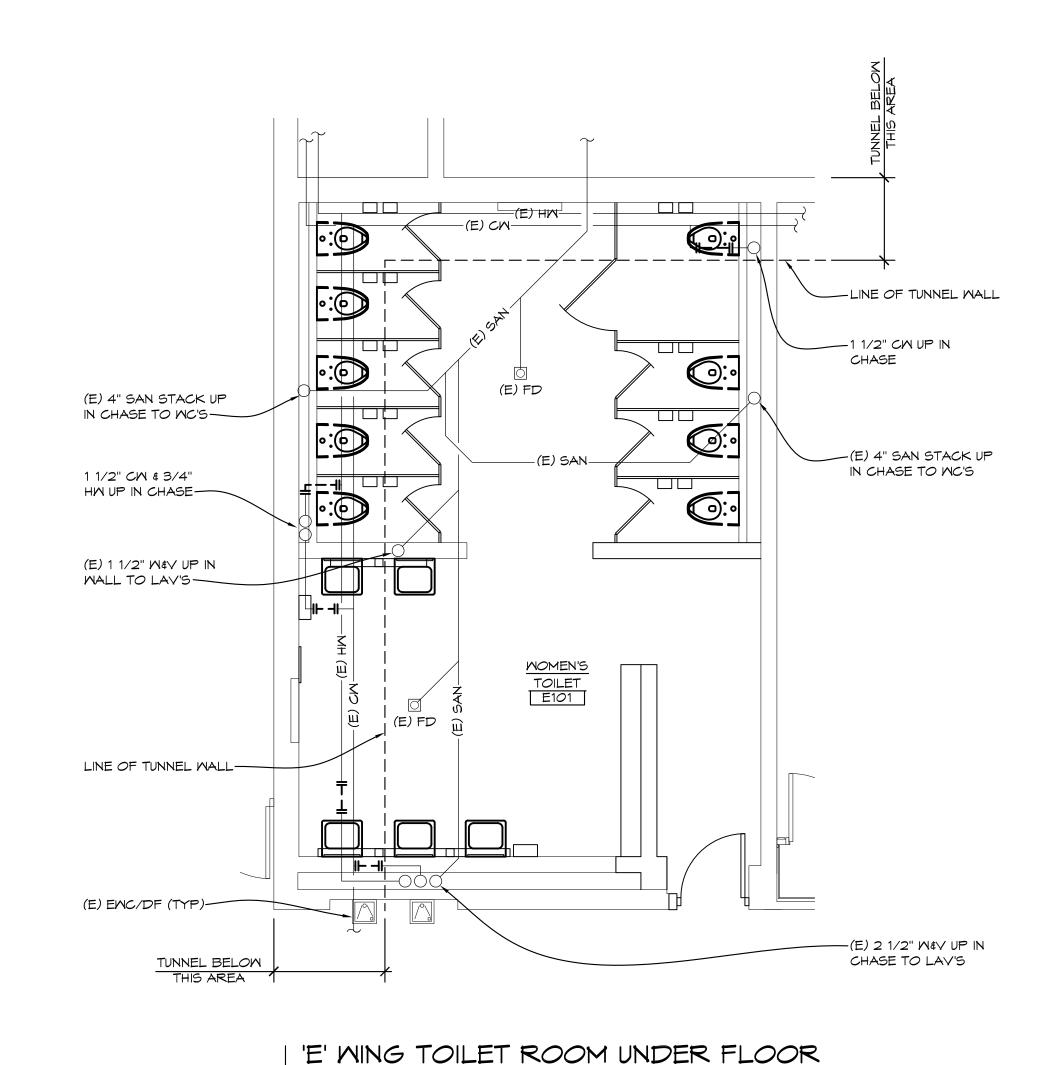


PLUMBING DEMOLITION PLAN

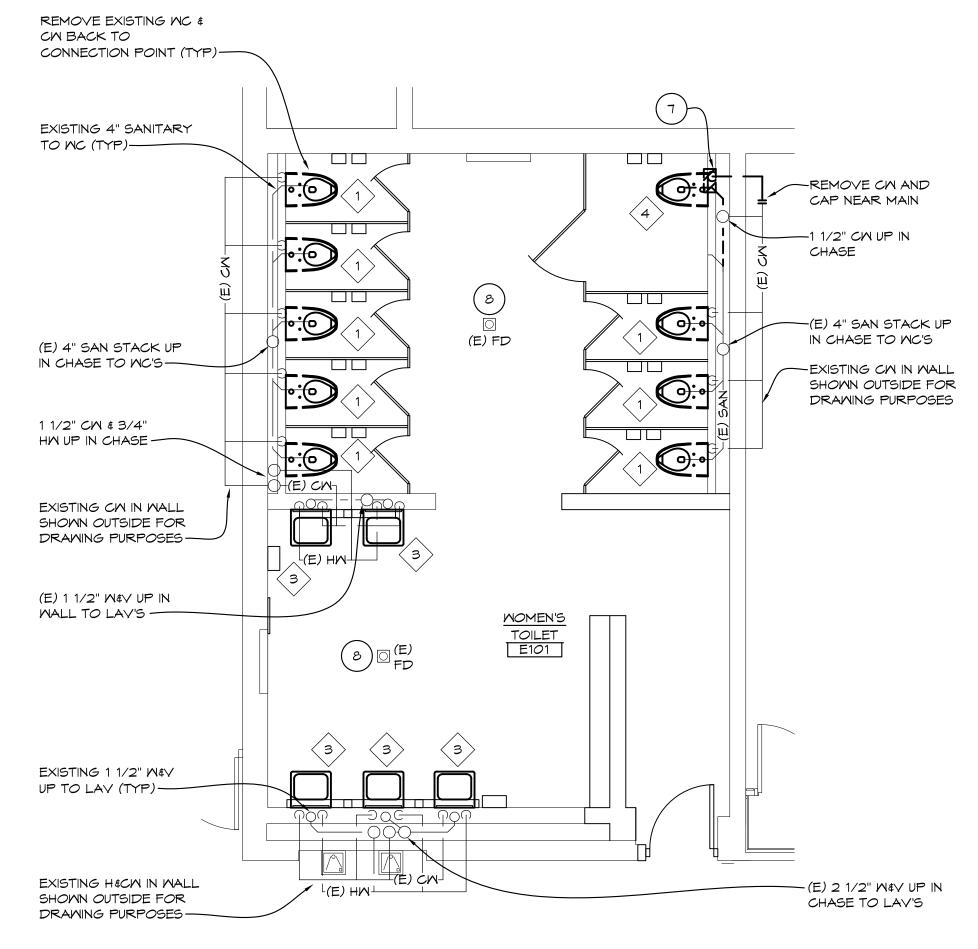

'E' WING TOILET ROOM ABOVE FLOOR

PLUMBING DEMOLITION PLAN

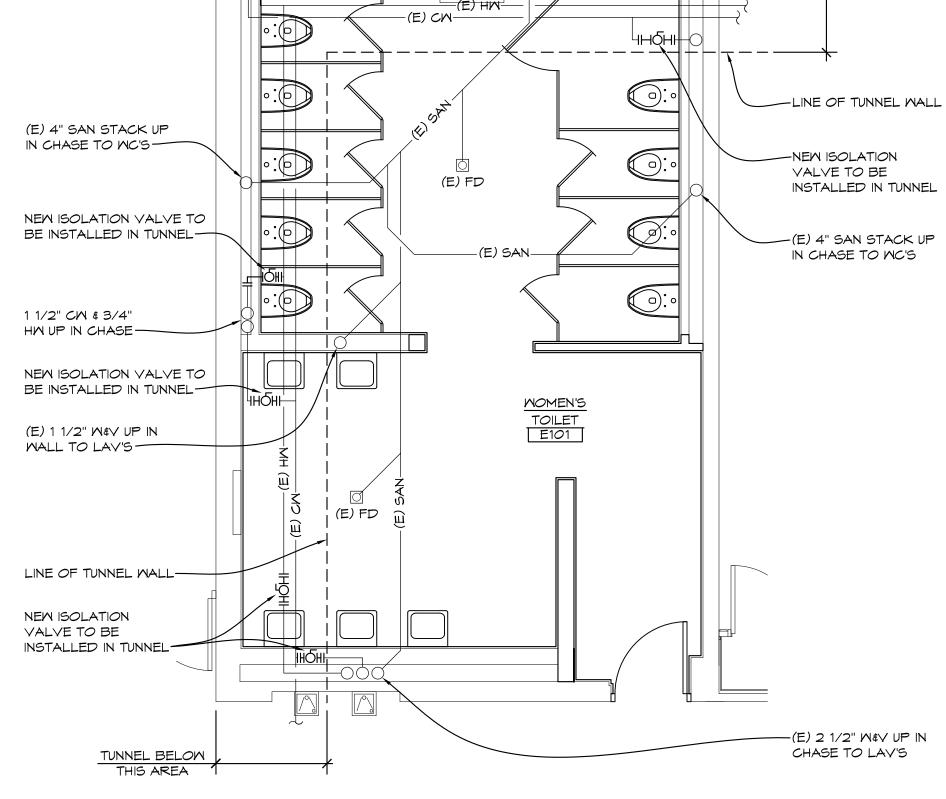

'E' WING TOILET ROOM UNDER FLOOR ENLARGED PLUMBING PLAN 1/4" = 1'-0" XO1

GENERAL PLUMBING NOTES

- SEE ALL PLANS FOR REQUIRED WORK
- OWNER HAS FIRST RIGHT OF REFUSAL, OTHERWISE DISPOSE FROM SITE.
- CONTRACTOR SHALL FIELD VERIFY EXISTING COLD WATER, HOT WATER AND SANITARY CONNECTIONS
- PRIOR TO ORDERING PLUMBING FIXTURES. 4. FIELD VERIFY ALL EXISTING PIPING AND ADJUST PIPING
- AS REQUIRED FOR NEW WORK. ALL WORK SHALL BE SCHEDULE WITH SCHOOL ANY INTERRUPTIONS OF HEATING, GAS, WATER SERVICE,


POWER, ETC. SHALL BE COORDINATED TWO WEEK

- PRIOR TO REQUIRED WORK. COORDINATE ALL MORK WITH ARCHITECTURAL AND ELECTRICAL DRAWINGS AND TRADES, VERIFY EXACT
- SIZES AND LOCATIONS OF ALL WALLS, OPENINGS, EQUIPMENT, ETC REQUIRED OF THESE TRADES. AT AREAS OF DEMOLITION, CONTRACTOR IS
- RESPONSIBLE FOR REMOVING, CAPPING, DISCONNECTING ALL INCIDENTAL ITEMS.
- NOTATIONS ARE MADE IN VARIOUS PLACES ON THE DRAWINGS TO CALL ATTENTION TO DEMOLITION WHICH IS REQUIRED, HOMEYER, THESE DRAWINGS ARE NOT INTENDED TO SHOW EACH AND EVERY ITEM TO BE REMOVED. THE CONTRACTOR AND THE SUBCONTRACTORS FOR THE VARIOUS TRADES SHALL REMOVE THE MATERIALS RELATED TO THEIR RESPECTIVE TRADES AS REQUIRED TO PERMIT THE CONSTRUCTION OF THE NEW WORK AS SHOWN
- CONTRACTOR FIELD VERIFY EXISTING PLUMBING AND REMORK CONNECTIONS FOR NEW TILE WALLS. EXTEND PIPING AND WALL SUPPORTS FOR NEW CONNECTIONS
- 10. CONTRACTOR TO PROVIDE NEW STOPS, TRAP, RISERS, ETC, FOR NEW PLUMBING WORK.
- 1. CAP COLD WATER AND HOT WATER PIPING AT MAINS LEAVING NO DEAD LEGS IN PIPING.

KEYED PLUMBING DEMOLITION NOTES

- REMOVE EXISTING WATER CLOSET & FLUSH VALVE FOR NEW TILE WORK, FIXTURE TO BE REINSTALLED AT CURRENT LOCATION.
- REMOVE URINAL & FLUSH VALVE
- REMOVE EXISTING LAVATORY, FAUCET, TRAP, ETC. FIXTURE TO BE REINSTALLED AT CURRENT LOCATION.
- REMOVE EXISTING WATER CLOSET & FLUSH VALVE. FIXTURE TO BE REINSTALLED AT NEW LOCATION, SEAL SANITARY & COLD WATER IN WALL. REMOVE ANY SUPPORTS, BOLTS, ETC. THAT PENETRATE OUT WALL & INTERFERE WITH NEW TILE WORK.
- REMOVE SECTION OF COLD WATER PIPING IN CHASE CAP & PROVIDE NEW AIR CHAMBER. REMOVE BLOCK FOR WORK REQUIRED, COORDINATE WITH GENERAL
- REMOVE LAVATORY HW, CW, VENT, SANITARY, STOPS, ETC. LAVATORY TO BE REINSTALLED AT A NEW
- REMOVE EXISTING URINAL, FLUSH VALVE BACK TO NEW CONNECTION POINT FOR NEW URINAL
- REMOVE EXISTING FLOOR MOUNTED WATER CLOSET \$ FLUSH VALVE FOR NEW WATER CLOSET
- REMOVE EXISTING LAVATORY, FAUCET, RISER, TRAP, ETC. FOR NEW LAVATORY
- REMOVE DRINKING FOUNTAIN & PIPING BACK TO NEW CONNECTION POINT AT NEW SINK
 - * KEYED PLUMBING NOTES
- REINSTALL EXISTING WATER CLOSET AT EXISTING WATER CLOSET LOCATION (REMOVE & REINSTALL FOR NEW TILE MORK) EXTEND BOLTS & SANITARY COUPLING. PROVIDE NEW GASKET, EXTEND WATER CONNECTION REINSTALL EXISTING FLUSH VALVE AND STOP AT WALL.
- INSTALL EXISTING WATER CLOSET AT ABANDONED WC LOCATION REMOVE CAP AND EXTEND BOLTS & SANITARY COUPLING AND PROVIDE NEW GASKET, EXTEND WATER CONNECTION REINSTALL EXISTING FLUSH VALVE AND STOP AT WALL.
- INSTALL NEW URINAL AT NEW LOCATION. PROVIDE NEW CARRIER, SUPPORTS, CM, WASTE & VENT CONNECTIONS. COORDINATE WITH NEW WALL.
- INSTALL EXISTING LAVATORY AT EXISTING LAVATORY LOCATION, REMOVE & REINSTALL FOR NEW TILE WORK. EXTEND SUPPORTS, HW, CM, WASTE & VENT CONNECTIONS, PROVIDE NEW STOPS, RISERS, TRAP & PIPING.
- 5 INSTALL EXISTING LAVATORY AT NEW LAVATORY LOCATION. CONNECT TO NEW H&CM, M&V, PROVIDE NEW
- CARRIER, SUPPORTS, STOPS, RISERS, TRAP & PIPING. 6 INSTALL NEW URINAL AT EXISTING LOCATION. PROVIDE NEW SUPPORT AND SANITARY CONNECTION RECONNECT
- OPEN EXISTING WALL FOR NEW PIPING WORK COORDINATE WITH GENERAL TRADES FOR INFILL BELOW NEW TILE WORK
- ADJUST/REPLACE STRAINER AT FLOOR DRAIN TO MATCH NEW FLOOR TILE HEIGHT

EXISTING FLUSH VALVE TO EXISTING CM AT MALL.

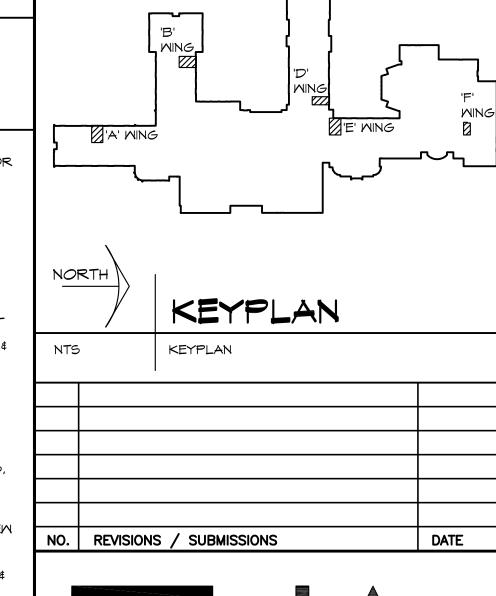



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PROJECT 'A' RENOVATIONS TO:


BULLOCK CREEK HIGH SCHOOL

1420 SOUTH BADOUR ROAD MIDLAND, MI

DRAWING TITLE

'E' WING ENLARGED TOILET ROOM PLUMBING PLANS

DRAWN CJV/KLS	PROJECT NO. 24-120
CHECKED KLS	CAD FILE NO. A-P104
REVIEWED MLB	DRAWING NO.
DATE OCT 18, 2024	SHEET NO.
COME	JILLI NO.

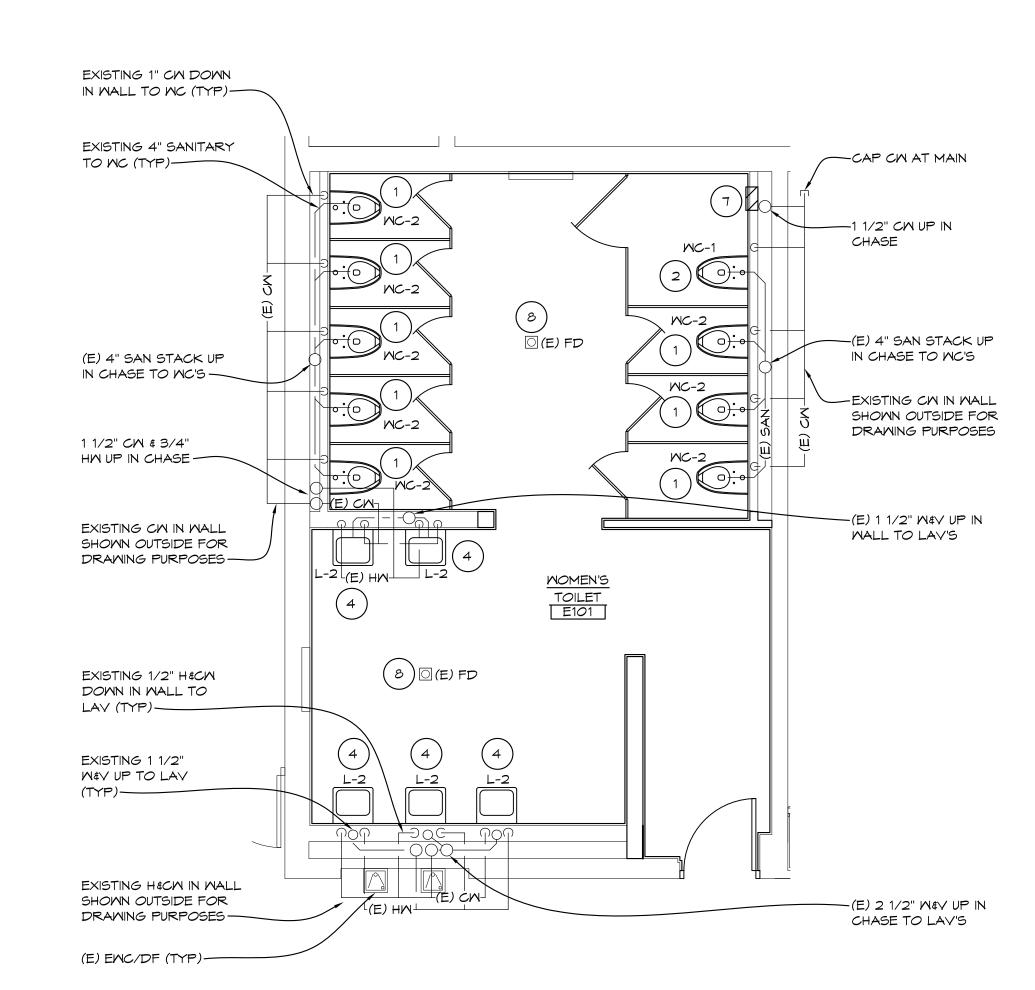

'E' WING TOILET ROOM ABOVE FLOOR ENLARGED PLUMBING PLAN


1/4" = 1'-0" XO1


1/4" = 1'-0" XO1


1/4" = 1'-0" XO1

SCALE AS NOTED Plot date: 10/22/2024 10:17 AM

<u>10</u> of <u>15</u>

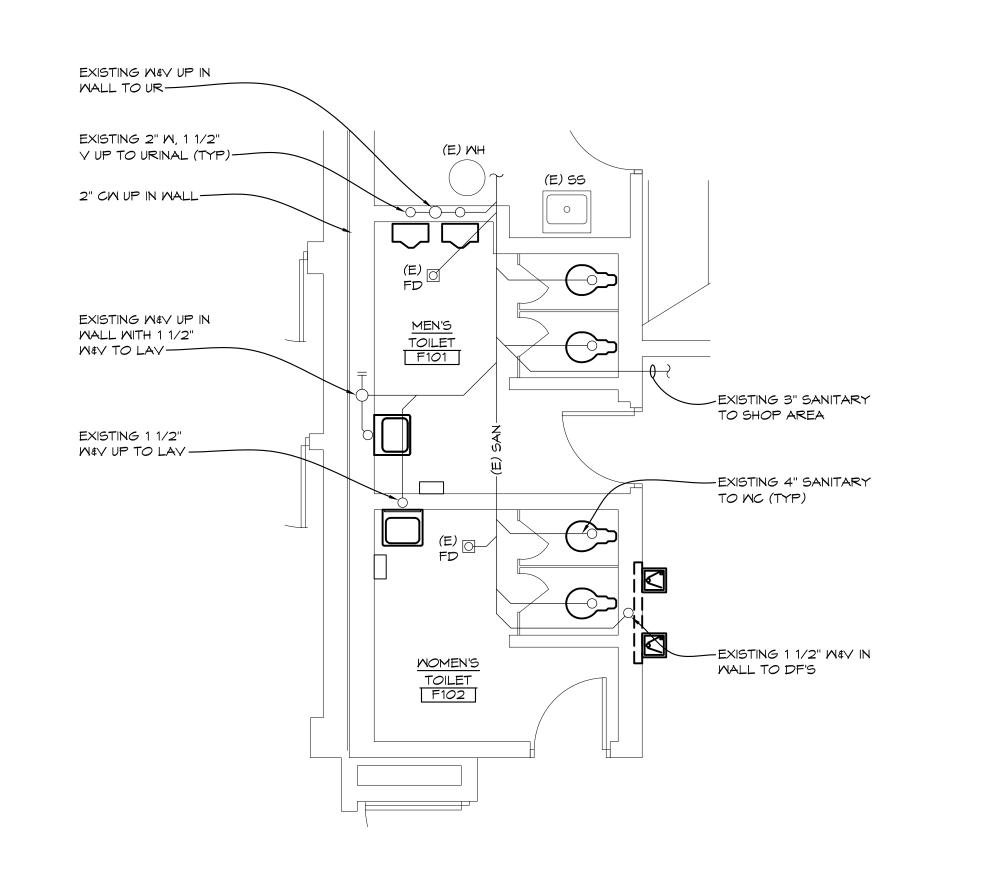

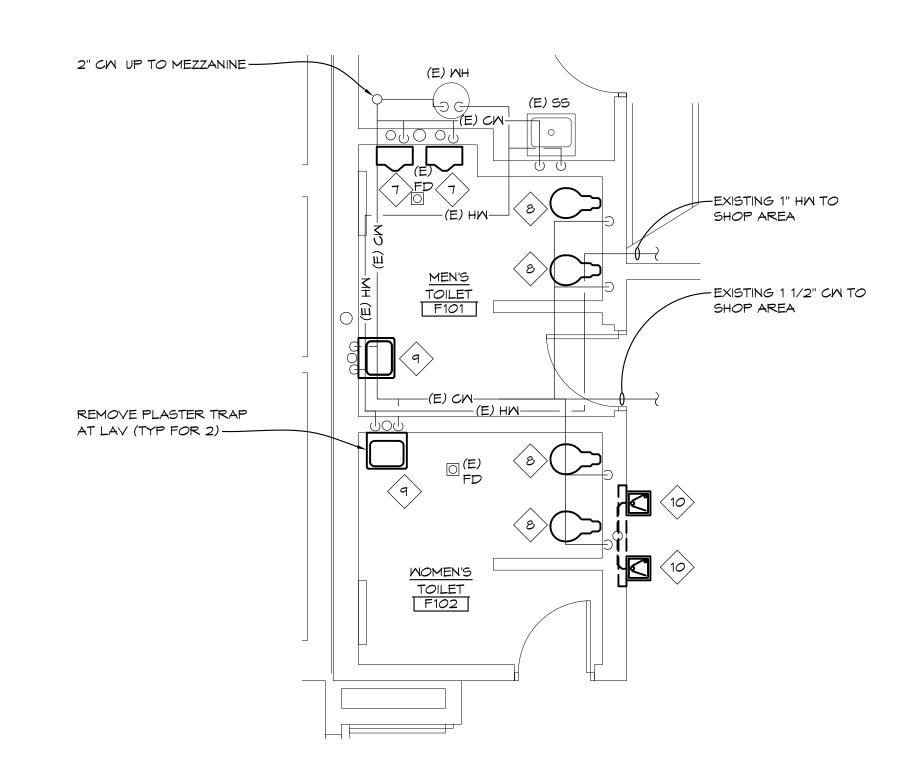

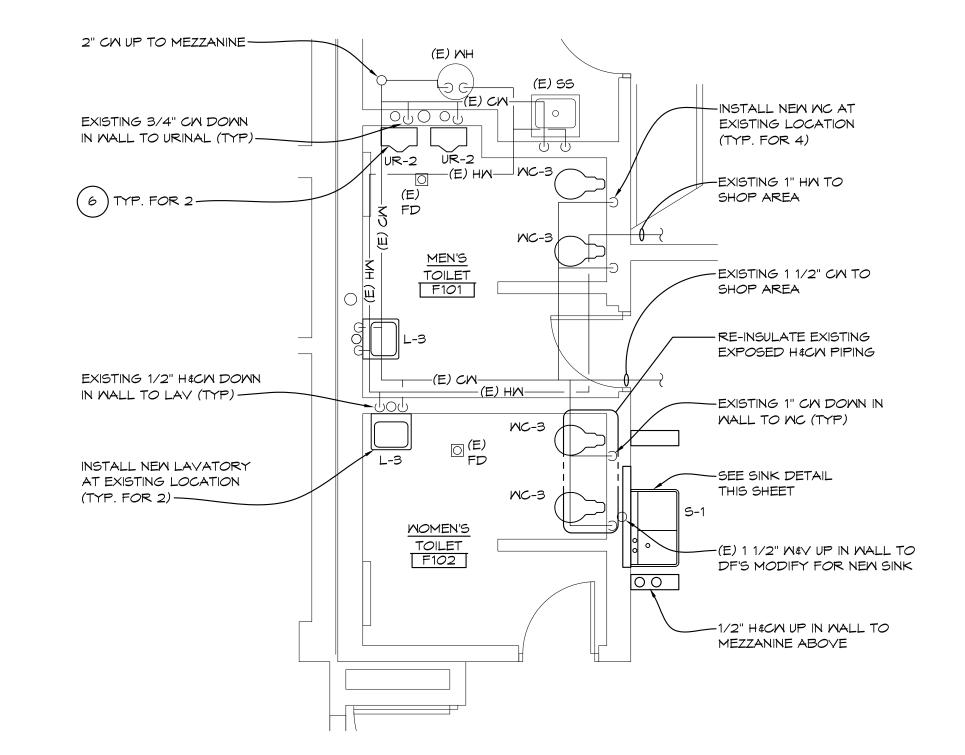

CONSTRUCTION OF THE NEW WORK AS SHOWN CONTRACTOR FIELD VERIFY EXISTING PLUMBING AND REMORK CONNECTIONS FOR NEW TILE WALLS. EXTEND PIPING AND WALL SUPPORTS FOR NEW CONNECTIONS

10. CONTRACTOR TO PROVIDE NEW STOPS, TRAP, RISERS, ETC, FOR NEW PLUMBING WORK.

GENERAL

PLUMBING NOTES

OWNER HAS FIRST RIGHT OF REFUSAL, OTHERWISE

CONTRACTOR SHALL FIELD VERIFY EXISTING COLD

MATER, HOT MATER AND SANITARY CONNECTIONS

FIELD VERIFY ALL EXISTING PIPING AND ADJUST PIPING

ALL WORK SHALL BE SCHEDULE WITH SCHOOL ANY

INTERRUPTIONS OF HEATING, GAS, WATER SERVICE, POWER, ETC. SHALL BE COORDINATED TWO WEEK

COORDINATE ALL WORK WITH ARCHITECTURAL AND

SIZES AND LOCATIONS OF ALL WALLS, OPENINGS,

NOTATIONS ARE MADE IN VARIOUS PLACES ON THE

REQUIRED, HOMEVER, THESE DRAWINGS ARE NOT INTENDED TO SHOW EACH AND EVERY ITEM TO BE

SUBCONTRACTORS FOR THE VARIOUS TRADES SHALL

RESPECTIVE TRADES AS REQUIRED TO PERMIT THE

DRAWINGS TO CALL ATTENTION TO DEMOLITION WHICH IS

EQUIPMENT, ETC REQUIRED OF THESE TRADES.

AT AREAS OF DEMOLITION, CONTRACTOR IS

RESPONSIBLE FOR REMOVING, CAPPING,

DISCONNECTING ALL INCIDENTAL ITEMS.

REMOVED. THE CONTRACTOR AND THE

REMOVE THE MATERIALS RELATED TO THEIR

ELECTRICAL DRAWINGS AND TRADES, VERIFY EXACT

PRIOR TO ORDERING PLUMBING FIXTURES.

AS REQUIRED FOR NEW WORK.

PRIOR TO REQUIRED WORK.

SEE ALL PLANS FOR REQUIRED WORK

DISPOSE FROM SITE.


1. CAP COLD WATER AND HOT WATER PIPING AT MAINS LEAVING NO DEAD LEGS IN PIPING.

ADD ALTERNATE #1 'F' WING TOILET ROOMS ABOVE FLOOR PLUMBING DEMOLITION PLAN 1/4" = 1'-0" XO1

ADD ALTERNATE #1 'F' WING TOILET ROOMS ABOVE FLOOR ENLARGED PLUMBING PLAN

1/4" = 1'-0" XO1

2" CM DOWN TO MAINTENANCE CLOSET ----(E) SS MC-3/ ☐ FD EXISTING 4" CM-EXISTING 3/4" HMR-MC-3 -1/2" H&CM DOWN IN MALL NEW H&CM CONNECT TO TO SINK EXISTING ABOVE MEZZANINE -

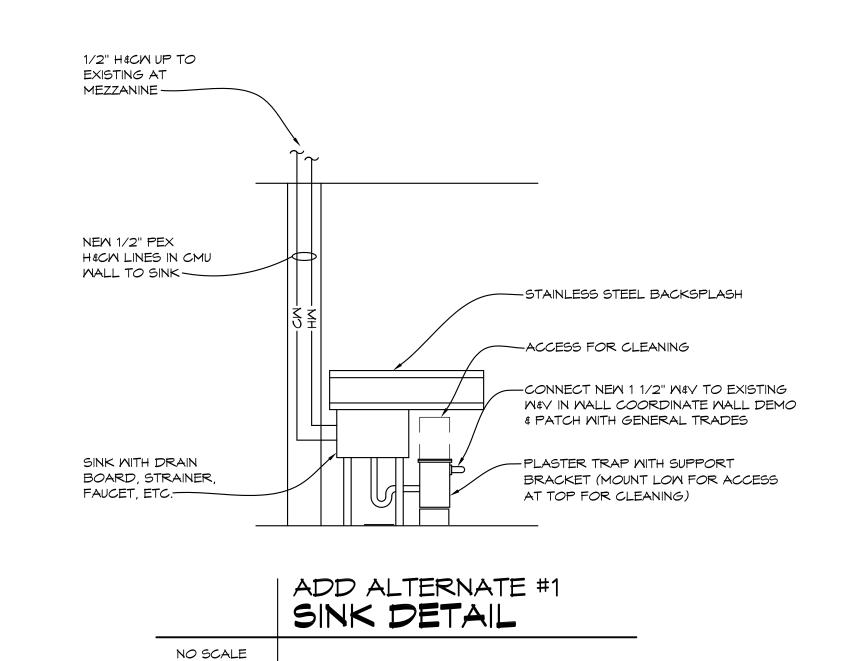

KEYED PLUMBING DEMOLITION NOTES

REMOVE EXISTING WATER CLOSET & FLUSH VALVE FOR NEW TILE WORK, FIXTURE TO BE REINSTALLED AT CURRENT LOCATION.

REMOVE URINAL & FLUSH VALVE

REMOVE EXISTING LAVATORY, FAUCET, TRAP, ETC. FIXTURE TO BE REINSTALLED AT CURRENT LOCATION.

REMOVE EXISTING WATER CLOSET & FLUSH VALVE. FIXTURE TO BE REINSTALLED AT NEW LOCATION, SEAL SANITARY & COLD WATER IN WALL. REMOVE ANY SUPPORTS, BOLTS, ETC. THAT PENETRATE OUT WALL & INTERFERE WITH NEW TILE WORK.

REMOVE SECTION OF COLD WATER PIPING IN CHASE CAP & PROVIDE NEW AIR CHAMBER. REMOVE BLOCK FOR WORK REQUIRED, COORDINATE WITH GENERAL

REMOVE LAVATORY HW, CW, VENT, SANITARY, STOPS, ETC. LAVATORY TO BE REINSTALLED AT A NEW

REMOVE EXISTING URINAL, FLUSH VALVE BACK TO NEW CONNECTION POINT FOR NEW URINAL


REMOVE EXISTING FLOOR MOUNTED WATER CLOSET \$ FLUSH VALVE FOR NEW WATER CLOSET


REMOVE EXISTING LAVATORY, FAUCET, RISER, TRAP, ETC. FOR NEW LAVATORY

REMOVE DRINKING FOUNTAIN & PIPING BACK TO NEW CONNECTION POINT AT NEW SINK

* KEYED PLUMBING NOTES

- REINSTALL EXISTING WATER CLOSET AT EXISTING WATER CLOSET LOCATION (REMOVE & REINSTALL FOR NEW TILE WORK) EXTEND BOLTS & SANITARY COUPLING. PROVIDE NEW GASKET, EXTEND WATER CONNECTION REINSTALL EXISTING FLUSH VALVE AND STOP AT WALL.
- INSTALL EXISTING WATER CLOSET AT ABANDONED WC LOCATION REMOVE CAP AND EXTEND BOLTS & SANITARY COUPLING AND PROVIDE NEW GASKET, EXTEND WATER CONNECTION REINSTALL EXISTING FLUSH VALVE AND STOP AT WALL.
- INSTALL NEW URINAL AT NEW LOCATION. PROVIDE NEW CARRIER, SUPPORTS, CM, WASTE & VENT CONNECTIONS. COORDINATE WITH NEW WALL.
- INSTALL EXISTING LAVATORY AT EXISTING LAVATORY LOCATION, REMOVE & REINSTALL FOR NEW TILE WORK. EXTEND SUPPORTS, HW, CM, WASTE & VENT CONNECTIONS, PROVIDE NEW STOPS, RISERS, TRAP & PIPING.
- 5 INSTALL EXISTING LAVATORY AT NEW LAVATORY LOCATION. CONNECT TO NEW HECM, WEY, PROVIDE NEW CARRIER, SUPPORTS, STOPS, RISERS, TRAP & PIPING.
- 6 INSTALL NEW URINAL AT EXISTING LOCATION. PROVIDE NEW SUPPORT AND SANITARY CONNECTION RECONNECT EXISTING FLUSH VALVE TO EXISTING CM AT MALL. (7) OPEN EXISTING WALL FOR NEW PIPING WORK
- COORDINATE WITH GENERAL TRADES FOR INFILL BELOW NEW TILE WORK
- ADJUST/REPLACE STRAINER AT FLOOR DRAIN TO MATCH NEW FLOOR TILE HEIGHT

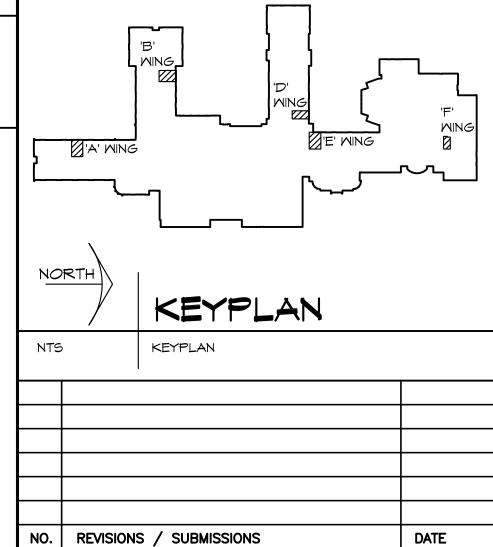

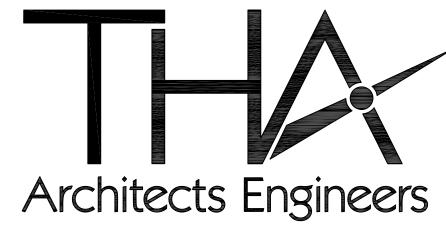

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> PROJECT 'A' RENOVATIONS TO: BULLOCK CREEK

HIGH SCHOOL 1420 SOUTH BADOUR ROAD

MIDLAND, MI

DRAWING TITLE

'F' WING ENLARGED TOILET ROOM PLUMBING PLANS

EAL	DRAWN CJV/KLS	PROJECT NO. 24-12 <i>0</i>
	CHECKED KLS	CAD FILE NO. A-P105
	REVIEWED MLB	DRAWING NO.
	DATE OCT 18, 2024	
	SCALE	SHEET NO.


ADD ALTERNATE #1 'F' WING TOILET ROOMS UNDER FLOOR PLUMBING DEMOLITION PLAN 1/4" = 1'-0" XO1

ADD ALTERNATE #1 'F' WING TOILET ROOMS ABOVE MEZZANINE PLUMBING PLAN

1/4" = 1'-0" XO1

Plot date: 10/22/2024 10:17 AM

AS NOTED 11 OF 15

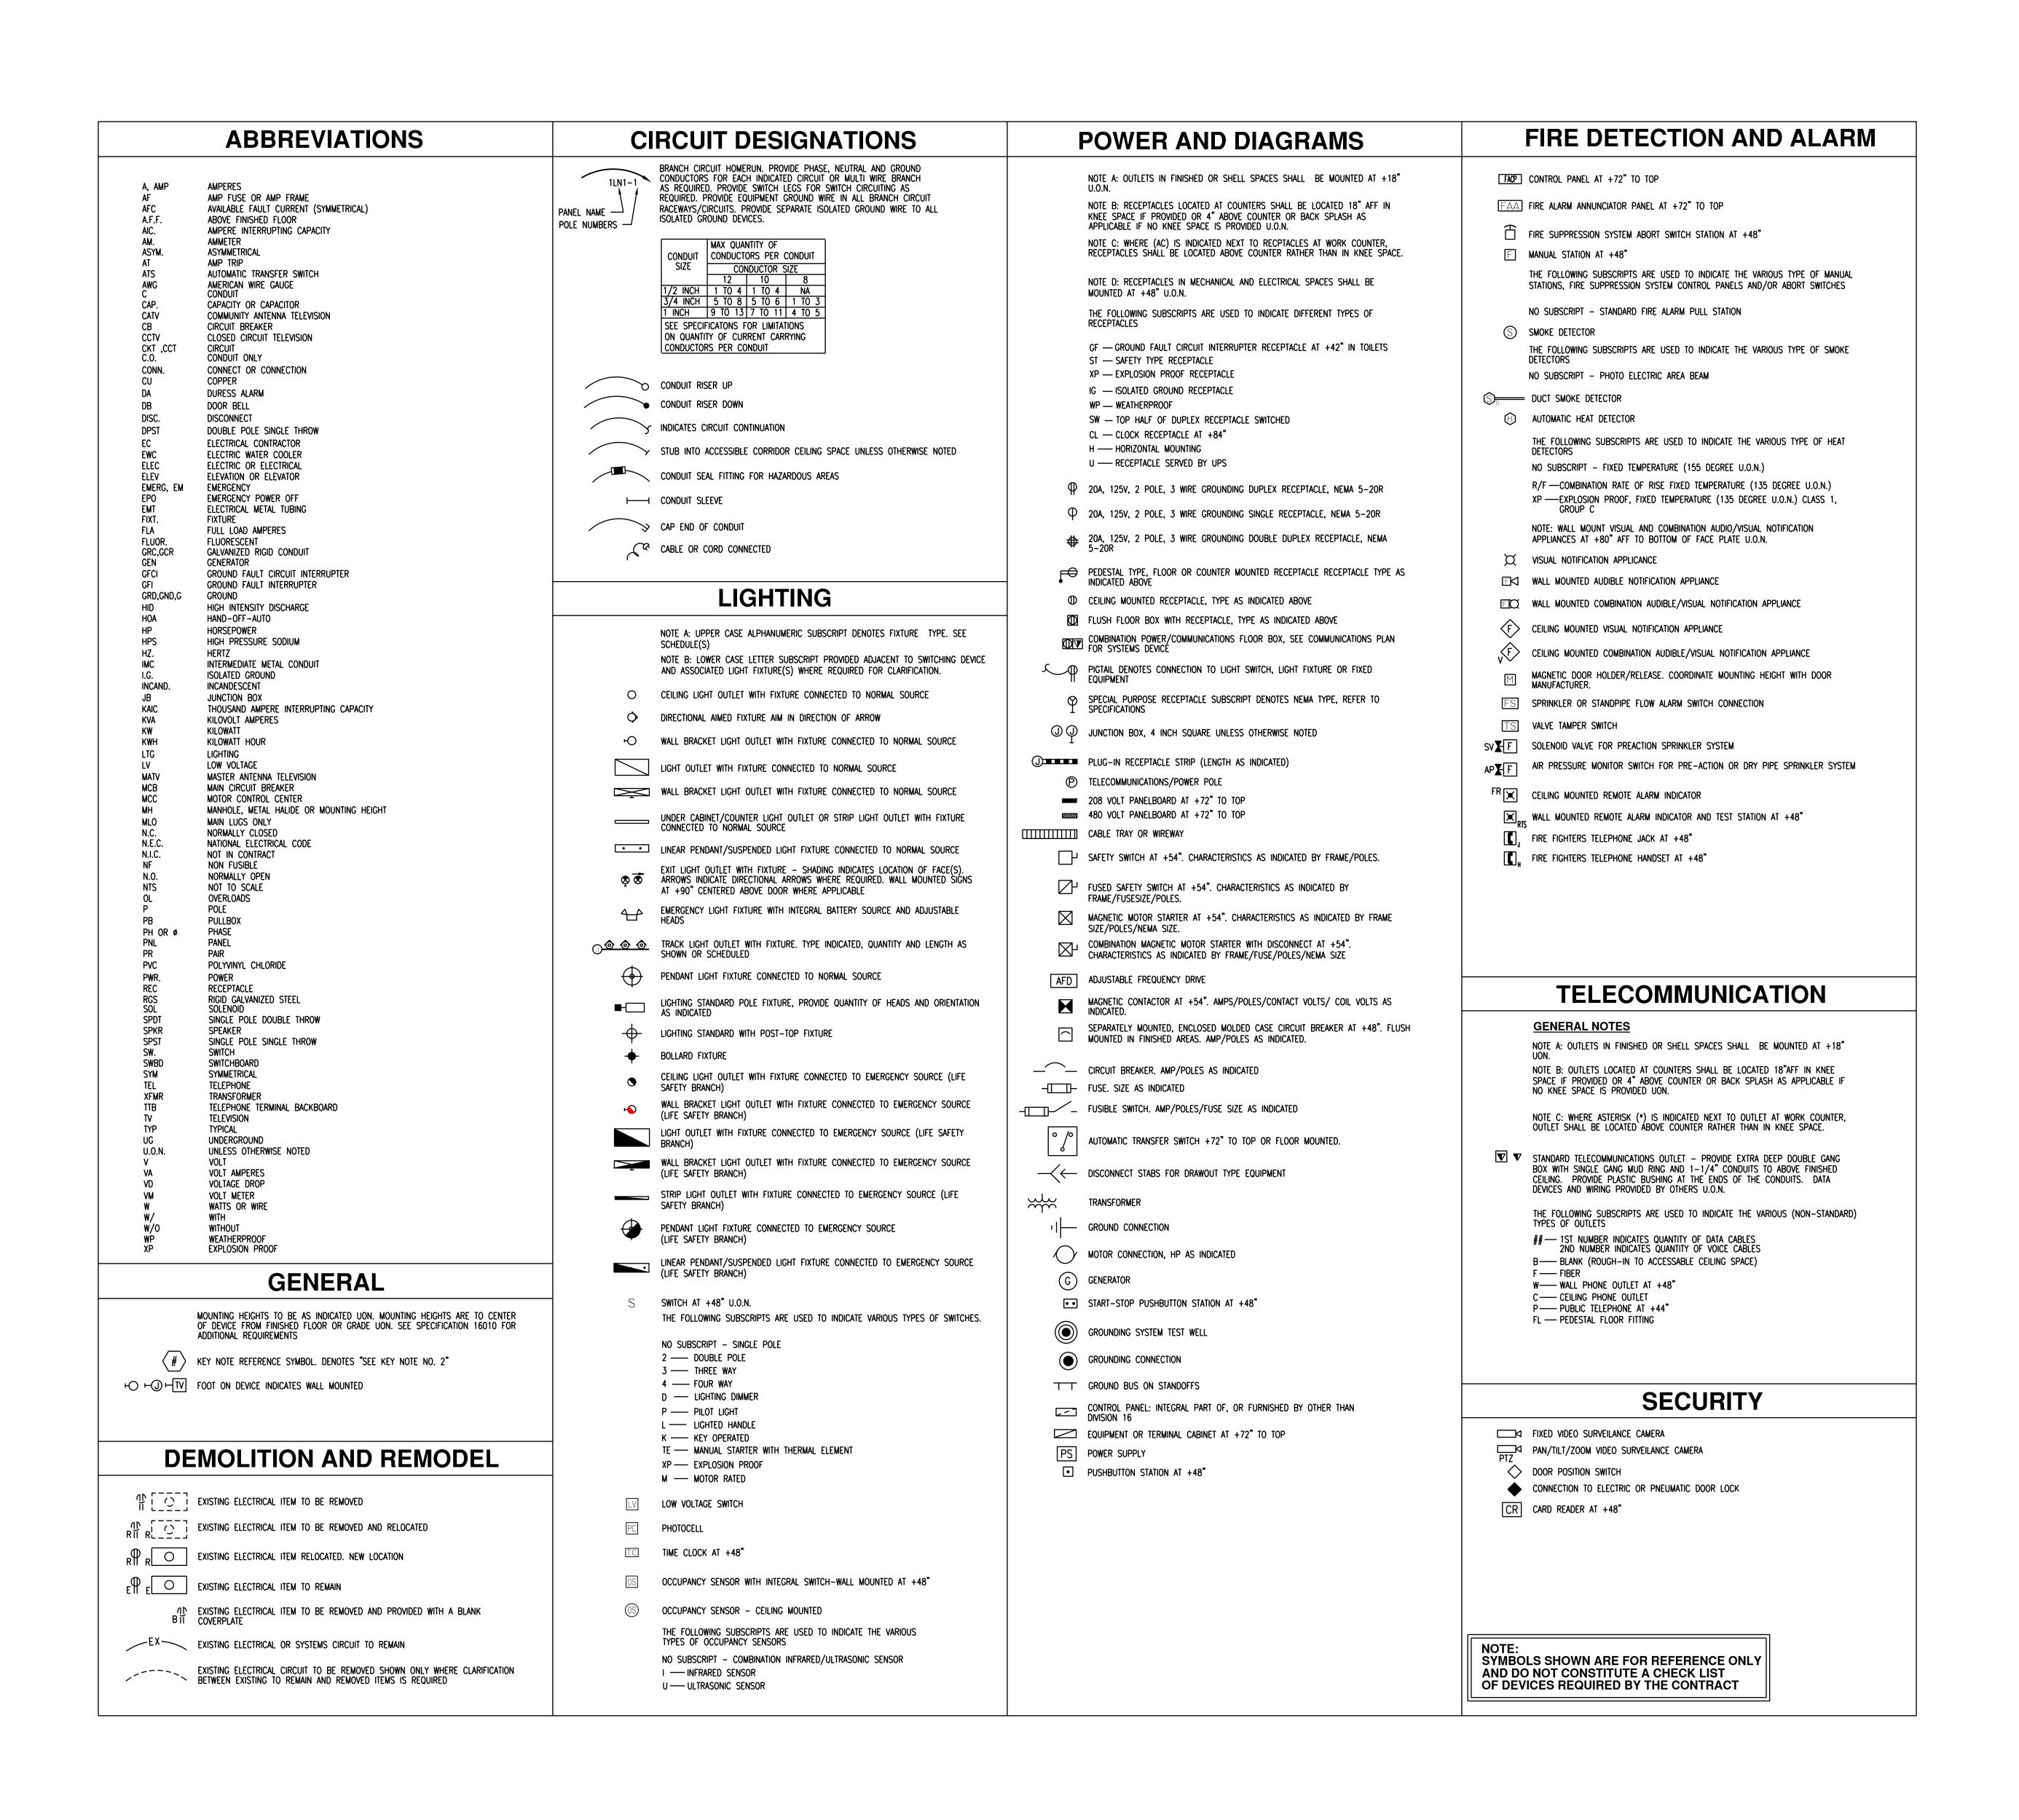

NO. REVISIONS / SUBMISSIONS DATE



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PROJECT 'A' RENOVATIONS TO:
BULLOCK CREEK

HIGH SCHOOL

1420 SOUTH BADOUR ROAD

MIDLAND, MI

DRAWING TITLE

Plot date: 10/21/2024 1:08 PM

ELECTRICAL COVER SHEET

EAL	DRAWN	PROJECT NO.
	ALT	24-120
	CHECKED	CAD FILE NO.
	RCH	A-E000
	REVIEWED	DRAWING NO.
	RCH	A EAA
	DATE	今一旦しして
	OCT 18, 2024	SHEET NO.
	SCALE	
	AS NOTED	<u> 12</u> of <u>15</u>

POLE POSITION LPA-3 AND RETERMINATE TO POSITION LPA-1. DISCONNECT FEEDER FROM POLE POSITION LPA-4 AND RETERMINATE TO POSITION LPA-2.

BREAKERS IN LPA-3 AND LPA-4 TO REMAIN FOR FUTURE

4. EXISTING PANEL TO REMAIN. DISCONNECT FEEDER FROM POLE POSITION DB-3 AND DB-5 AND RETERMINATE TO POSITION DB-1. DISCONNECT FEEDER FROM POLE POSITION DB-4 AND DB-6 AND RETERMINATE TO POSITION DB-2. BREAKERS IN DB-3, DB-5, DB-4, AND DB-6 TO REMAIN FOR FUTURE HAND DRYERS. SEE NEW

5. REMOVE SMITCH. MAINTAIN BOX FOR NEW SMITCH.

8. REMOVE EXISTING WALL MOUNTED FIRE ALARM AS


REQUIRED FOR NEW INSTALLATION.


6. REMOVE SMITCH. REMOVE WIRE AND CONDUIT BACK TO

7. REMOVE EXISTING SPEAKER AND TURN OVER TO OWNER.


REQUIRED FOR NEW WALL TILE WORK. FIXTURE TO BE REINSTALLED ON NEW TILE. REMORK WIRE MOLD AS

HAND DRYERS. SEE NEW PLANS.

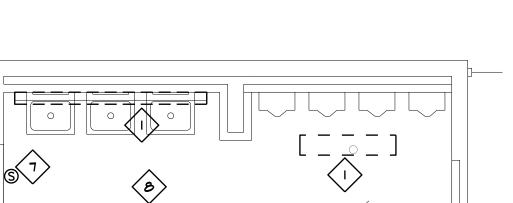


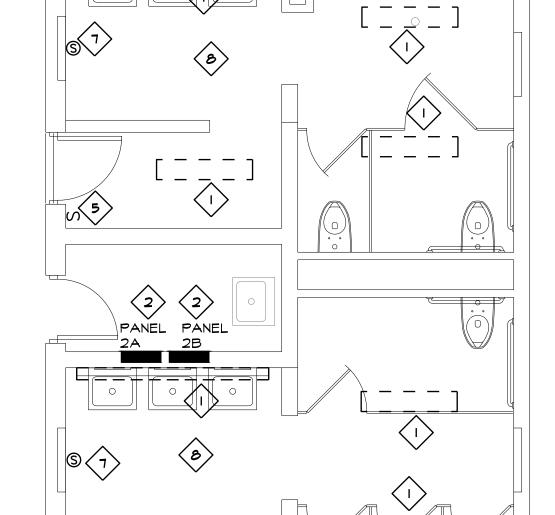


| 'A' WING TOILET ROOMS ENLARGED PLAN 1/4" = 1'-0" XO1

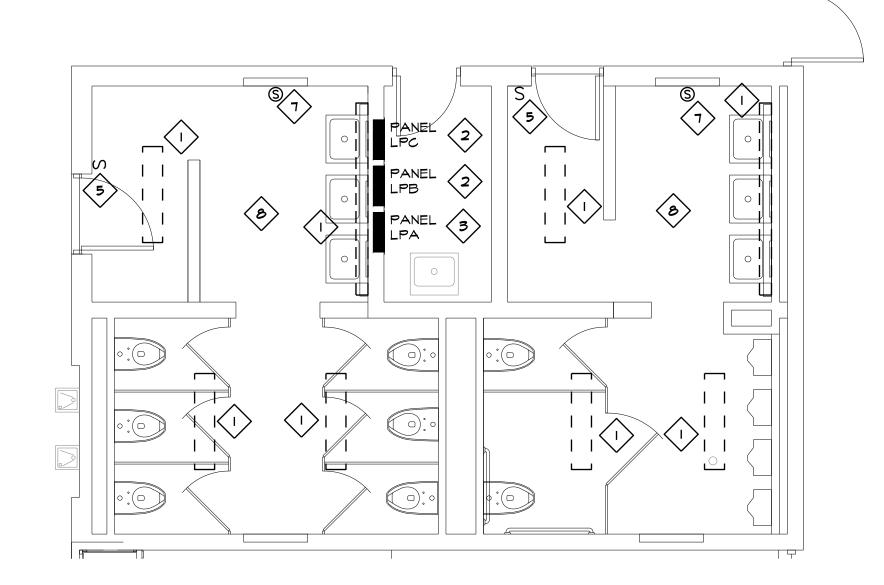


'B' WING TOILET ROOMS ENLARGED PLAN

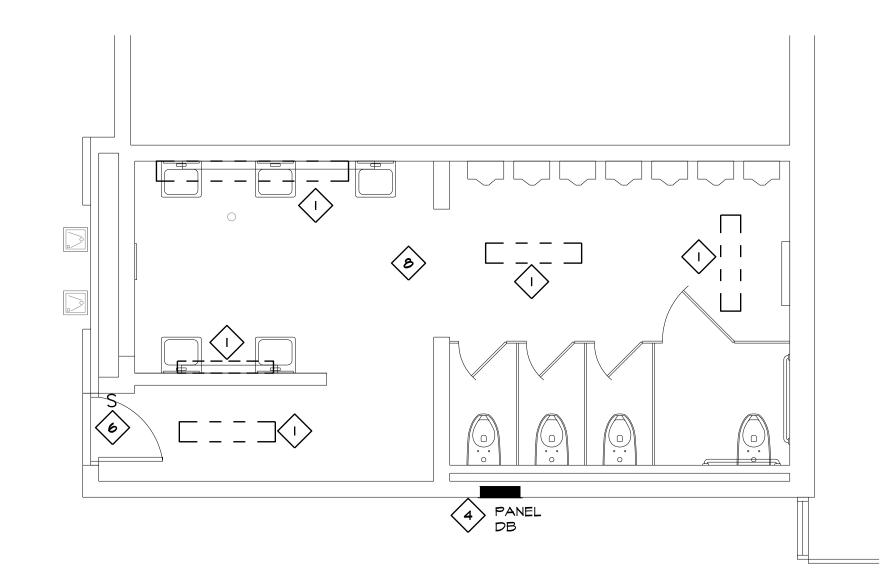



'D' WING TOILET ROOM 3 ENLARGED PLAN

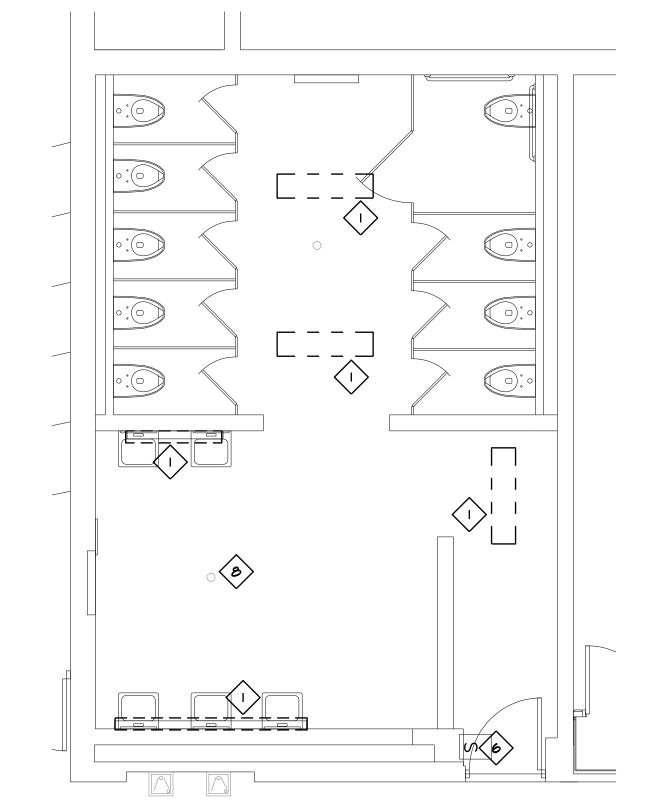

'E' WING TOILET ROOM ENLARGED PLAN

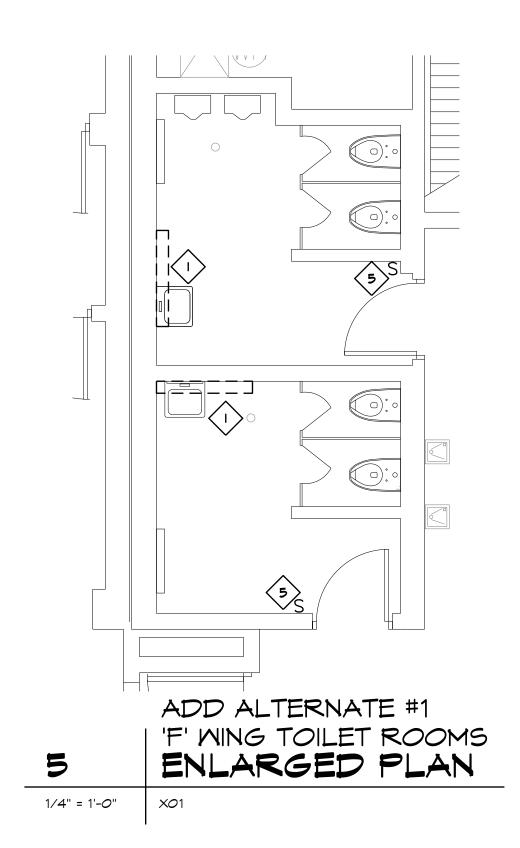

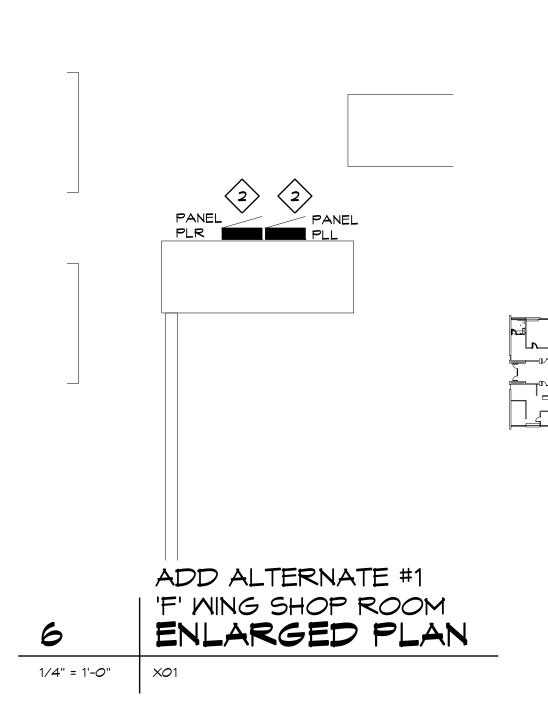

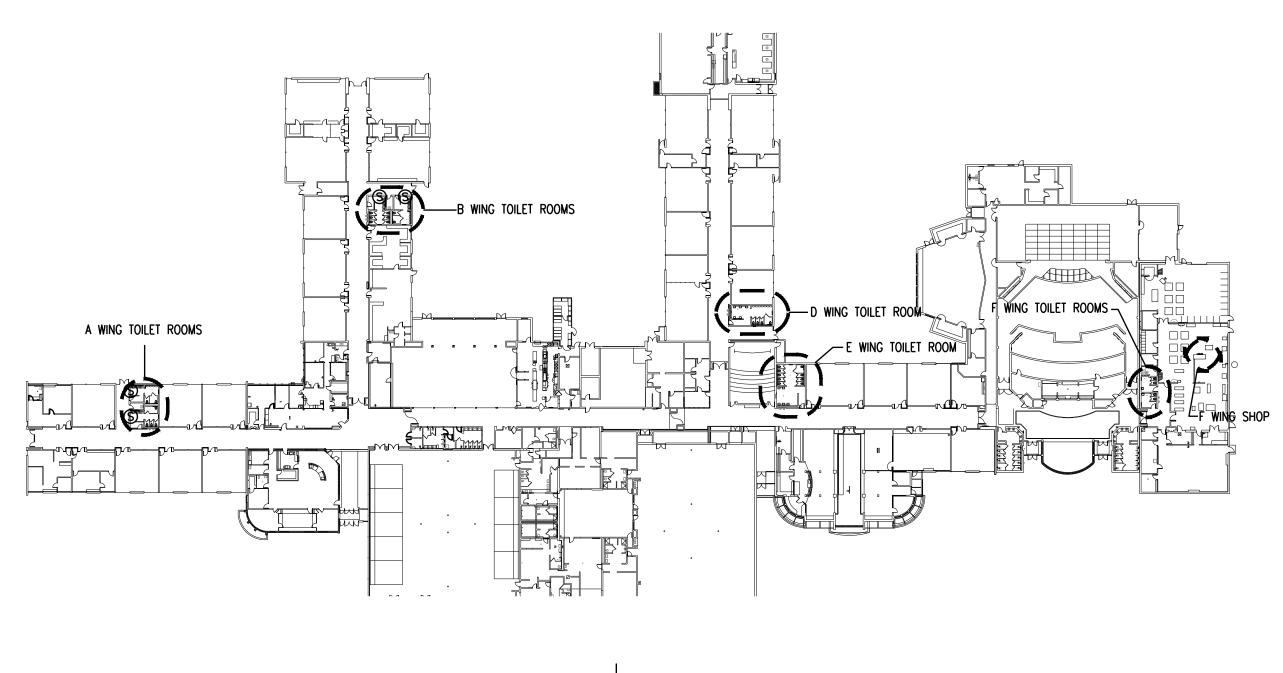

KEY PLAN

NO. REVISIONS / SUBMISSIONS

Architects Engineers

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> PROJECT 'A' RENOVATIONS TO: BULLOCK CREEK

HIGH SCHOOL 1420 SOUTH BADOUR ROAD


MIDLAND, MI


DRAWING TITLE

TOILET ROOM ELECTRICAL DEMOLITION PLANS


	ALT	24-12 <i>0</i>
	CHECKED RCH	CAD FILE NO. A-E101
	REVIEWED	DRAWING NO.
	RCH	X =1_1_1
	DATE OCT 18, 2024	A-EIOI
	SCALE AS NOTED	SHEET NO.
THA Architects Engineers - A-E101 TOILET I	ROOM ELECTRICAL DEMOLITIC	ON PLANS

PROJECT NO.

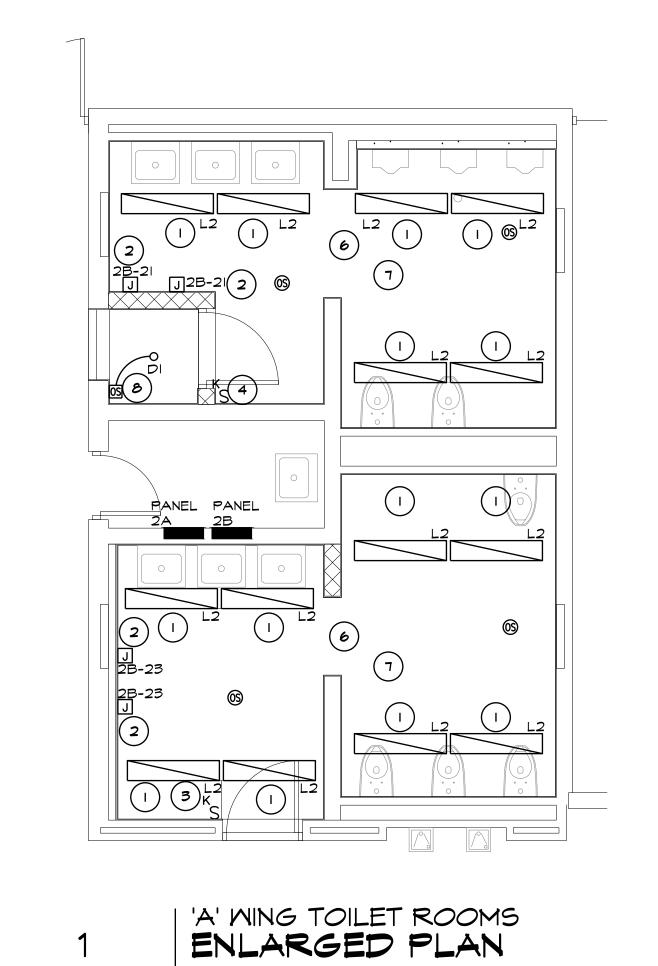

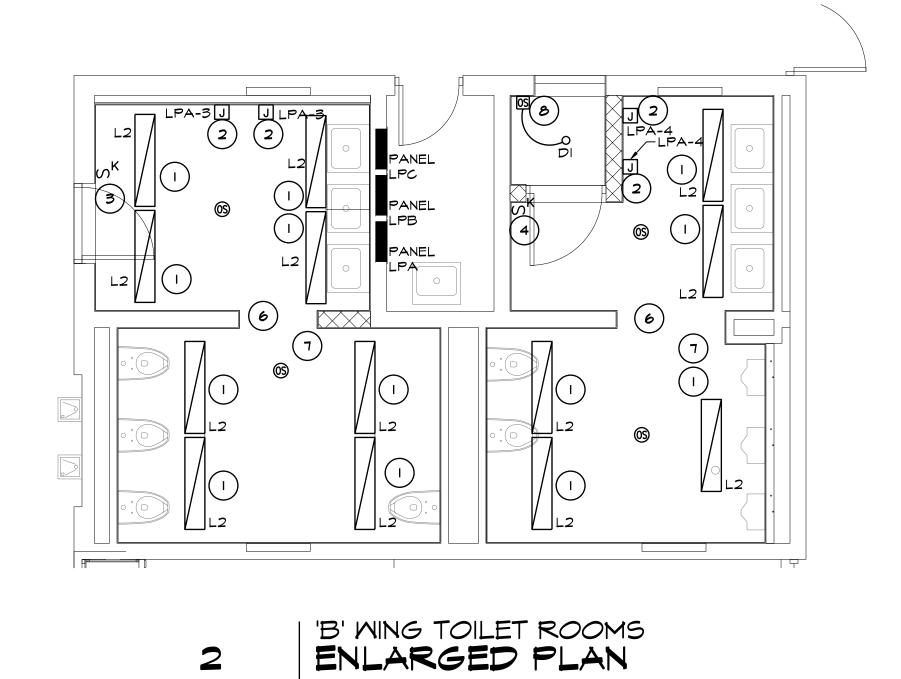


1/4" = 1'-0"

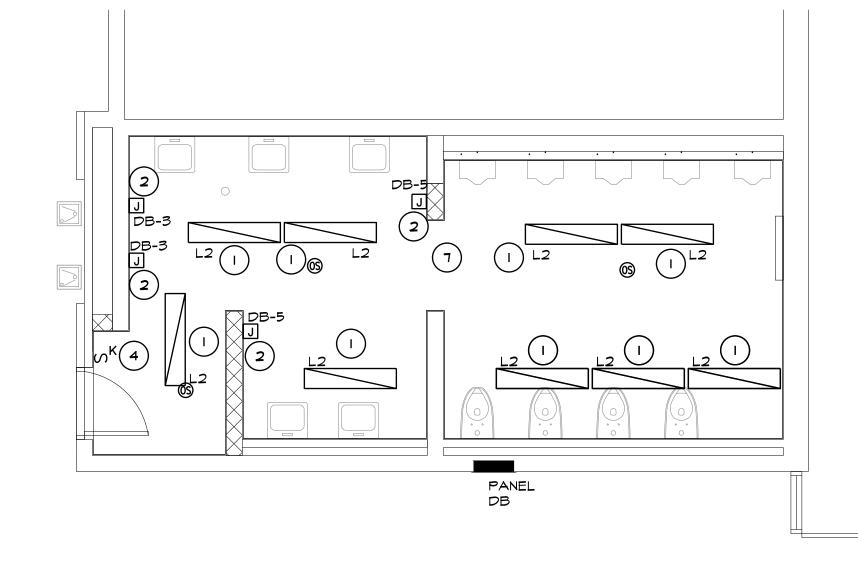


3 ENLARGED PLAN


1/4" = 1'-0" X01

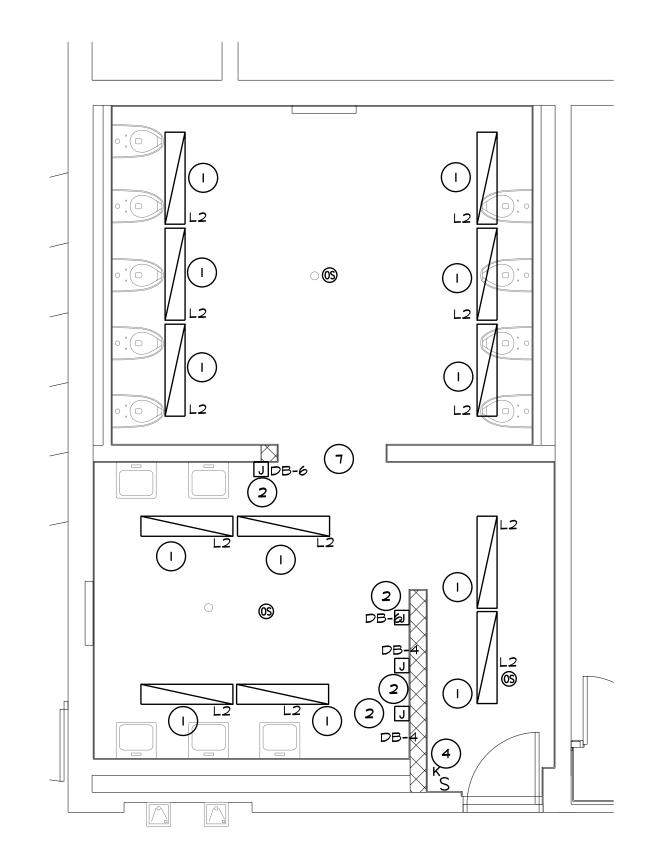

1/4" = 1'-0"



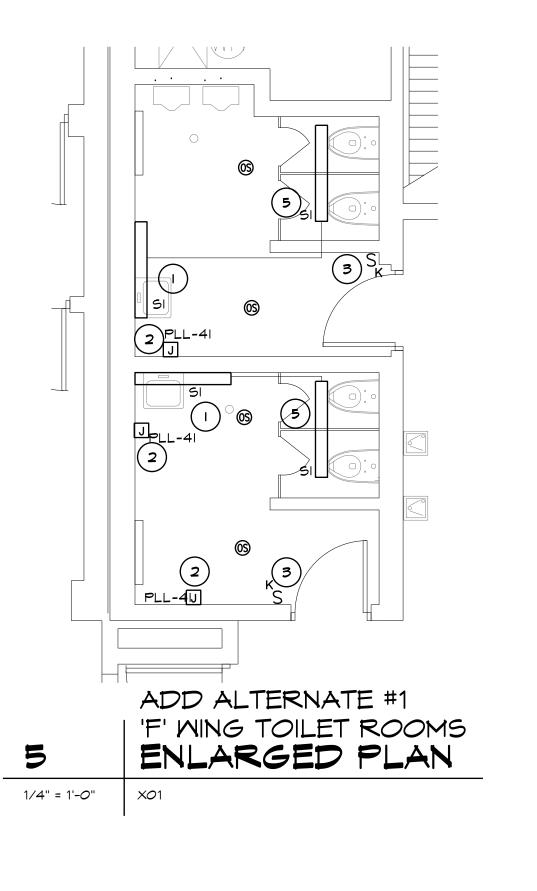

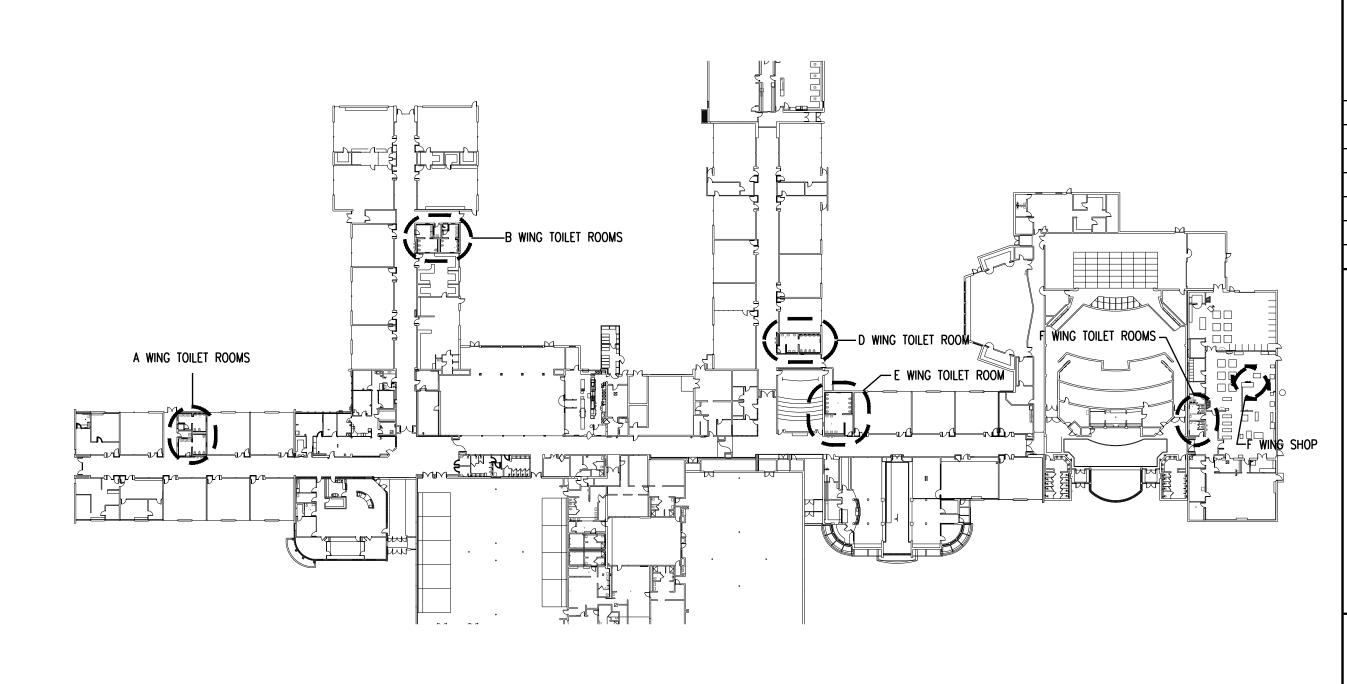

6 KEY PLAN

1/64" = 1'-0" X01

O CONSTRUCTION NOTES

- PROVIDE CONNECTION TO NEW LIGHT FIXTURES FROM EXISTING CIRCUIT. EXTEND FEEDERS FROM JUNCTION BOX TO NEW LIGHT FIXTURES.
- 2. PROVIDE CONNECTION TO NEW HAND DRYER FROM CIRCUIT BREAKER AS SHOWN.
- 3. PROVIDE NEW KEYED SWITCH IN EXISTING BOX.
- 4. PROVIDE NEW SWITCH FOR CONTROLS TO SPACE.
- 5. EXTEND LIGHTING CIRCUIT AND CONTROLS TO NEW FIXTURE.
- 6. NEW CEILING MOUNTED SPEAKER. EXTEND EXISTING SPEAKER WIRE AS NEED FOR NEW SPEAKER.
- 7. RE-INSTALL EXISTING FIRE ALARM ON NEW WALL TILE.
- REMORK MIRE MOLD AS REQUIRED FOR NEW DEVICE.
- 8. PROVIDE NEW WALL OCCUPANCY SENSOR/SWITCH IN EXISTING BOX.

NO. REVISIONS / SUBMISSIONS DATE

Architects Engineers

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PROJECT 'A' RENOVATIONS TO:
BULLOCK CREEK


HIGH SCHOOL

1420 SOUTH BADOUR ROAD
MIDLAND, MI

DRAWING TITLE

TOILET ROOM ELECTRICAL PLANS


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		REVIEWED RCH	DRAWING NO.
		DATE OCT 18, 2024	A-E102 SHEET NO.
		SCALE	14 OF 15

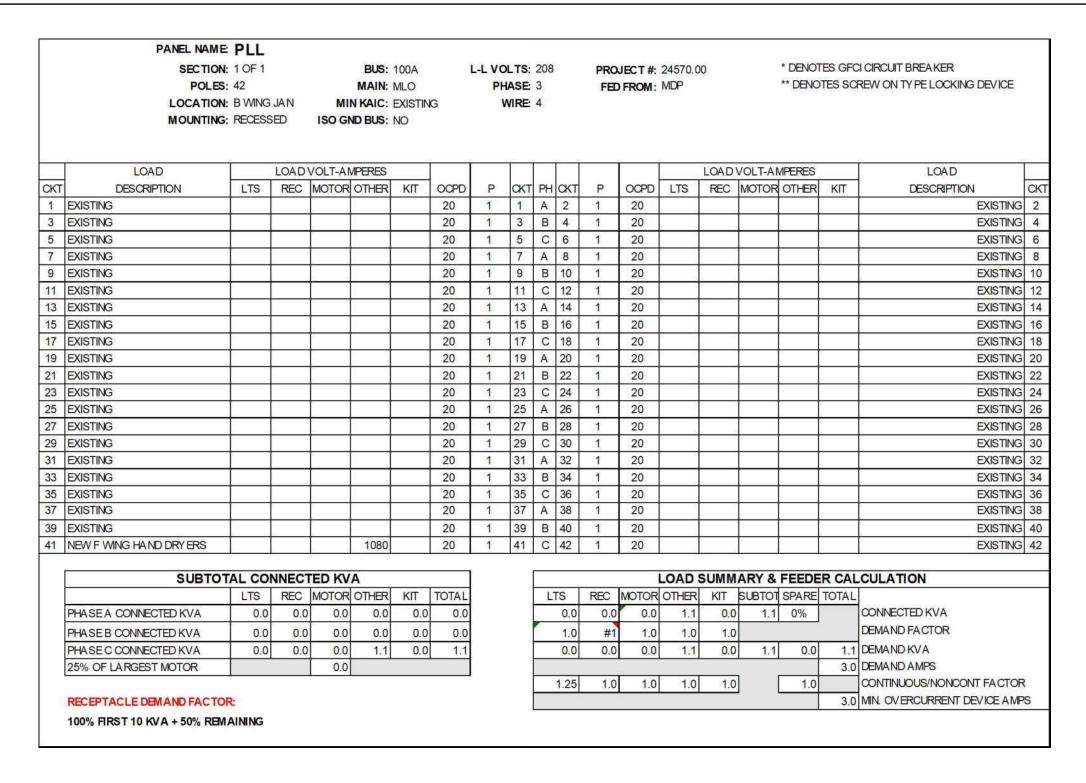


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5	BOYS NEW HAND DRYERS				1080		20	1	5	С	6	1	20				1,080	-	GIRLS NEW HAND DRY ERS	-
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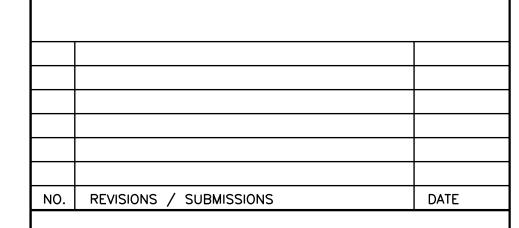
	PANEL NAME SECTION POLES	t 1 OF 1 c: 42			BUS:			L-L VO	LTS:		3		JECT#: FROM:	24570.0 MDP	0				OI CIRCUIT BREAKER CREW ON TY PE LOCKING DEVICE	
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CKT	DESCRIPTION	LTS	REC	MOTOR	OTHER	KIT	OCPD	Р	CKT	PH	СКТ	P	OCPD	LTS	REC	MOTOR	OTHER	KIT	DESCRIPTION	
1	EX. CIRC 1 & 3 LOAD						20	1	1	Α	2	1	20						EX. CIRC 2 & 4 LOAI	D
3	GIRLS NEW HAND DRY ERS				1080		20	1	3	В	4	1	20				1,080		BOYS NEW HAND DRY ERS	S
5	EXISTING					ĺ	20	1	5	С	6	1	20						EXISTING	3
7	EXISTING						20	1	7	Α	8	1	20						EXISTING	3
9	EXISTING						20	1	9	В	10	1	20						EXISTING	G
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17	EXISTING						20	1	17	С	18	1	20						EXISTING	3
19	EXISTING						20	1	19	Α	20	1	20						EXISTING	3
21	EXISTING						20	1	21	В	22	1	20						EXISTING	3
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37	EXISTING						20	1	37	Α	38	1	20						EXISTING	3
39	EXISTING						20	1	39	В	40	1	20						EXISTING	3
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	G C										1.25	1.0	1.0	1.0	1.0		1.0		CONTINUOUS/NONCONT FACTO	R
	RECEPTACLE DEMAND FACTO	R·								0	Nav Section	0705	1555	(5825)	505/			6.0	MIN. OVERCURRENT DEVICE AM	

	PANEL NAME: 2B																				
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	LOCATION	: A WING	JANITO	R MI	N KAIC:	EXISTIN	G	٧	VIRE:	4											
	MOUNTING	: RECESS	SED	ISO GN	ND BUS:	NO															
	LOAD	Ĭ	LOAD	VOLT-AN	MPERES .		ı		Î		П				LOAD	VOLT-AN	//PERES		LOAD	Ť	
CKT	DESCRIPTION	LTS	REC	MOTOR	OTHER	KIT	OCPD	Р	СКТ	PH	СКТ	P	OCPD	LTS	REC	MOTOR	OTHER	KIT	DESCRIPTION	CH	
1	EXISTING			8			20	1	1	Α	2	1	20		*				EXISTIN	VG 2	
3	EXISTING						20	1	3	В	4	1	20						EXISTIN	VG 4	
5	EXISTING			9. 7.			20	1	5	С	6	1	20		· .				EXISTIN	VG 6	
7	EXISTING						20	1	7	Α	8	1	20						EXISTIN	VG 8	
9	EXISTING						20	1	9	В	10	1	20						EXISTIN	VG 10	
11	EXISTING		8	2 5			20	1	11	С	12	1	20						EXISTIN	VG 12	
13	EXISTING		6.	2 8			20	1	13	Α	14	1	20						EXISTIN	VG 14	
15	EXISTING			g 8			20	1	15	В	16	1	20						EXISTIN	VG 16	
17	EXISTING			S 5			20	1	17	С	18	1	20						EXISTIN	VG 18	
19	EXISTING						20	1	19	Α	20	1	20						EXISTIN	VG 20	
21	BOYS NEW HAND DRYERS			0	1080		20	1	21	В	22	1	20		, ,				EXISTIN	VG 22	
23	GIRLS NEW HAND DRYERS				1080		20	1	23	С	24	1	20						EXISTIN	VG 24	
25	EXISTING			85 SS			20	1	25	Α	26	1	20						EXISTIN	VG 26	
27	EXISTING						20	1	27	В	28	1	20						EXISTIN	VG 28	
29	EXISTING						20	1	29	С	30	1	20						EXISTIN	VG 30	
31	EXISTING			m s		3	20	1	31	Α	32	1	20	8 818					EXISTIN	VG 32	
33	EXISTING			6 2			20	1	33	В	34	1	20						EXISTIN	VG 34	
35	EXISTING						20	1	35	С	36	1	20						EXISTIN	VG 36	
37	EXISTING			W. X.			20	1	37	Α	38	1	20						EXISTIN	VG 38	
39	EXISTING						20	1	39	В	40	1	20						EXISTIN	VG 40	
41	EXISTING						20	1	41	С	42	1	20						EXISTIN	VG 42	
	SUBTO	TAL COL	NNECT	FD KV	Δ									I OAD S	NMUS	ARY &	FFFDF	R CAI	CULATION		
	SUBTOTAL CONNECTED KVA LTS REC MOTOR OTHER KIT TOT.									L	TS	REC	MOTOR				SPARE				
	PHASE A CONNECTED KVA	0.0	0.0	0.0	0.0	0.0	0.0				0.0	0.0	0.0	2.2	0.0	2.2	0%		CONNECTED KVA		
	PHASE B CONNECTED KVA	0.0	0.0	0.0	1.1	0.0	1.1				1.0	#1	1.0	1.0	1.0		,		DEMAND FACTOR		
	PHASE C CONNECTED KVA	0.0		-	1.1	0.0					0.0	0.0		_	0.0		0.0	2.2	DEMAND KVA		
	25% OF LARGEST MOTOR			0.0														6.0	DEMAND AMPS		
1		t.									1.25	1.0	1.0	1.0	1.0]	1.0		CONTINUOUS/NONCONT FACTO	OR	
	RECEPTACLE DEMAND FACTO	D.									W4102755	10000	3707/	2000	725	•	1000		MIN. OVERCURRENT DEVICE AI		



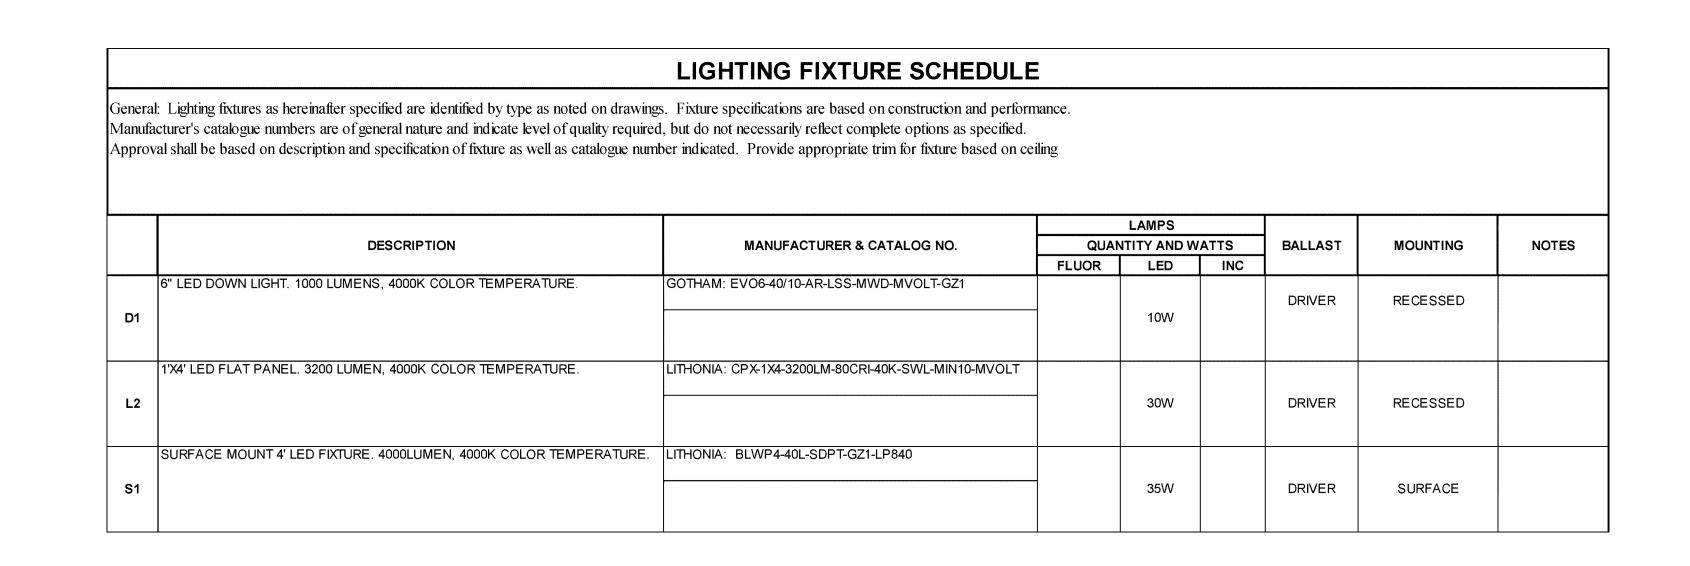

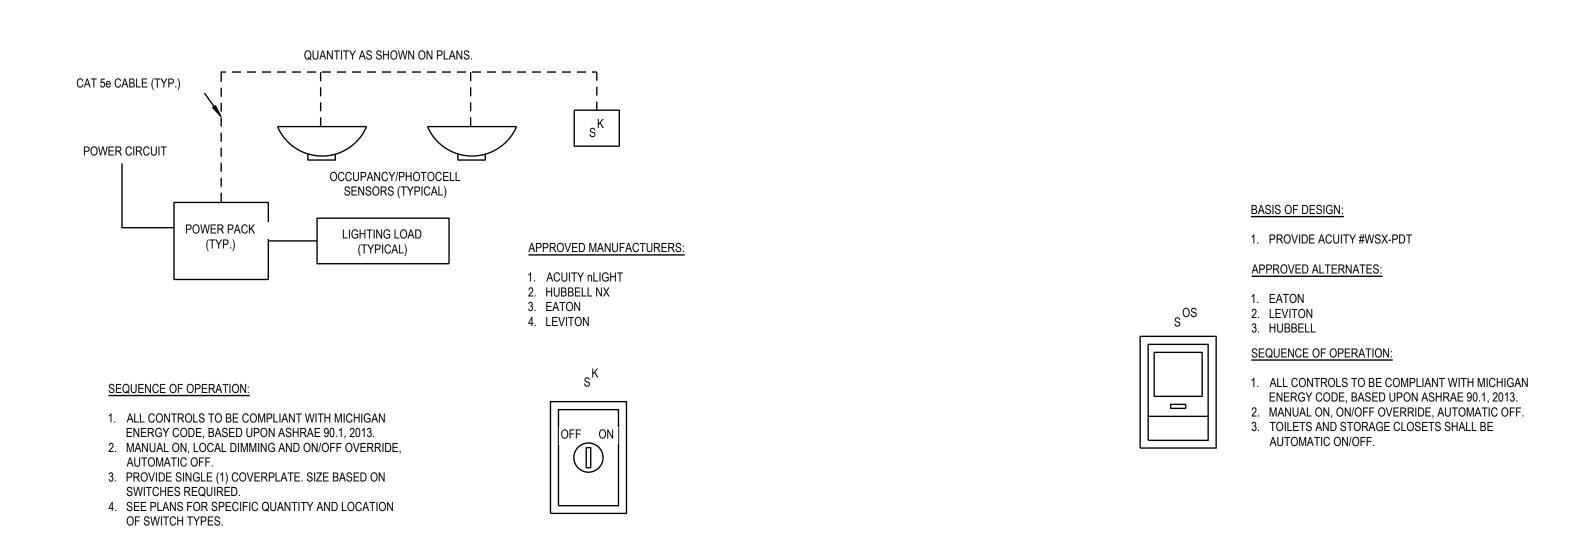TYPICAL LIGHTING CONTROLS	1	MALL OCC SENSOR SMITCH
XO1	N.T.5	XO1





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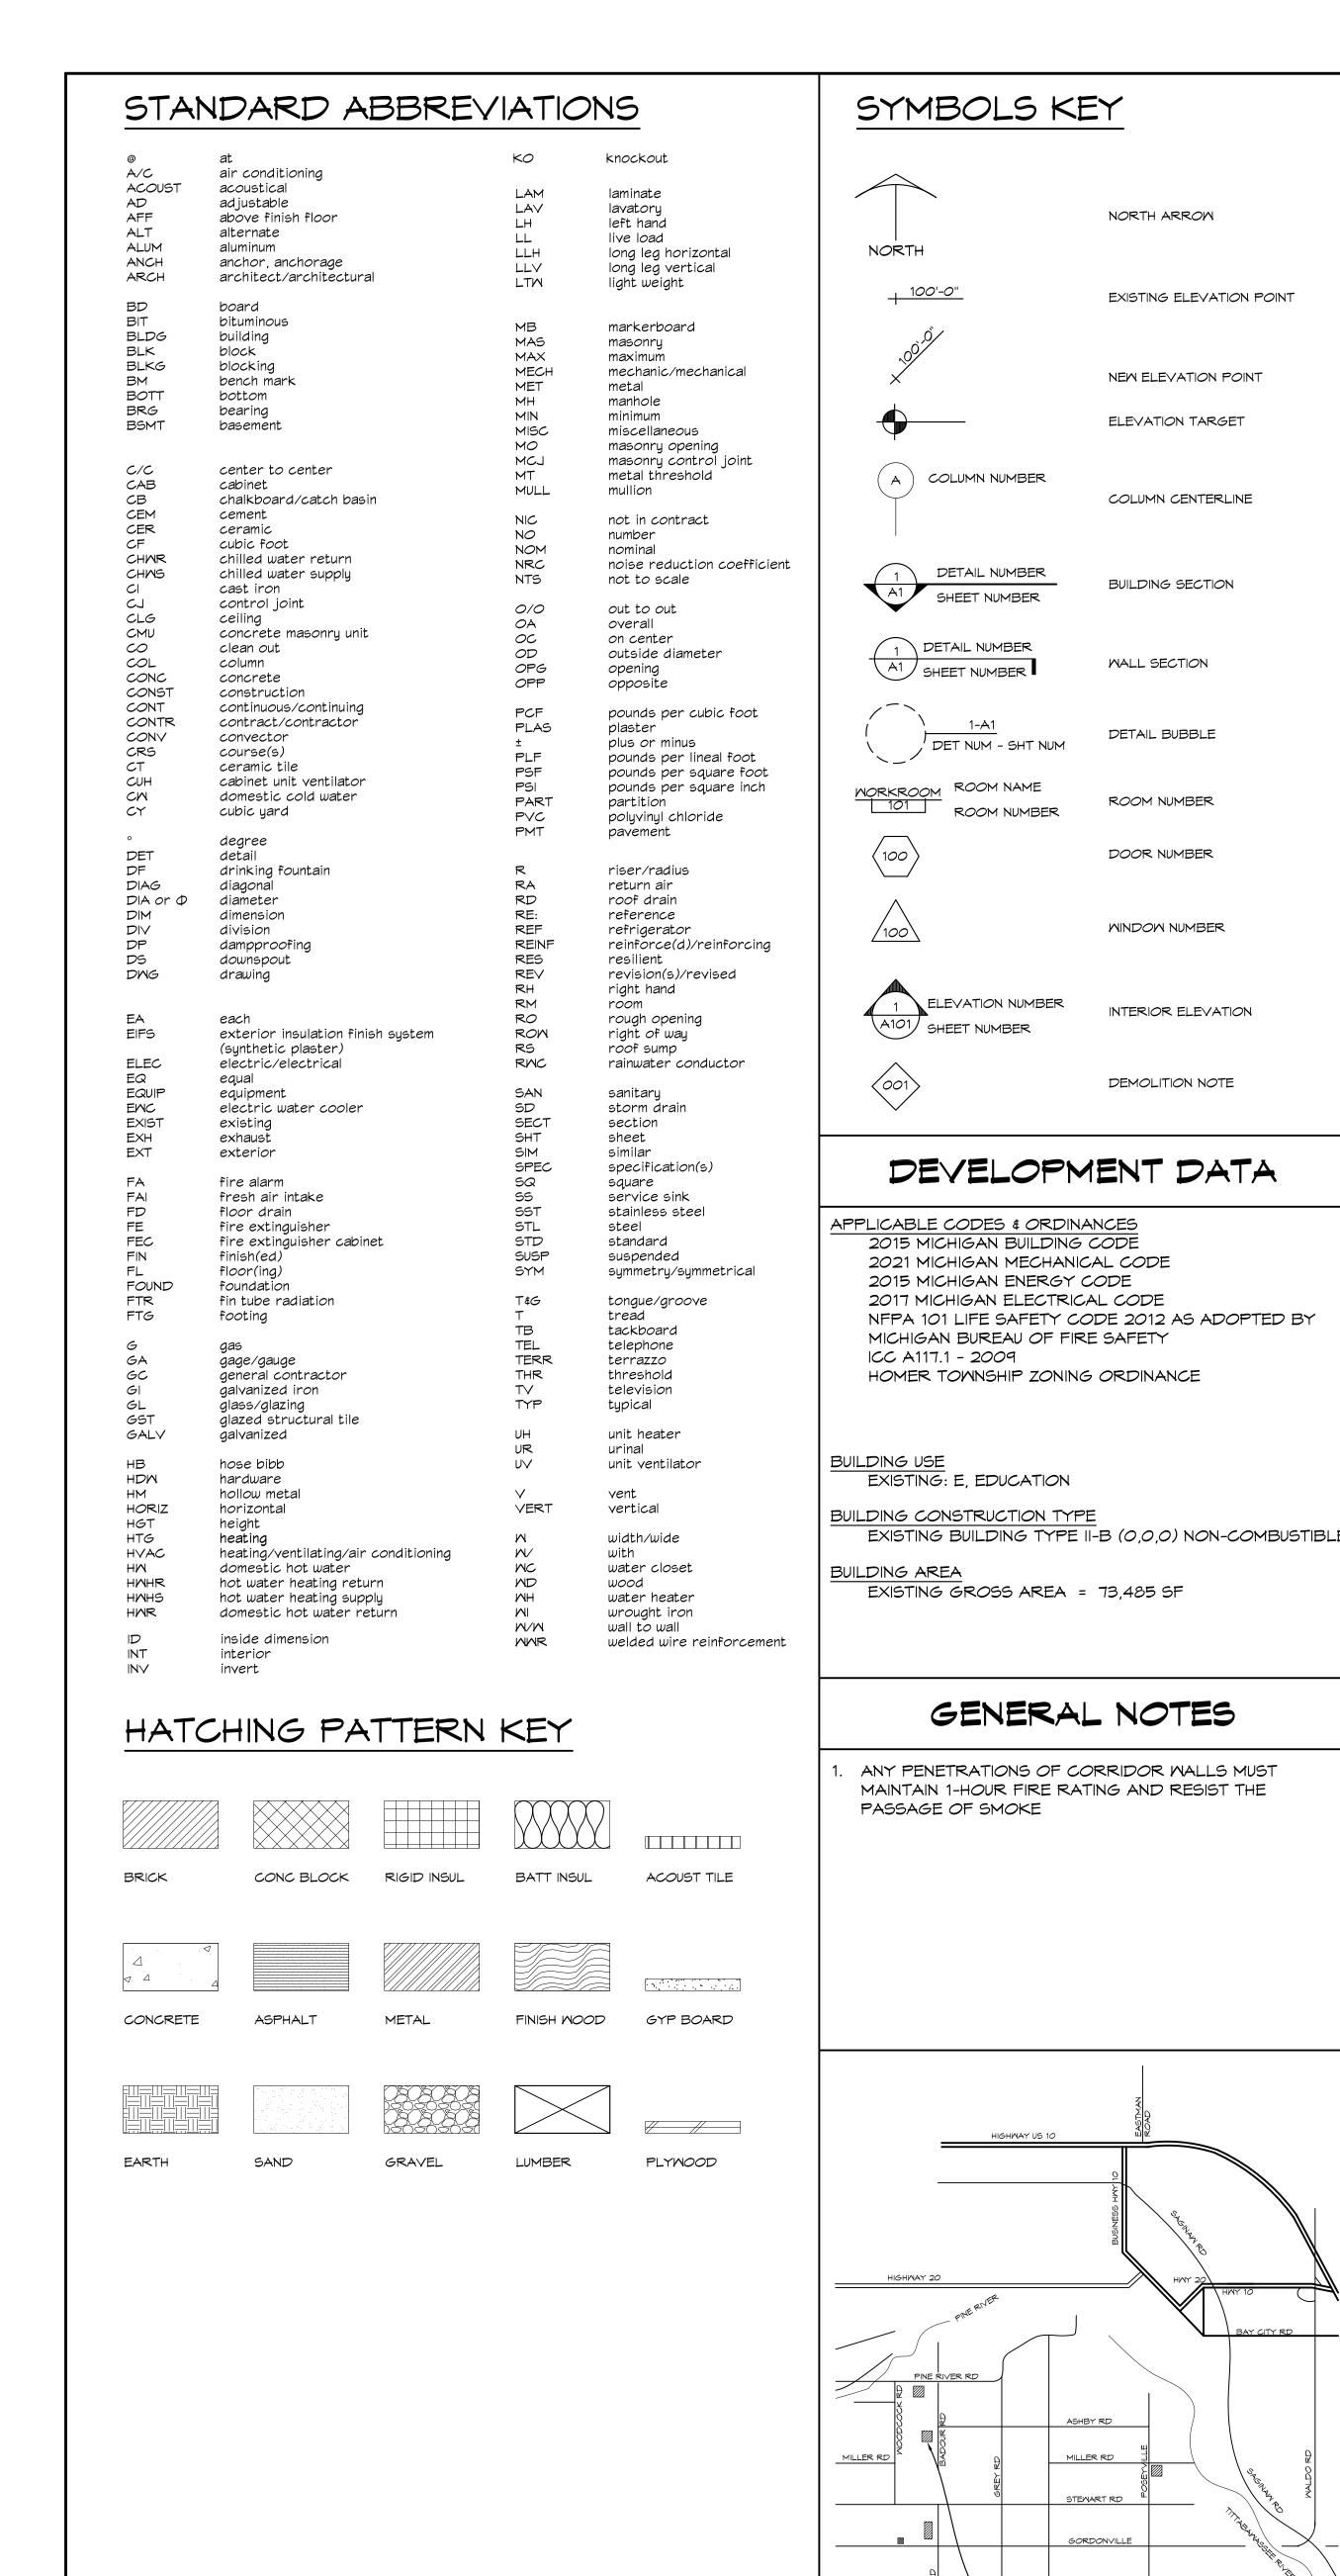
PROJECT 'A' RENOVATIONS TO:
BULLOCK CREEK
HIGH SCHOOL

1420 SOUTH BADOUR ROAD MIDLAND, MI

DRAWING TITLE

ELECTRICAL DETAILS AND SCHEDULES

SEAL	TJA	24-120
	CHECKED RCH	CAD FILE NO. A-E601
	REVIEWED RCH	DRAWING NO.
	DATE OCT 18, 2024	A-E601 SHEET NO.
	SCALE AS NOTED	15 OF 15



BULLOCK CREEK SCHOOL DISTRICT 2023 BOND- SERIES 1 2025 IMPROVEMENTS THA PROJECT #24-120

1420 SOUTH BADOUR ROAD MIDLAND MI 48640

PROJECT 'B' BULLOCK CREEK MIDDLE SCHOOL IMPROVEMENTS

664 SOUTH BADOUR ROAD MIDLAND MI 48640

INDEX OF DRAWINGS

TITLE SHEET

SIGNAGE PLAN AND ELEVATION

COOLER/REFRIGERATOR DEMOLITION PLAN, FLOOR PLAN

DETAILS

-BULLOCK CREEK

LOCATION MAP


NO SCALE

MIDDLE SCHOOL

FOOD SERVICE EQUIPMENT FLOOR PLAN, SCHEDULE B-F51


UTILITIES AND SPECIAL CONDITIONS

ELECTRICAL COVER SHEET ELECTRICAL PLANS

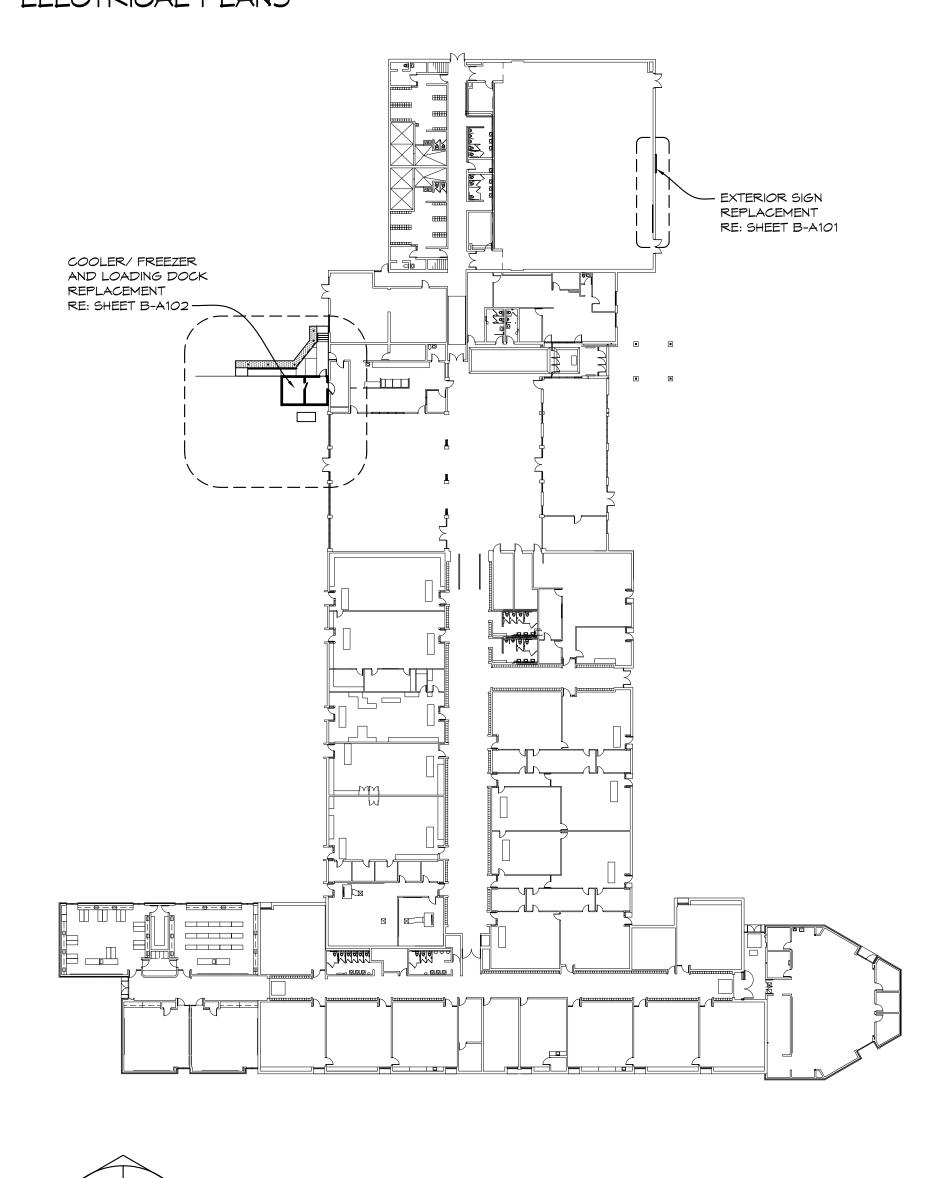


COMPOSITE PLAN



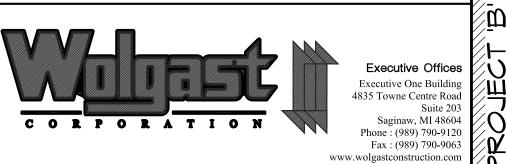


NO. | REVISIONS / SUBMISSIONS PROJECT NO. CAD FILE NO. B-GOO1


B S ← E C B § Plot date: 10/23/2024 9:53 AM

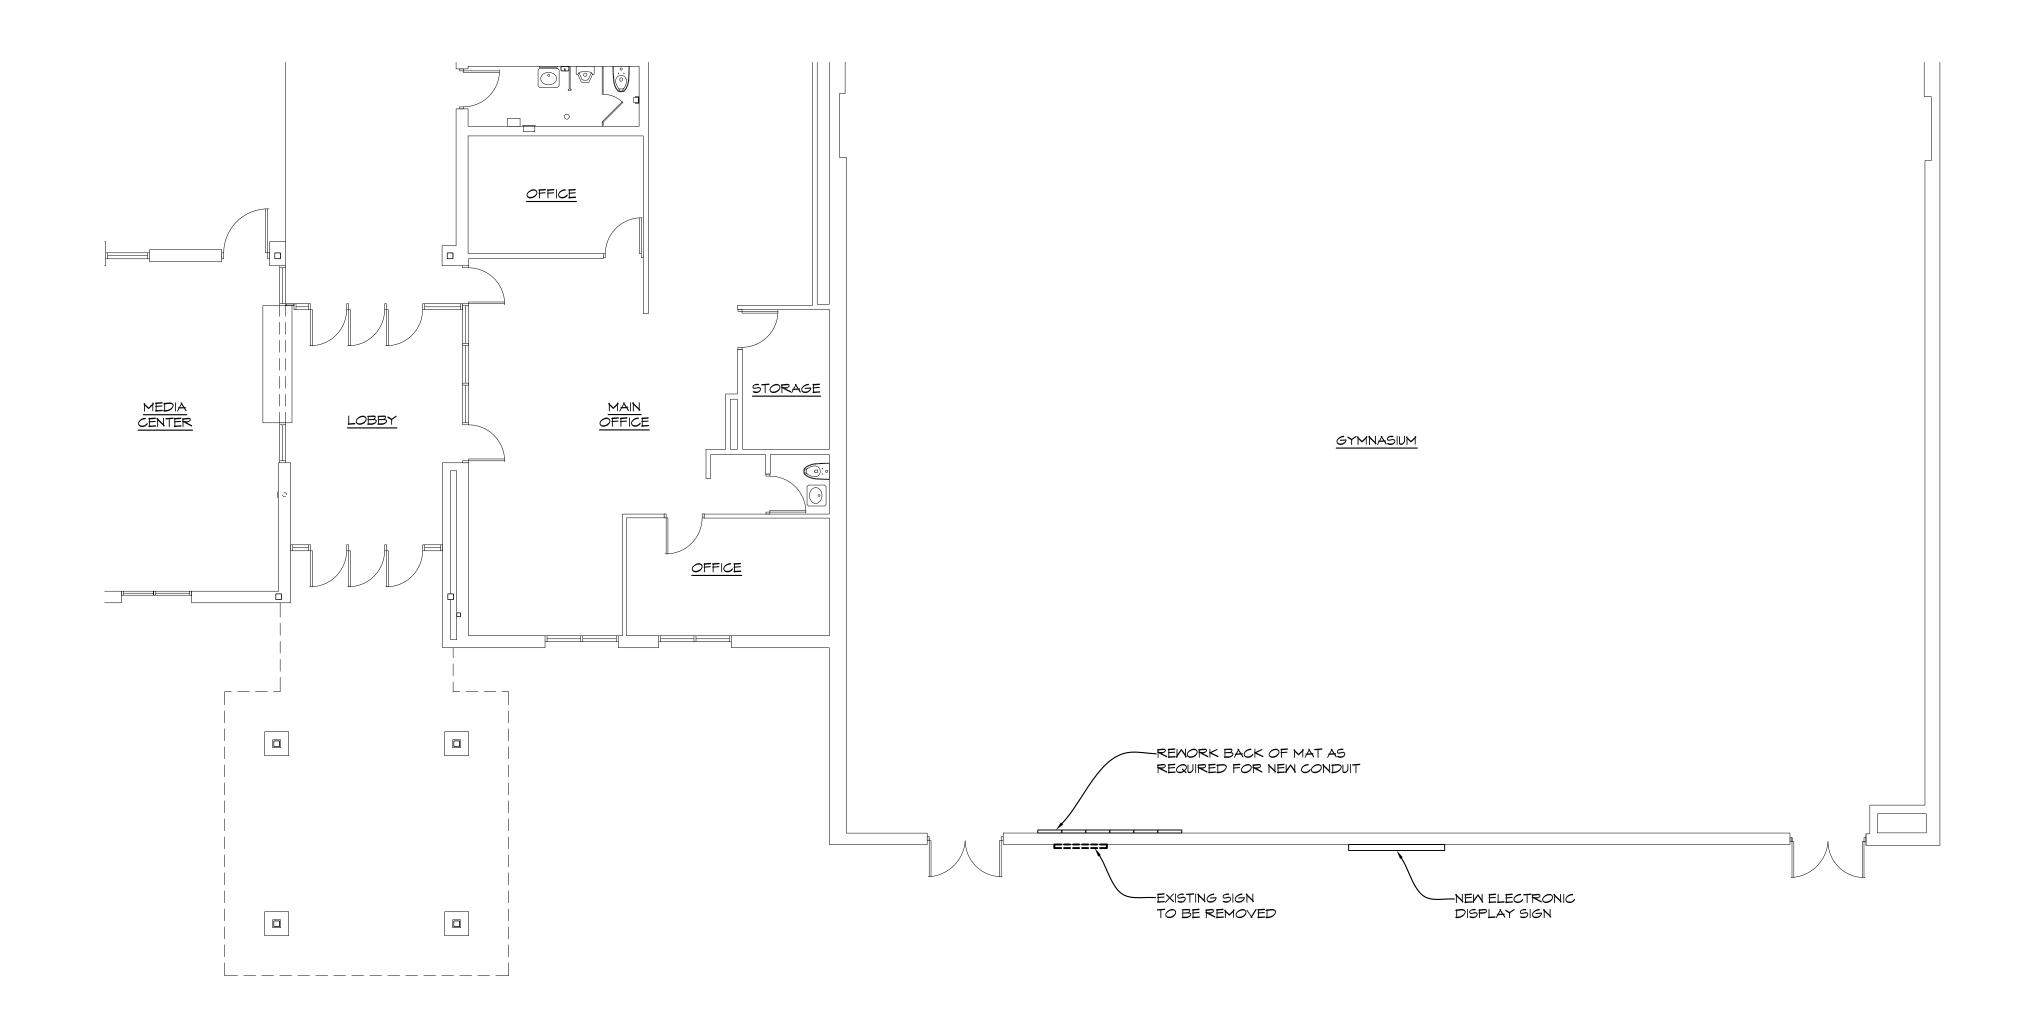



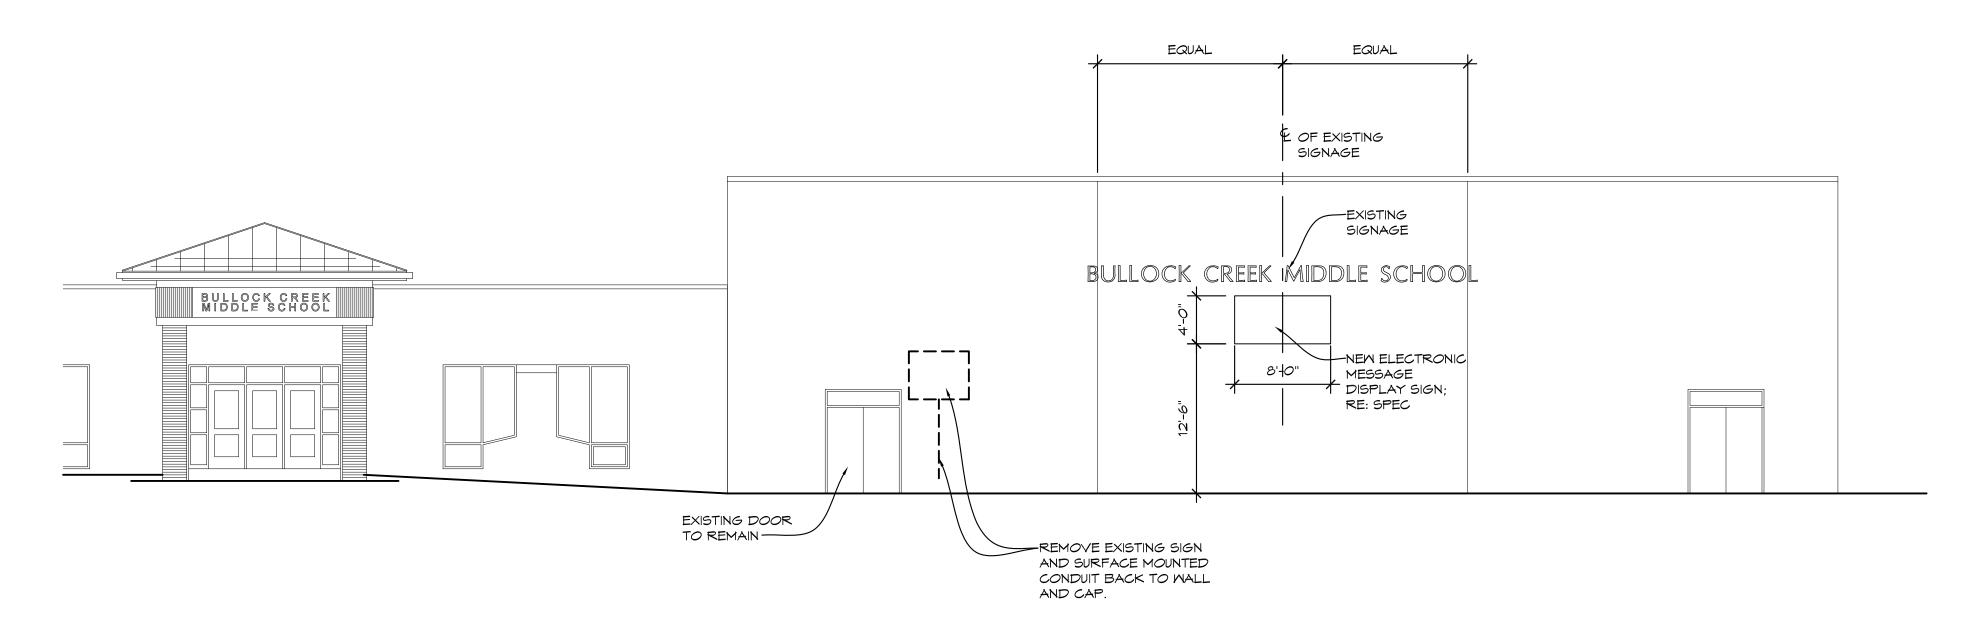



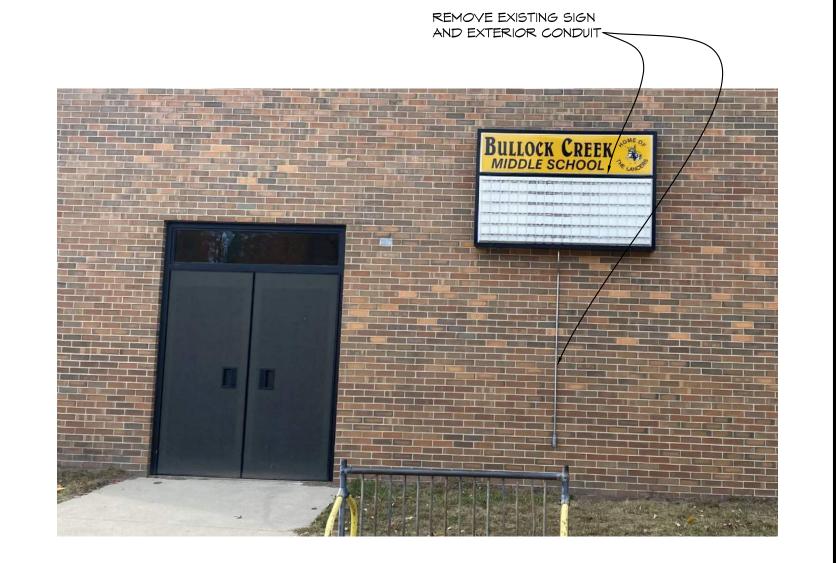

EXISTING SIGN ELEVATION


DEMOLITION GENERAL NOTES


FIELD VERIFY ALL EXISTING CONDITIONS AND DIMENSIONS. NOTIFY DESIGN PROFESSIONAL OF ANY DISCREPANCIES PRIOR TO BEGINNING WORK. COORDINATE DEMOLITION

MORK WITH NEW MORK SHOWN ON DRAWINGS.

EXISTING FINISHES.

- . CONTRACTOR SHALL BE RESPONSIBLE FOR PROVIDING ALL NECESSARY TEMPORARY BRACING AND/OR SHORING REQUIRED TO MAINTAIN THE INTEGRITY AND STRUCTURAL STABILITY OF THE BUILDING AND ITS ELEMENTS.
- ITEMS SCHEDULED FOR REMOVAL. 5. UTILITY INFORMATION WAS OBTAINED FROM AVAILABLE
- RECORDS, NO GUARANTEE IS MADE EITHER TO COMPLETENESS OR ACCURACY.
- 6. CONTACT "MISS DIG" AT 1-800-482-7171 PRIOR TO EXCAVATION OR DEMOLITION.
- SEE MECHANICAL AND ELECTRICAL DRAWINGS FOR ADDITIONAL DEMOLITION WORK.
- NOTATIONS ARE MADE IN VARIOUS PLACES ON THE DRAWINGS TO CALL ATTENTION TO DEMOLITION WHICH IS REQUIRED, HOWEVER, THESE DRAWINGS ARE NOT INTENDED TO SHOW EACH AND EVERY ITEM TO BE REMOVED. THE CONTRACTOR AND THE SUBCONTRACTORS FOR THE VARIOUS TRADES SHALL REMOVE THE MATERIALS RELATED TO THEIR RESPECTIVE TRADES AS REQUIRED TO PERMIT THE CONSTRUCTION OF THE NEW WORK AS SHOWN.

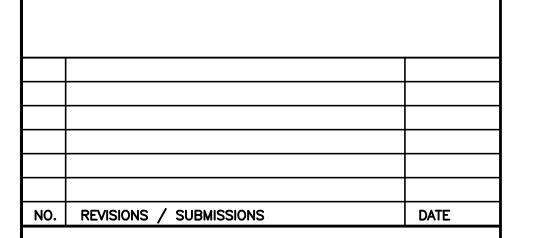

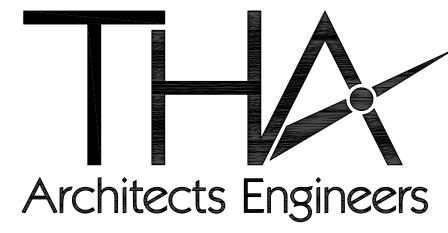

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> PROJECT 'B' BULLOCK CREEK MIDDLE SCHOOL IMPROVEMENTS

664 SOUTH BADOUR ROAD MIDLAND, MI

SIGNAGE PLAN AND ELEVATIONS

SEAL	DRAWN KRS/ EVA	PROJECT NO. 24-120
	CHECKED JESS	CAD FILE NO. B-A1 <i>0</i> 1
	REVIEWED MLB	DRAWING NO.
	DATE OCT 18, 2024	15-A101

-EXISTING CONCRETE MALKMAY TO REMAIN FLOOR PLAN 1/8" = 1'-0" ×01

MICHIGAN UNIFIED KEYING SYSTEM

KEY	DETAIL	CHARACTERISTICS
	EEDING	INEXPENSIVE AND VERY EFFECTIVE STABILIZES SOIL, THUS MINIMIZING EROSION PERMITS RUNOFF TO INFILTRATE SOIL, REDUCING RUNOFF VOLUME SHOULD INCLUDE PREPARED TOPSOIL BED
54 _	LT FENCE	USES GEOTEXTILE FABRIC AND POSTS OR POLES. EASY TO CONSTRUCT AND LOCATE AS NECESSARY.


CONSTRUCTION SEQUENCE

1. EXCAVATION AND STOCKPILING OF SOIL.

2. IMPLEMENTATION OF TEMPORARY EROSION CONTROL MEASURES;

SELECTIVE GRADING, DIVERSIONS AS REQUIRED IN FIELD, PROTECTION OF STORM SEWER FACILITIES.

3. PERIODIC MAINTENANCE OF AFFECTED EROSION CONTROL MEASURES. 4. PERMANENT MEASURES; FINAL GRADING, SEEDING AND MULCHING.

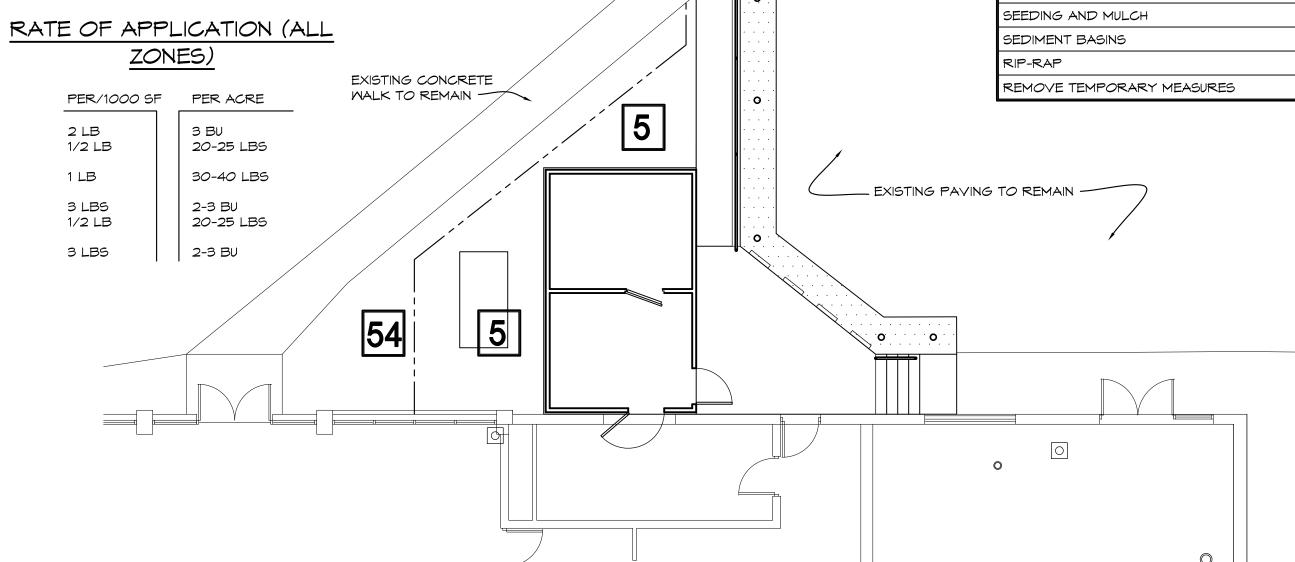

-LINE OF EXISTING ASPHALT PARKING

EXISTING PAVING

11'-3 1/2"

JOINT BETWEEN EDGE OF COOLER

AND CONCRETE

MEET AND MATCH

EXISTING -

CONSTRUCTION

12'-8 1/2"

JOINT---

SOIL EROSION PLAN 1/8" = 1'-0" XO1

- CONTROL PLAN AND OBTAIN A SOIL EROSION AND SEDIMENTATION CONTROL PERMIT PRIOR TO ANY EARTH CHANGES.
- THAT PREVENTATIVE EROSION CONTROL MEASURES ARE IN PLACE PRIOR TO EXCAVATION AND TEMPORARY STABILIZATION MEASURES ARE IN PLACE IMMEDIATELY FOLLOWING BACKFILLING AND / OR GRADING OPERATIONS.
- 3. BORROW AND FILL DISPOSAL AREAS WILL BE SELECTED AND APPROVED
- 4. SPECIAL PRECAUTIONS WILL BE TAKEN IN THE USE OF CONSTRUCTION EQUIPMENT TO PREVENT SITUATIONS THAT PROMOTE EROSION.
- MEASURES ARE NOT DISTURBED.
- SEDIMENT CONTROL COMPLIANCE. DEFICIENCIES WILL BE CORRECTED BY THE DEVELOPER WITHIN 24 HOURS.
- 7. TEMPORARY EROSION CONTROL MEASURES SHALL BE COMPLETELY REMOVED BY THE DEVELOPER UPON EASTABLISHMENT OF PERMANENT CONTROL MEASURES.
- 8. ALL TEMPORARY SOIL EROSION CONTROL MEASURES MUST BE REMOVED FROM ROAD RIGHT-OF-WAY AREAS PRIOR TO ACCEPTANCE OF STREETS FOR ROUTINE MAINTENANCE.
- 9. VEGETATION MUST BE ACCEPTABLY ESTABLISHED PRIOR TO FINAL RELEASE OF THE CONSTRUCTION GUARANTEE BY THE ROAD COMMISSION.

Architects Engineers 817 E. Kearsley St. | Flint, MI 48503 Ph: 810-767-5600 | THA-Flint.com PROJECT 'B' BULLOCK CREEK

NO. | REVISIONS / SUBMISSIONS

MIDDLE SCHOOL IMPROVEMENTS 664 SOUTH BADOUR ROAD


MIDLAND, MI

SEAL

Plot date: 10/22/2024 11:33 AM

COOLER/ REFRIGERATOR DEMOLITION PLAN, FLOOR PLAN

DRAWN EVA	PROJECT NO. 24-120
CHECKED JESS	CAD FILE NO. B-A102
REVIEWED MLB	DRAWING NO.
DATE OCT 18, 2024	18-A102
SCALE 1/8" = 1'-0"	SHEET NO

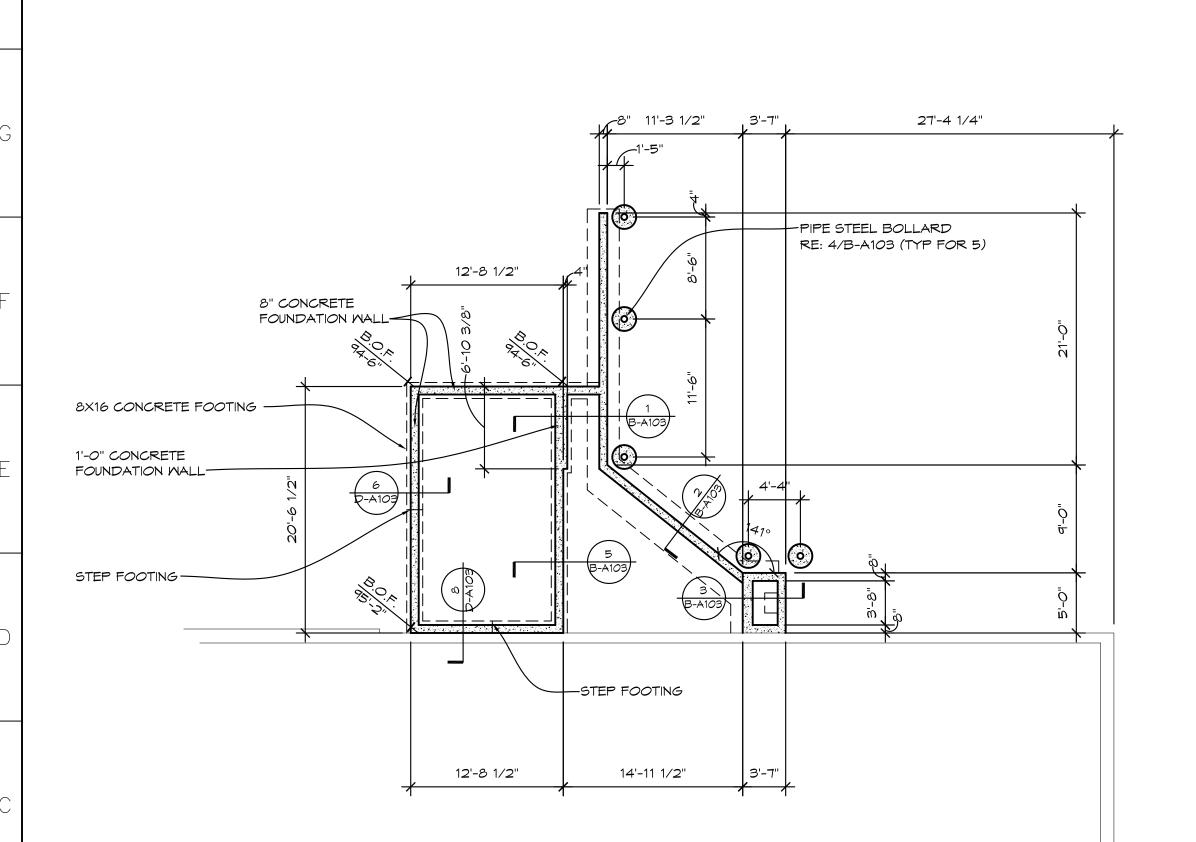

6'-0"

7'-10"

—LINE OF EXISTING

ASPHALT PARKING

-EXISTING DOOR

TO REMAIN



EXISTING CONCRETE

1/8" = 1'-0" XO1

MALKMAY TO REMAIN—

-EXISTING DOOR

-EXISTING STOOP

FLOOR PLAN

TO REMAIN

TO REMAIN

CONSTRUCTION SCHEDULE 2024 / 2025	SEPT	OCT	NOV	DEC	NAL	FEB	MAR	APR	MAY	JUNE	JULY	AUG	SEPT	OCT
TEMPORARY SESC MEASURES														
STRIP AND STOCKPILE SOIL														
ROUGH GRADING														
UNDERGROUND UTILITIES														
ROAD INSTALLATION														
BUILDING CONSTRUCTION (REMODEL)														
PERMANENT SESC MEASURES														
FINAL GRADE														
LANDSCAPING														

MAINTENANCE SCHEDULE 2024 / 2025	SEPT	OCT	NOV	DEC	ZĄ	FEB	MAR	APR	MAY	JUNE	JULY	AUG	SEPT	0
STREET SMEEPING														
SILT FENCING														
MAINTAIN BUFFER STRIPS														
INLET STRUCTURES														
SEEDING AND MULCH														
SEDIMENT BASINS														
RIP-RAP														
REMOVE TEMPORARY MEASURES														







2. CONSTRUCTION OPERATION SHALL BE SCHEDULED AND PERFORMED SO


AT TIME OF PLAN REVIEW.


5. CLEANUP WILL BE DONE IN A MANNER TO INSURE THAT EROSION CONTROL

6. THE PROJECT WILL CONTINUALLY BE INSPECTED FOR SOIL EROSION AND

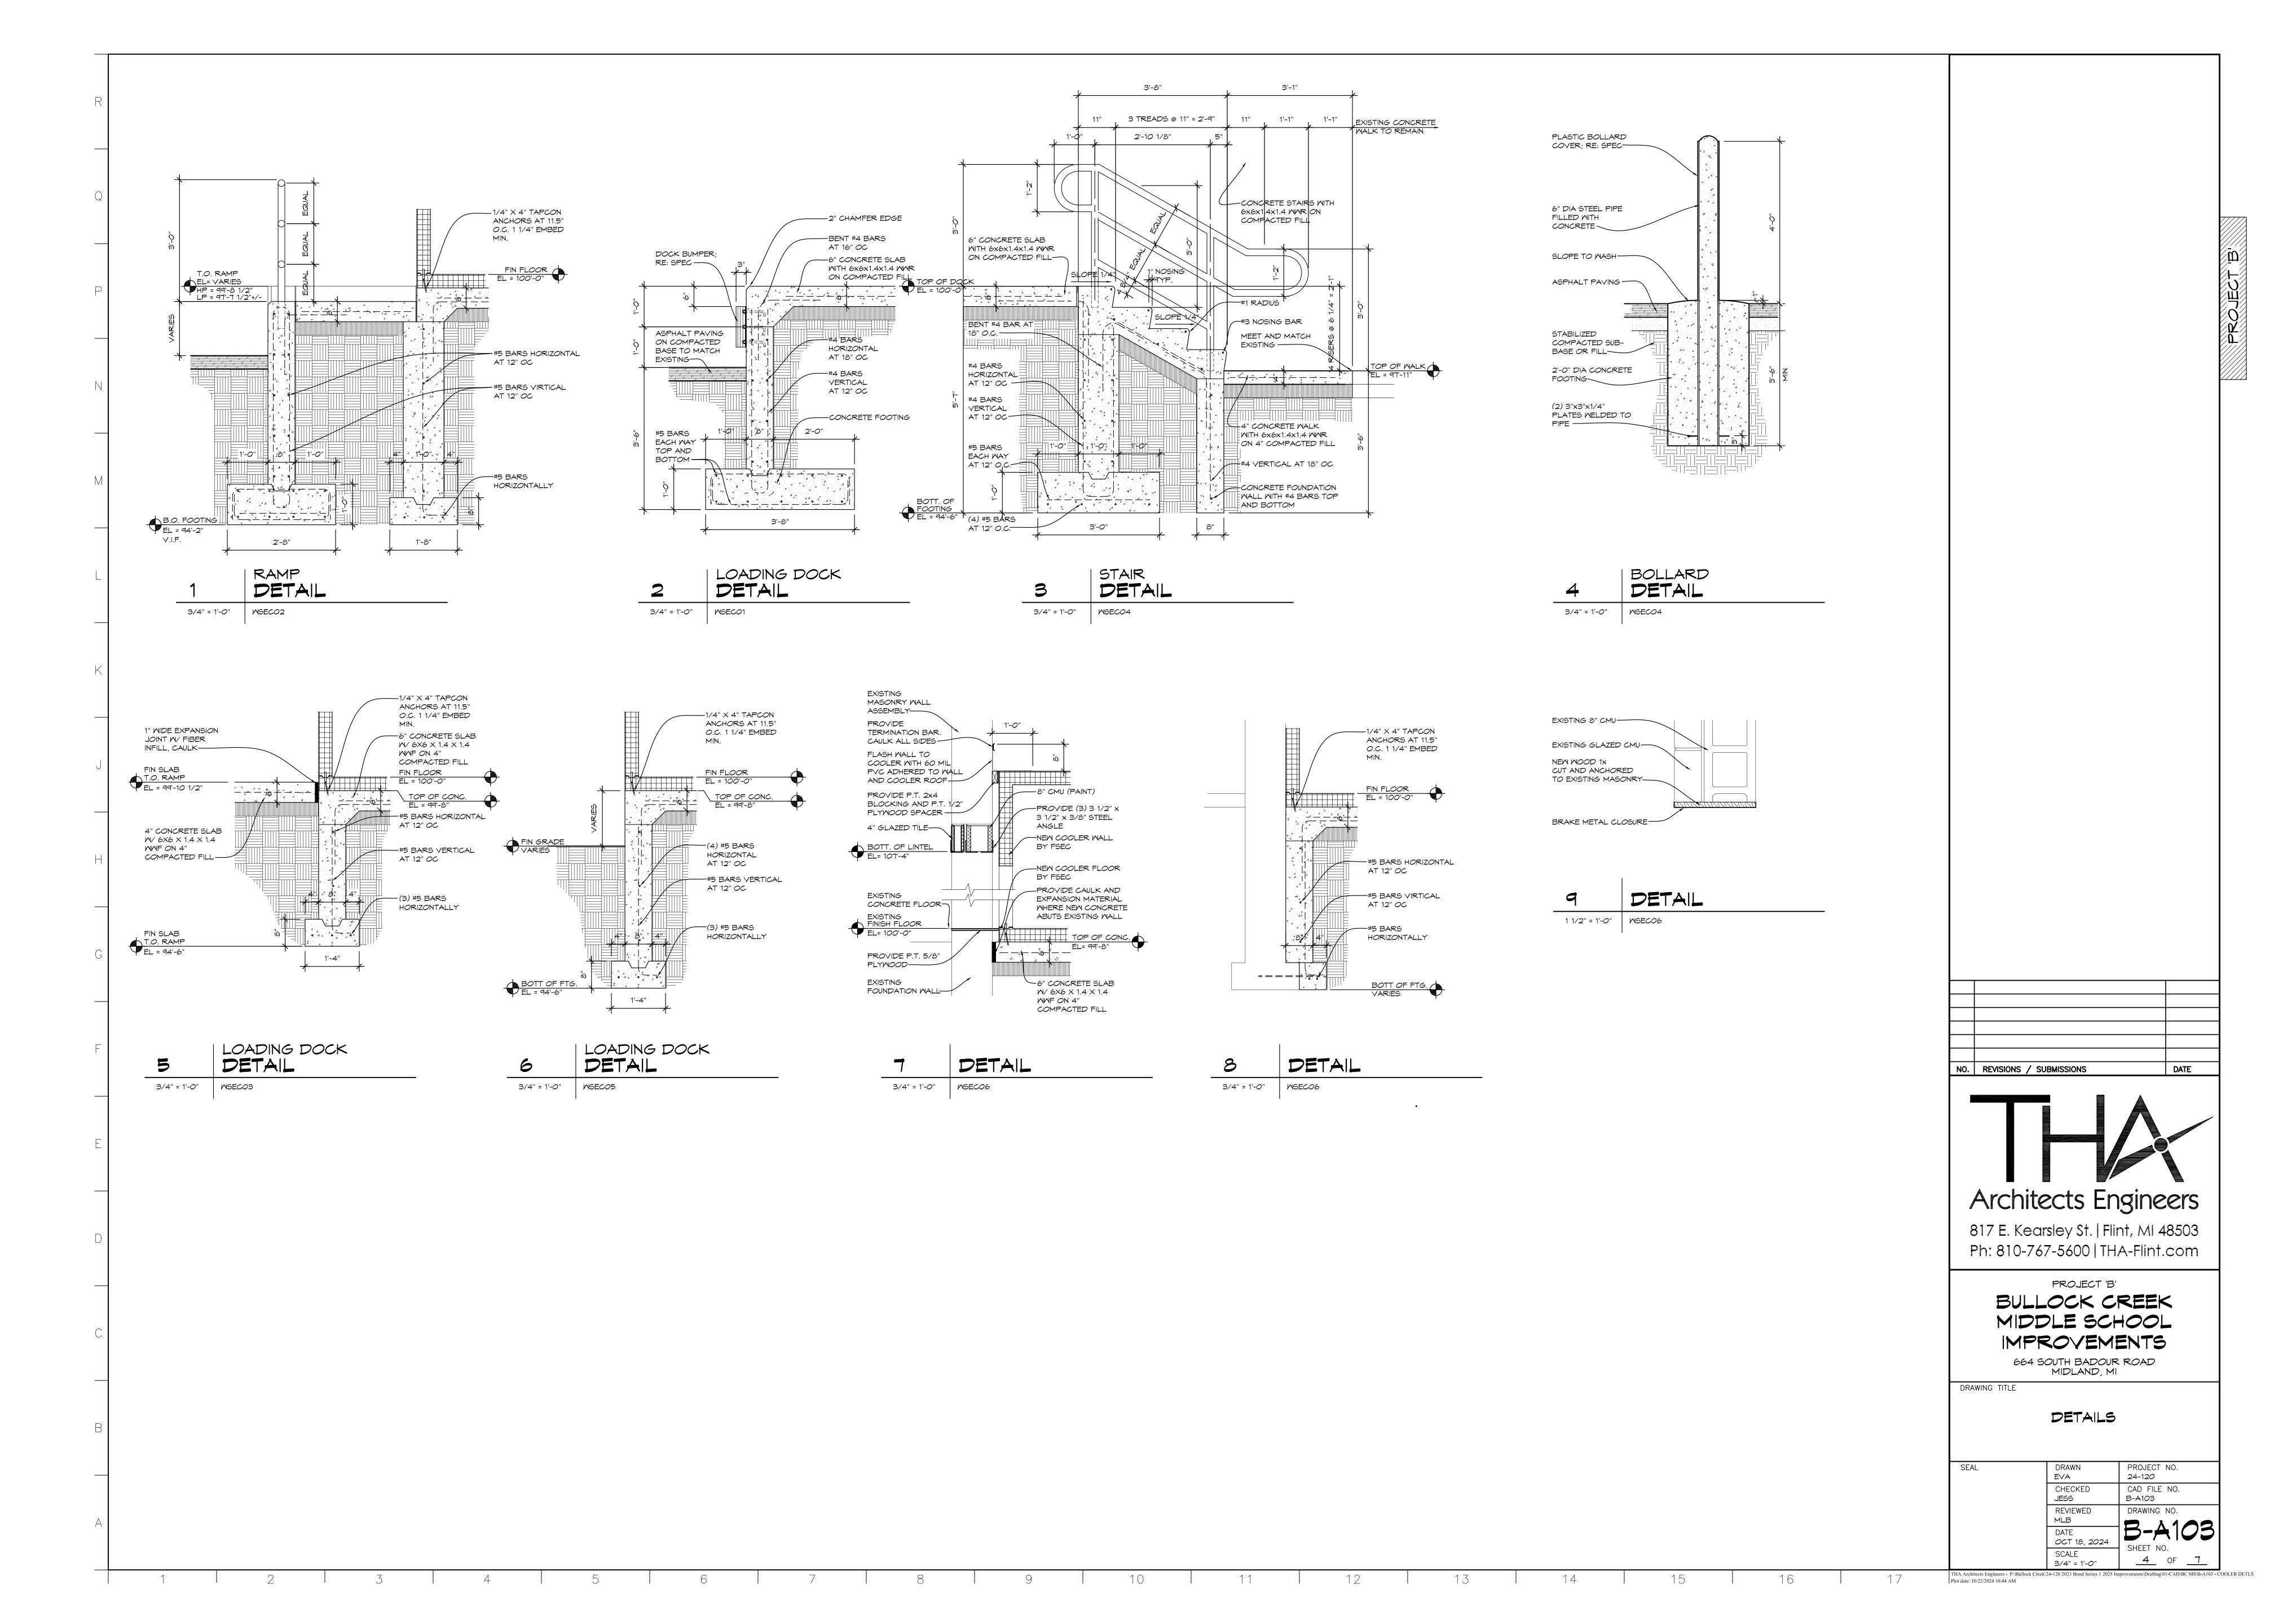

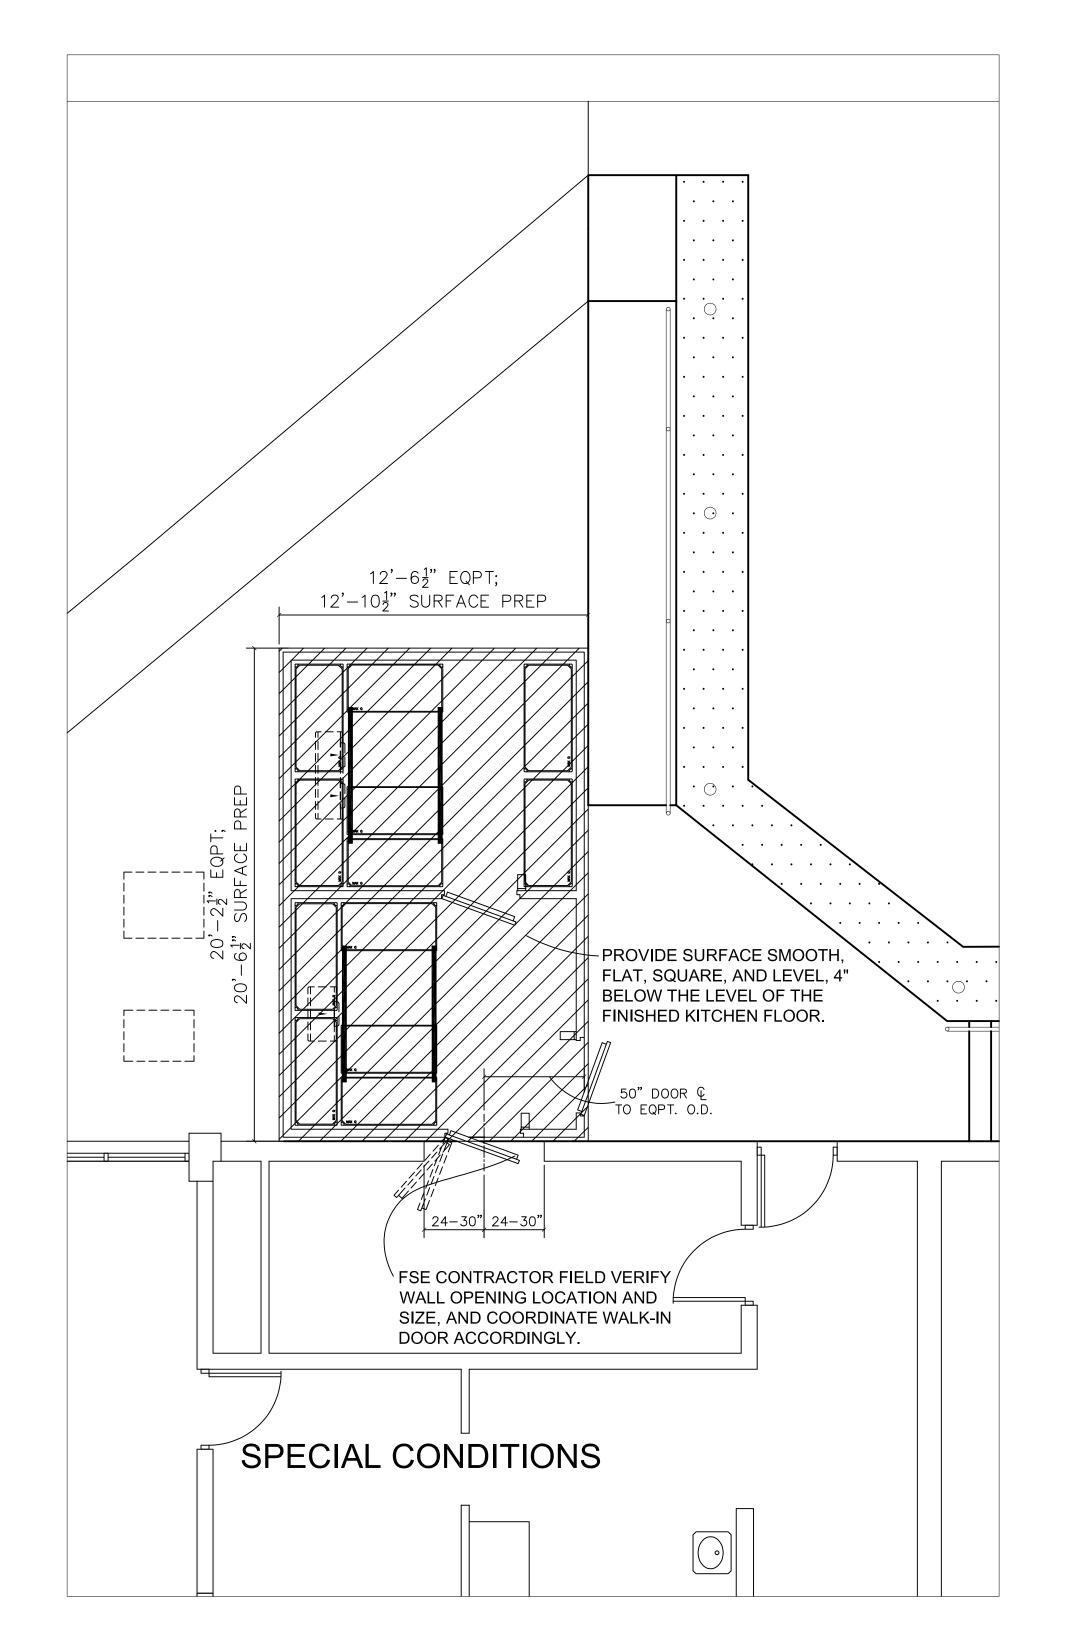

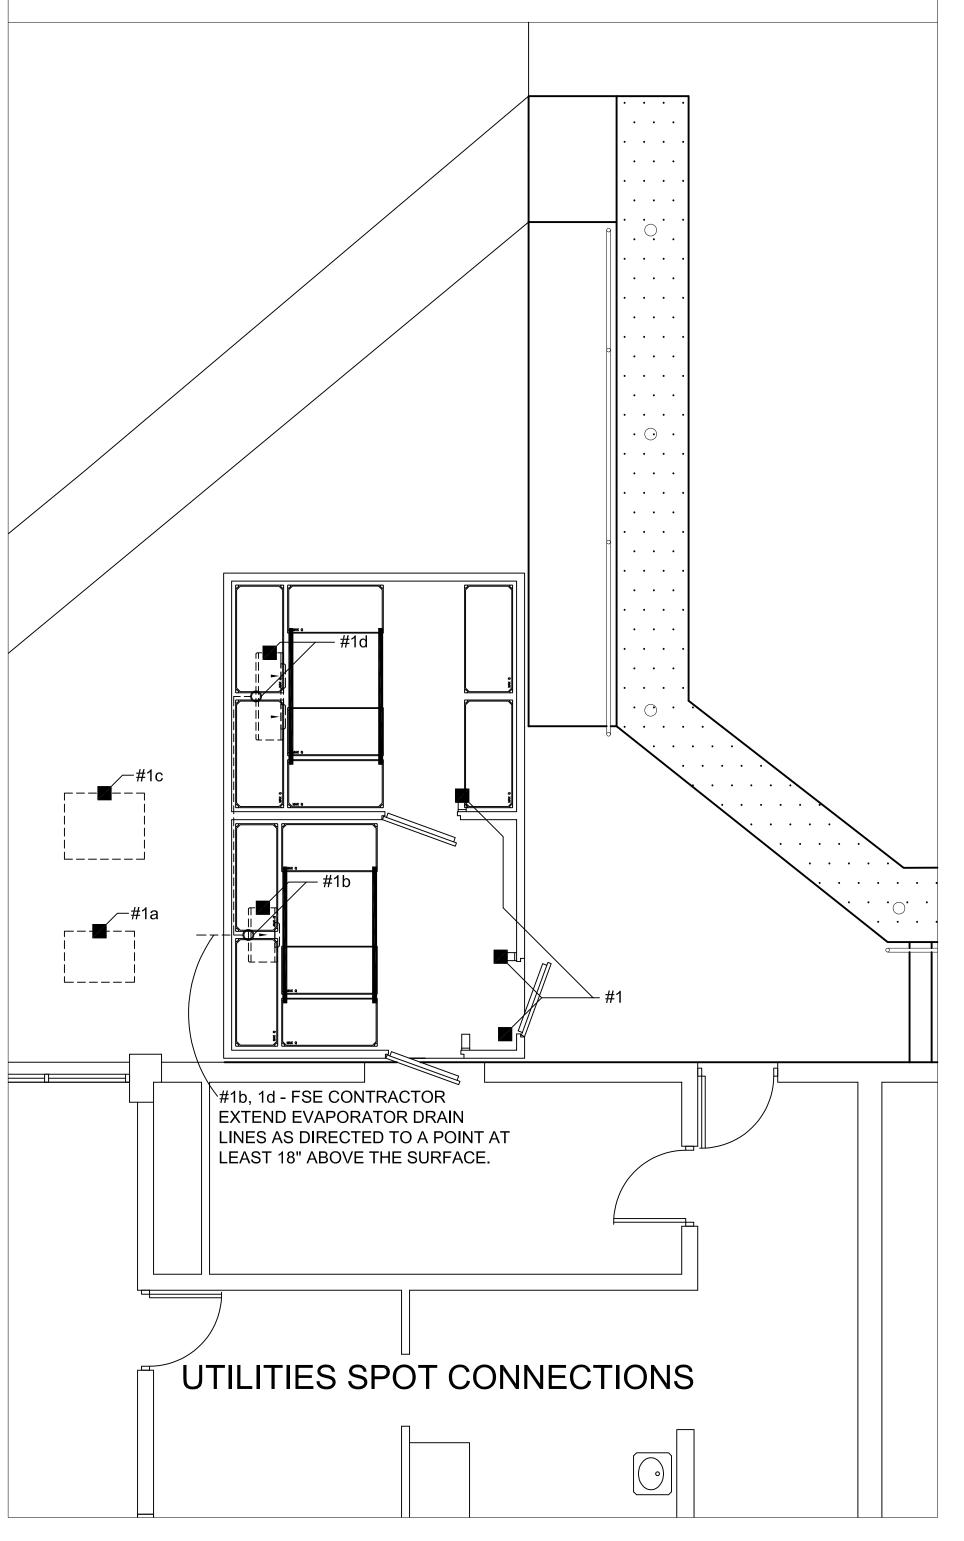

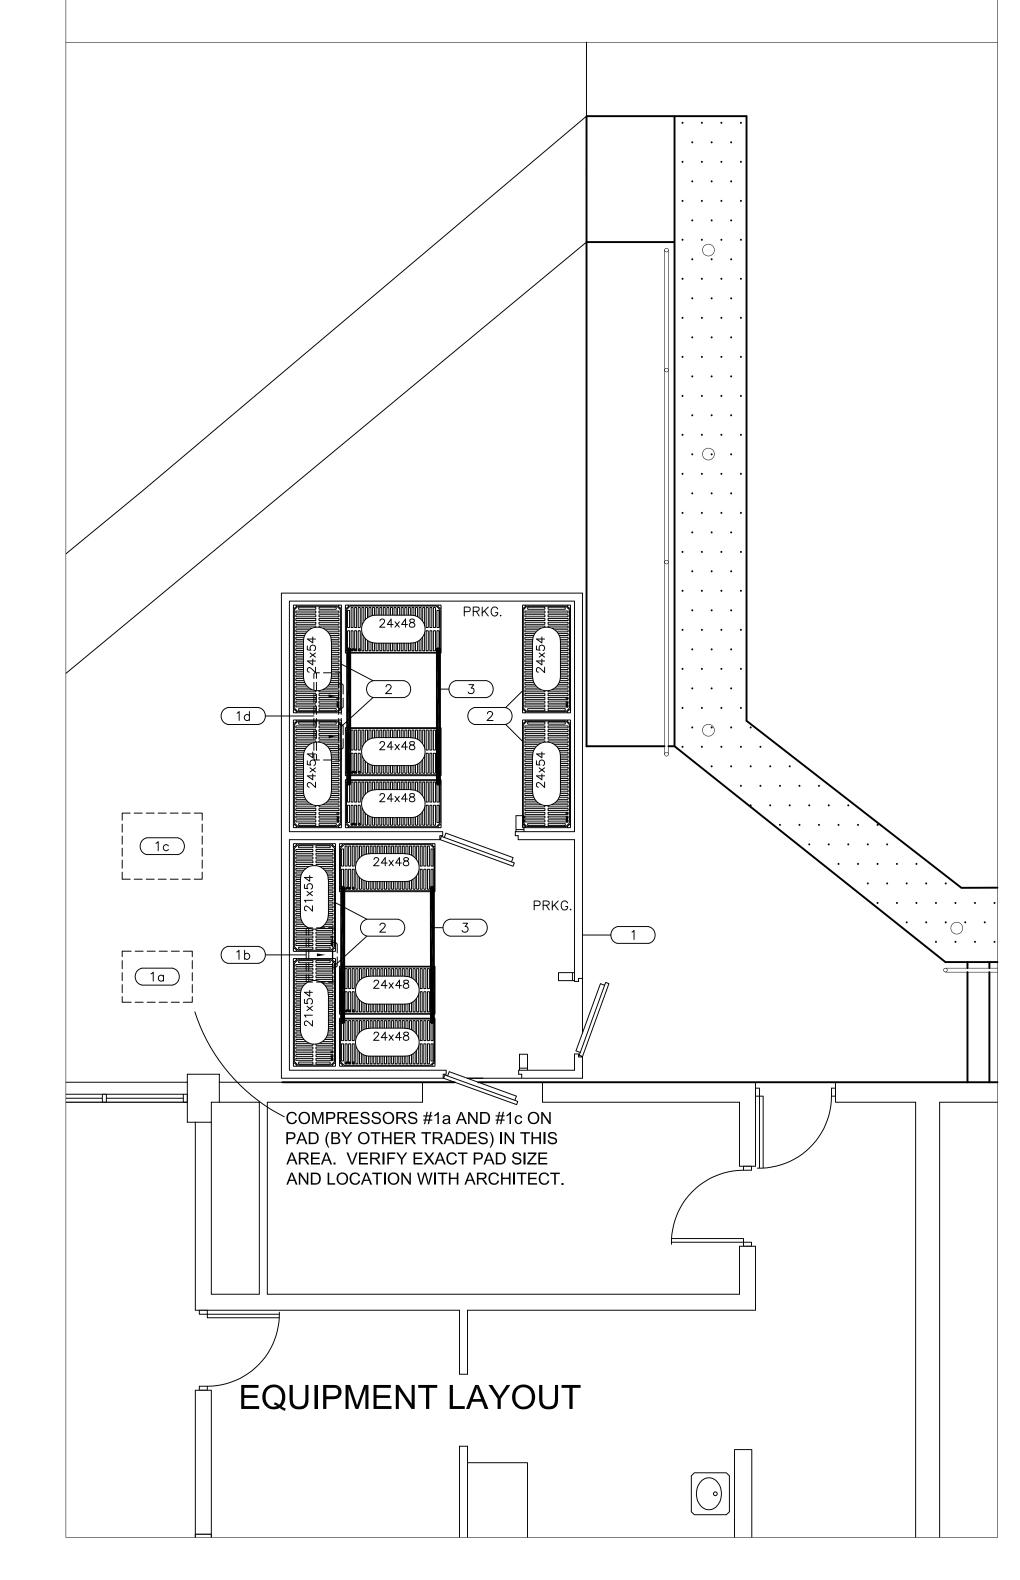

LEGEND

EC ELECTRICAL CONNECTION DUPLEX RECEPTACLE (120/1ø) SR SINGLE RECEPTACLE (208/1¢)

DCR DUPLEX CONVENIENCE RECEPTACLE (120/1¢)

SCR SINGLE CONVENIENCE RECEPTACLE (208/1¢)

HP HORSEPOWER

KW KILOWATTS FULL LOAD AMPS

FD FLOOR DRAIN FFD FUNNEL FLOOR DRAIN FLOOR SINK INDIRECT WASTE

DFA DOWN FROM ABOVE ABOVE FINISHED FLOOR FSEC FOOD SERVICE EQUIPMENT CONTRACTOR

545-A North Saginaw Street

Lapeer, MI 48446

Fax 810-667-3101

810-667-3100

1- LOCATIONS SHOWN ARE APPROXIMATE CONNECTION POINTS ON EQUIPMENT. FSEC TO PROVIDE FULLY DIMENSIONED ROUGH-IN PLAN.

2- UTILITY REQUIREMENTS, DIMENSIONS, INTERCONNECTIONS, AND SO ON ARE BASED ON THE FIRST-NAMED MANUFACTURER IN THE SPECIFICATIONS. THE FSEC IS RESPONSIBLE FOR ADVISING ANY DEVIATIONS THAT MAY RESULT FROM THE USE OF MANUFACTURERS OTHER THAN THE FIRST-NAMED, AND FOR ANY ADDITIONAL COSTS BY ANY TRADES INCURRED AS A RESULT OF USING MANUFACTURERS OTHER THAN THE FIRST-NAMED.

3- UTILITY REQUIREMENTS DO NOT NECESSARILY REFLECT EXISTING UTILITIES IN THE AREA. WHERE PRACTICAL, EXISTING UTILITIES SHALL BE USED IN LIEU OF PROVIDING NEW SERVICES.

4- FSEC TO PROVIDE AND INSTALL HEAT TAPE AND INSULATION FOR CONDENSATE LINES IN WALK-IN FREEZERS. FINAL CONNECTION BY ELECTRICAL CONTRACTOR. 5- ELECTRICAL CONTRACTOR TO PROVIDE EXTERIOR INTERWIRING IN WALK-IN REFRIGERATORS AND FREEZERS BETWEEN CEILING-MOUNTED LIGHT FIXTURES, DOOR SWITCH, AND POWER SOURCE.


6- ELECTRICAL CONTRACTOR TO INTERWIRE TIME CLOCK SERVING FREEZER CONDENSING UNITS.

7— FSEC SHALL VERIFY PROPER SIZING OF COOLING SYSTEMS FOR REMOTE REFRIGERATORS AND FREEZERS BASED ON LENGTH OF REFRIGERATION LINES HEAT LOAD, AMBIENT TEMPERATURES, AND SO ON.

8- FSEC TO FURNISH AND INSTALL REFRIGERATION LINES FROM REMOTE COMPRESSORS TO FAN COILS IN REFRIGERATOR AND FREEZER COMPARTMENTS. 9- GENERAL CONTRACTOR TO PROVIDE FINISHED OPENINGS, SLEEVES, OR CONDUIT AS REQUIRED IN WALLS, FLOORS AND CEILINGS FOR PASSAGE OF REFRIGERATION

10- FSEC WILL NOT BE RESPONSIBLE FOR FURNISHING ELECTRICAL COMPONENTS SUCH AS LINE OR DISCONNECT SWITCHES, SAFETY CUT-OUTS, CONTROL PANELS, FUSE BOXES, FITTINGS, WIRING OR PLUMBING COMPONENTS AND FIXTURES SUCH AS TEES, MIXING VALVES, ELBOWS, SHUT-OFF VALVES, COUPLINGS, AND FITTINGS OTHER THAN THOSE FURNISHED AS STANDARD WITH HIS EQUIPMENT OR AS OTHERWISE

EQ	UIPMENT SCHEDULE											
Item No	Qty Equipment Category	Equipment Remarks	Indir Drain Size (in)	Plumbing Remarks	Volts	Phase	KW	HP Amps	Electrical AFF (in)	Direct	Plug	Electrical Remarks
1	1 WALK-IN REFRIGERATOR/FREEZER				(3)120	1		15.0	DFA	Х		DOORS, LIGHTS, HEATERS, ETC.
1a	1 REFRIGERATOR COMPRESSOR	VERIFY LOCATION			208-230	3		1-1/2 5.9	DFA	Х		VERIFY LOCATION
1b	1 REFRIGERATOR EVAPORATOR COIL		1.0	TO AIR GAP WASTE	120	1		1.6	DFA	Х		FAN
1c	1 FREEZER COMPRESSOR	VERIFY LOCATION			208-230	3		2-1/2 12.3	DFA	Х		VERIFY LOCATION
1d	1 FREEZER EVAPORATOR COIL		1.0	TO AIR GAP WASTE	208-230	1		9.8	DFA	Х		FAN, DEFROST
2	6 MOBILE SHELVING UNIT											
3	2 HIGH-DENSITY SHELVING											

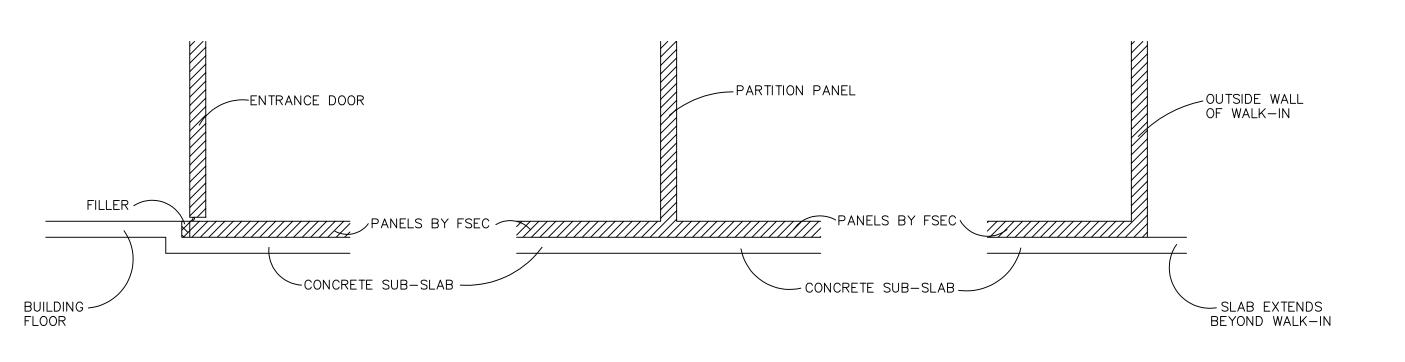

WALK-IN FLOOR DETAIL (NO SCALE)



10-18-24 NO. | REVISIONS / SUBMISSIONS DATE



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PROJECT 'B' IMPROVEMENTS 664 SOUTH BADOUR ROAD MIDLAND, MI

DRAWING TITLE Food Service Equipment

> Floor Plan, Schedule, Utilities, and Special Conditions

PROJECT NO. JHP 24-120 CAD FILE NO. CHECKED C.i.i. REVIEWED DRAWING NO. C.i.i.


10-18-24 SHEET NO. SCALE <u>5</u> of <u>7</u>

DATE

NOT FOR CONSTRUCTION

THA Architects Engineers - C:\Users\Jim\Documents\000 Work Documents\AutoCAD\2421 Bullock Creek Middle School\2421 Bullock Creek MS current

SEAL

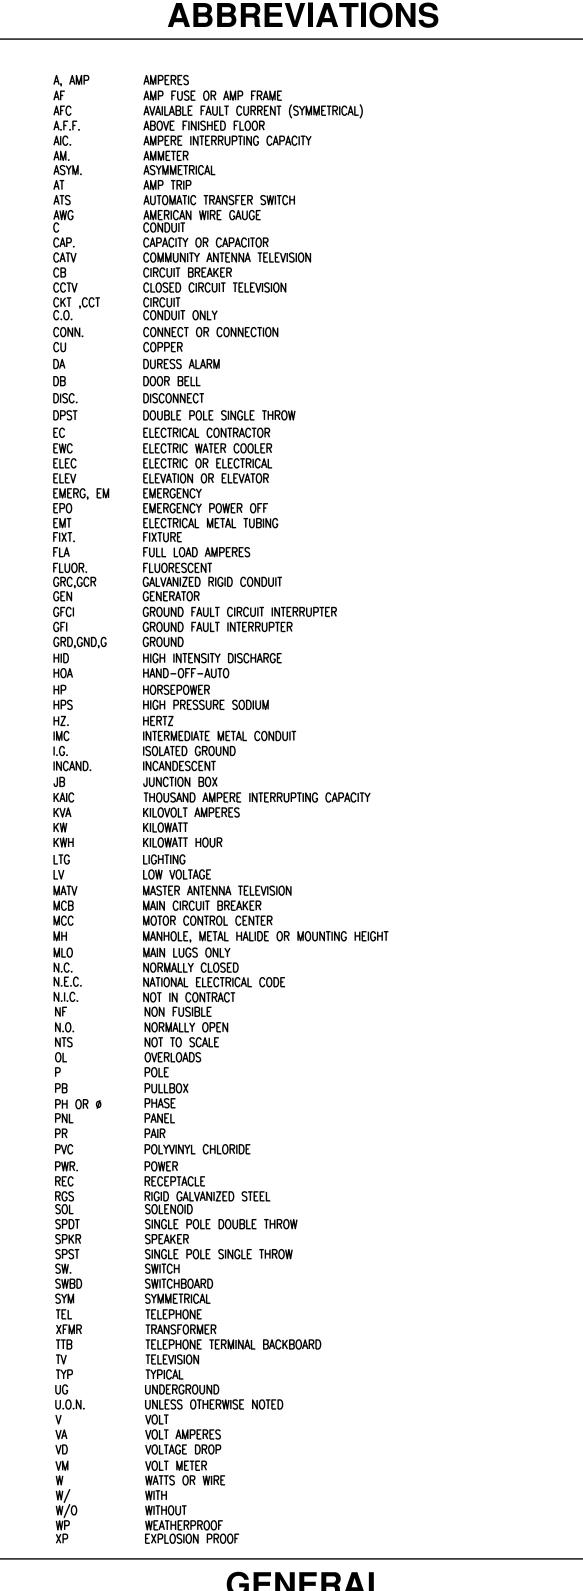

GENERAL

MOUNTING HEIGHTS TO BE AS INDICATED UON. MOUNTING HEIGHTS ARE TO CENTER OF DEVICE FROM FINISHED FLOOR OR GRADE UON. SEE SPECIFICATION 16010 FOR

 \langle # \rangle key note reference symbol. Denotes "see key note no. 2" → → TV FOOT ON DEVICE INDICATES WALL MOUNTED

DEMOLITION AND REMODEL

THE COLUMN EXISTING ELECTRICAL ITEM TO BE REMOVED

RII RECORDED EXISTING ELECTRICAL ITEM TO BE REMOVED AND RELOCATED

R R C EXISTING ELECTRICAL ITEM RELOCATED. NEW LOCATION


EMAIN EXISTING ELECTRICAL ITEM TO REMAIN

1) EXISTING ELECTRICAL ITEM TO BE REMOVED AND PROVIDED WITH A BLANK B II COVERPLATE


EXISTING ELECTRICAL OR SYSTEMS CIRCUIT TO REMAIN

EXISTING ELECTRICAL CIRCUIT TO BE REMOVED SHOWN ONLY WHERE CLARIFICATION BETWEEN EXISTING TO REMAIN AND REMOVED ITEMS IS REQUIRED

CIRCUIT DESIGNATIONS

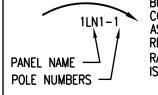

BRANCH CIRCUIT HOMERUN. PROVIDE PHASE, NEUTRAL AND GROUND CONDUCTORS FOR EACH INDICATED CIRCUIT OR MULTI WIRE BRANCH AS REQUIRED. PROVIDE SWITCH LEGS FOR SWITCH CIRCUITING AS REQUIRED. PROVIDE EQUIPMENT GROUND WIRE IN ALL BRANCH CIRCUIT RACEWAYS/CIRCUITS. PROVIDE SEPARATE ISOLATED GROUND WIRE TO ALL ISOLATED GROUND DEVICES.

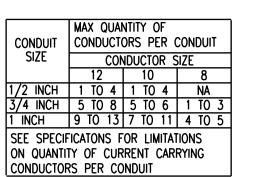

CONDUIT RISER UP CONDUIT RISER DOWN > INDICATES CIRCUIT CONTINUATION

>> STUB INTO ACCESSIBLE CORRIDOR CEILING SPACE UNLESS OTHERWISE NOTED CONDUIT SEAL FITTING FOR HAZARDOUS AREAS

⊢ CONDUIT SLEEVE >> CAP END OF CONDUIT CABLE OR CORD CONNECTED

LIGHTING

NOTE A: UPPER CASE ALPHANUMERIC SUBSCRIPT DENOTES FIXTURE TYPE. SEE NOTE B: LOWER CASE LETTER SUBSCRIPT PROVIDED ADJACENT TO SWITCHING DEVICE AND ASSOCIATED LIGHT FIXTURE(S) WHERE REQUIRED FOR CLARIFICATION.

CEILING LIGHT OUTLET WITH FIXTURE CONNECTED TO NORMAL SOURCE

DIRECTIONAL AIMED FIXTURE AIM IN DIRECTION OF ARROW

WALL BRACKET LIGHT OUTLET WITH FIXTURE CONNECTED TO NORMAL SOURCE

LIGHT OUTLET WITH FIXTURE CONNECTED TO NORMAL SOURCE

WALL BRACKET LIGHT OUTLET WITH FIXTURE CONNECTED TO NORMAL SOURCE UNDER CABINET/COUNTER LIGHT OUTLET OR STRIP LIGHT OUTLET WITH FIXTURE CONNECTED TO NORMAL SOURCE

LINEAR PENDANT/SUSPENDED LIGHT FIXTURE CONNECTED TO NORMAL SOURCE EXIT LIGHT OUTLET WITH FIXTURE — SHADING INDICATES LOCATION OF FACE(S).
ARROWS INDICATE DIRECTIONAL ARROWS WHERE REQUIRED. WALL MOUNTED SIGNS

AT +90" CENTERED ABOVE DOOR WHERE APPLICABLE EMERGENCY LIGHT FIXTURE WITH INTEGRAL BATTERY SOURCE AND ADJUSTABLE

TRACK LIGHT OUTLET WITH FIXTURE. TYPE INDICATED, QUANTITY AND LENGTH AS SHOWN OR SCHEDULED

PENDANT LIGHT FIXTURE CONNECTED TO NORMAL SOURCE

LIGHTING STANDARD POLE FIXTURE, PROVIDE QUANTITY OF HEADS AND ORIENTATION AS INDICATED

LIGHTING STANDARD WITH POST-TOP FIXTURE

BOLLARD FIXTURE

CEILING LIGHT OUTLET WITH FIXTURE CONNECTED TO EMERGENCY SOURCE (LIFE WALL BRACKET LIGHT OUTLET WITH FIXTURE CONNECTED TO EMERGENCY SOURCE

(LIFE SAFETY BRANCH) LIGHT OUTLET WITH FIXTURE CONNECTED TO EMERGENCY SOURCE (LIFE SAFETY WALL BRACKET LIGHT OUTLET WITH FIXTURE CONNECTED TO EMERGENCY SOURCE

STRIP LIGHT OUTLET WITH FIXTURE CONNECTED TO EMERGENCY SOURCE (LIFE

SAFETY BRANCH) PENDANT LIGHT FIXTURE CONNECTED TO EMERGENCY SOURCE

LINEAR PENDANT/SUSPENDED LIGHT FIXTURE CONNECTED TO EMERGENCY SOURCE (LIFE SAFETY BRANCH)

S SWITCH AT +48" U.O.N. THE FOLLOWING SUBSCRIPTS ARE USED TO INDICATE VARIOUS TYPES OF SWITCHES.

NO SUBSCRIPT - SINGLE POLE 2 — DOUBLE POLE 3 — THREE WAY

4 — FOUR WAY D — LIGHTING DIMMER P — PILOT LIGHT

L - LIGHTED HANDLE K — KEY OPERATED TE - MANUAL STARTER WITH THERMAL ELEMENT

XP — EXPLOSION PROOF M — MOTOR RATED

LOW VOLTAGE SWITCH

TIME CLOCK AT +48"

OCCUPANCY SENSOR WITH INTEGRAL SWITCH-WALL MOUNTED AT +48"

OCCUPANCY SENSOR - CEILING MOUNTED THE FOLLOWING SUBSCRIPTS ARE USED TO INDICATE THE VARIOUS TYPES OF OCCUPANCY SENSORS NO SUBSCRIPT - COMBINATION INFRARED/ULTRASONIC SENSOR I — INFRARED SENSOR

u — ultrasonic sensor

POWER AND DIAGRAMS

NOTE A: OUTLETS IN FINISHED OR SHELL SPACES SHALL BE MOUNTED AT +18" NOTE B: RECEPTACLES LOCATED AT COUNTERS SHALL BE LOCATED 18" AFF IN KNEE SPACE IF PROVIDED OR 4" ABOVE COUNTER OR BACK SPLASH AS APPLICABLE IF NO KNEE SPACE IS PROVIDED U.O.N. NOTE C: WHERE (AC) IS INDICATED NEXT TO RECPTACLES AT WORK COUNTER, RECEPTACLES SHALL BE LOCATED ABOVE COUNTER RATHER THAN IN KNEE SPACE.

NOTE D: RECEPTACLES IN MECHANICAL AND ELECTRICAL SPACES SHALL BE MOUNTED AT +48" U.O.N.

GF — GROUND FAULT CIRCUIT INTERRUPTER RECEPTACLE AT +42" IN TOILETS

THE FOLLOWING SUBSCRIPTS ARE USED TO INDICATE DIFFERENT TYPES OF

ST — SAFETY TYPE RECEPTACLE XP — EXPLOSION PROOF RECEPTACLE

IG — ISOLATED GROUND RECEPTACLE

WP — WEATHERPROOF SW — TOP HALF OF DUPLEX RECEPTACLE SWITCHED

CL — CLOCK RECEPTACLE AT +84" H —— HORIZONTAL MOUNTING

U — RECEPTACLE SERVED BY UPS

\$\Psi\$ 20A, 125V, 2 POLE, 3 WIRE GROUNDING DUPLEX RECEPTACLE, NEMA 5-20R

4 20A, 125V, 2 POLE, 3 WIRE GROUNDING SINGLE RECEPTACLE, NEMA 5-20R

20A, 125V, 2 POLE, 3 WIRE GROUNDING DOUBLE DUPLEX RECEPTACLE, NEMA 5-20R

PEDESTAL TYPE, FLOOR OR COUNTER MOUNTED RECEPTACLE RECEPTACLE TYPE AS INDICATED ABOVE

① CEILING MOUNTED RECEPTACLE, TYPE AS INDICATED ABOVE

FLUSH FLOOR BOX WITH RECEPTACLE, TYPE AS INDICATED ABOVE

COMBINATION POWER/COMMUNICATIONS FLOOR BOX, SEE COMMUNICATIONS PLAN FOR SYSTEMS DEVICE

PIGTAIL DENOTES CONNECTION TO LIGHT SWITCH, LIGHT FIXTURE OR FIXED EQUIPMENT

SPECIAL PURPOSE RECEPTACLE SUBSCRIPT DENOTES NEMA TYPE, REFER TO Y SPECIFICATIONS

JUNCTION BOX, 4 INCH SQUARE UNLESS OTHERWISE NOTED

PLUG-IN RECEPTACLE STRIP (LENGTH AS INDICATED)

(P) TELECOMMUNICATIONS/POWER POLE 208 VOLT PANELBOARD AT +72" TO TOP

480 VOLT PANELBOARD AT +72" TO TOP

SAFETY SWITCH AT +54". CHARACTERISTICS AS INDICATED BY FRAME/POLES.

FUSED SAFETY SWITCH AT +54". CHARACTERISTICS AS INDICATED BY FRAME/FUSESIZE/POLES.

MAGNETIC MOTOR STARTER AT +54". CHARACTERISTICS AS INDICATED BY FRAME

SIZE/POLES/NEMA SIZE. COMBINATION MAGNETIC MOTOR STARTER WITH DISCONNECT AT +54". CHARACTERISTICS AS INDICATED BY FRAME/FUSE/POLES/NEMA SIZE

AFD ADJUSTABLE FREQUENCY DRIVE

MAGNETIC CONTACTOR AT +54". AMPS/POLES/CONTACT VOLTS/ COIL VOLTS AS INDICATED.

SEPARATELY MOUNTED, ENCLOSED MOLDED CASE CIRCUIT BREAKER AT +48". FLUSH MOUNTED IN FINISHED AREAS. AMP/POLES AS INDICATED.

— CIRCUIT BREAKER. AMP/POLES AS INDICATED

- FUSIBLE SWITCH. AMP/POLES/FUSE SIZE AS INDICATED

AUTOMATIC TRANSFER SWITCH +72" TO TOP OR FLOOR MOUNTED.

—— DISCONNECT STABS FOR DRAWOUT TYPE EQUIPMENT

XXX TRANSFORMER - GROUND CONNECTION

/ / MOTOR CONNECTION, HP AS INDICATED

G GENERATOR

START-STOP PUSHBUTTON STATION AT +48"

(GROUNDING SYSTEM TEST WELL

GROUNDING CONNECTION

TT GROUND BUS ON STANDOFFS

CONTROL PANEL: INTEGRAL PART OF, OR FURNISHED BY OTHER THAN DIVISION 16 EQUIPMENT OR TERMINAL CABINET AT +72" TO TOP

PS POWER SUPPLY

• PUSHBUTTON STATION AT +48"

FIRE DETECTION AND ALARM

FACP CONTROL PANEL AT +72" TO TOP

FAA FIRE ALARM ANNUNCIATOR PANEL AT +72" TO TOP

FIRE SUPPRESSION SYSTEM ABORT SWITCH STATION AT +48"

MANUAL STATION AT +48"

THE FOLLOWING SUBSCRIPTS ARE USED TO INDICATE THE VARIOUS TYPE OF MANUAL STATIONS, FIRE SUPPRESSION SYSTEM CONTROL PANELS AND/OR ABORT SWITCHES

NO SUBSCRIPT - STANDARD FIRE ALARM PULL STATION

NO SUBSCRIPT - PHOTO ELECTRIC AREA BEAM

S SMOKE DETECTOR THE FOLLOWING SUBSCRIPTS ARE USED TO INDICATE THE VARIOUS TYPE OF SMOKE

DUCT SMOKE DETECTOR

AUTOMATIC HEAT DETECTOR

THE FOLLOWING SUBSCRIPTS ARE USED TO INDICATE THE VARIOUS TYPE OF HEAT

NO SUBSCRIPT - FIXED TEMPERATURE (155 DEGREE U.O.N.) R/F — COMBINATION RATE OF RISE FIXED TEMPERATURE (135 DEGREE U.O.N.) XP — EXPLOSION PROOF, FIXED TEMPERATURE (135 DEGREE U.O.N.) CLASS 1,

NOTE: WALL MOUNT VISUAL AND COMBINATION AUDIO/VISUAL NOTIFICATION

APPLIANCES AT +80" AFF TO BOTTOM OF FACE PLATE U.O.N. VISUAL NOTIFICATION APPLICANCE

WALL MOUNTED COMBINATION AUDIBLE/VISUAL NOTIFICATION APPLIANCE

CEILING MOUNTED VISUAL NOTIFICATION APPLIANCE

F CEILING MOUNTED COMBINATION AUDIBLE/VISUAL NOTIFICATION APPLIANCE

MAGNETIC DOOR HOLDER/RELEASE. COORDINATE MOUNTING HEIGHT WITH DOOR MANUFACTURER.

FS SPRINKLER OR STANDPIPE FLOW ALARM SWITCH CONNECTION

TS VALVE TAMPER SWITCH

SVXF SOLENOID VALVE FOR PREACTION SPRINKLER SYSTEM

AP AIR PRESSURE MONITOR SWITCH FOR PRE-ACTION OR DRY PIPE SPRINKLER SYSTEM

FR 💢 CEILING MOUNTED REMOTE ALARM INDICATOR

X NALL MOUNTED REMOTE ALARM INDICATOR AND TEST STATION AT +48"

FIRE FIGHTERS TELEPHONE JACK AT +48" FIRE FIGHTERS TELEPHONE HANDSET AT +48"

TELECOMMUNICATION

GENERAL NOTES NOTE A: OUTLETS IN FINISHED OR SHELL SPACES SHALL BE MOUNTED AT +18" NOTE B: OUTLETS LOCATED AT COUNTERS SHALL BE LOCATED 18"AFF IN KNEE SPACE IF PROVIDED OR 4" ABOVE COUNTER OR BACK SPLASH AS APPLICABLE IF NO KNEE SPACE IS PROVIDED UON.

NOTE C: WHERE ASTERISK (*) IS INDICATED NEXT TO OUTLET AT WORK COUNTER, OUTLET SHALL BE LOCATED ABOVE COUNTER RATHER THAN IN KNEE SPACE.

▼ STANDARD TELECOMMUNICATIONS OUTLET - PROVIDE EXTRA DEEP DOUBLE GANG BOX WITH SINGLE GANG MUD RING AND 1-1/4" CONDUITS TO ABOVE FINISHED CEILING. PROVIDE PLASTIC BUSHING AT THE ENDS OF THE CONDUITS. DATA DEVICES AND WIRING PROVIDED BY OTHERS U.O.N.

THE FOLLOWING SUBSCRIPTS ARE USED TO INDICATE THE VARIOUS (NON-STANDARD) TYPES OF OUTLETS

— 1ST NUMBER INDICATES QUANTITY OF DATA CABLES 2ND NUMBER INDICATES QUANTITY OF VOICE CABLES B --- BLANK (ROUGH-IN TO ACCESSABLE CEILING SPACE)

F —— FIBER W—— WALL PHONE OUTLET AT +48" C — CEILING PHONE OUTLET P —— PUBLIC TELEPHONE AT +44"

FL — PEDESTAL FLOOR FITTING

SECURITY

FIXED VIDEO SURVEILANCE CAMERA

PAN/TILT/ZOOM VIDEO SURVEILANCE CAMERA

CR CARD READER AT +48"

DOOR POSITION SWITCH CONNECTION TO ELECTRIC OR PNEUMATIC DOOR LOCK

SYMBOLS SHOWN ARE FOR REFERENCE ONLY AND DO NOT CONSTITUTE A CHECK LIST OF DEVICES REQUIRED BY THE CONTRACT

NO. | REVISIONS / SUBMISSIONS

Architects Engineers

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Ph: 810-767-5600 | THA-Flint.com

PROJECT 'B' BULLOCK CREEK MIDDLE SCHOOL **IMPROVEMENTS**

DRAWING TITLE ELECTRICAL COVER SHEET


664 SOUTH BADOUR ROAD

MIDLAND, MI


PROJECT NO. 24-120 CHECKED CAD FILE NO. REVIEWED DRAWING NO. RCH OCT 18, 2024

<u>6</u> OF <u>7</u> AS NOTED

Plot date: 10/21/2024 12:37 PM

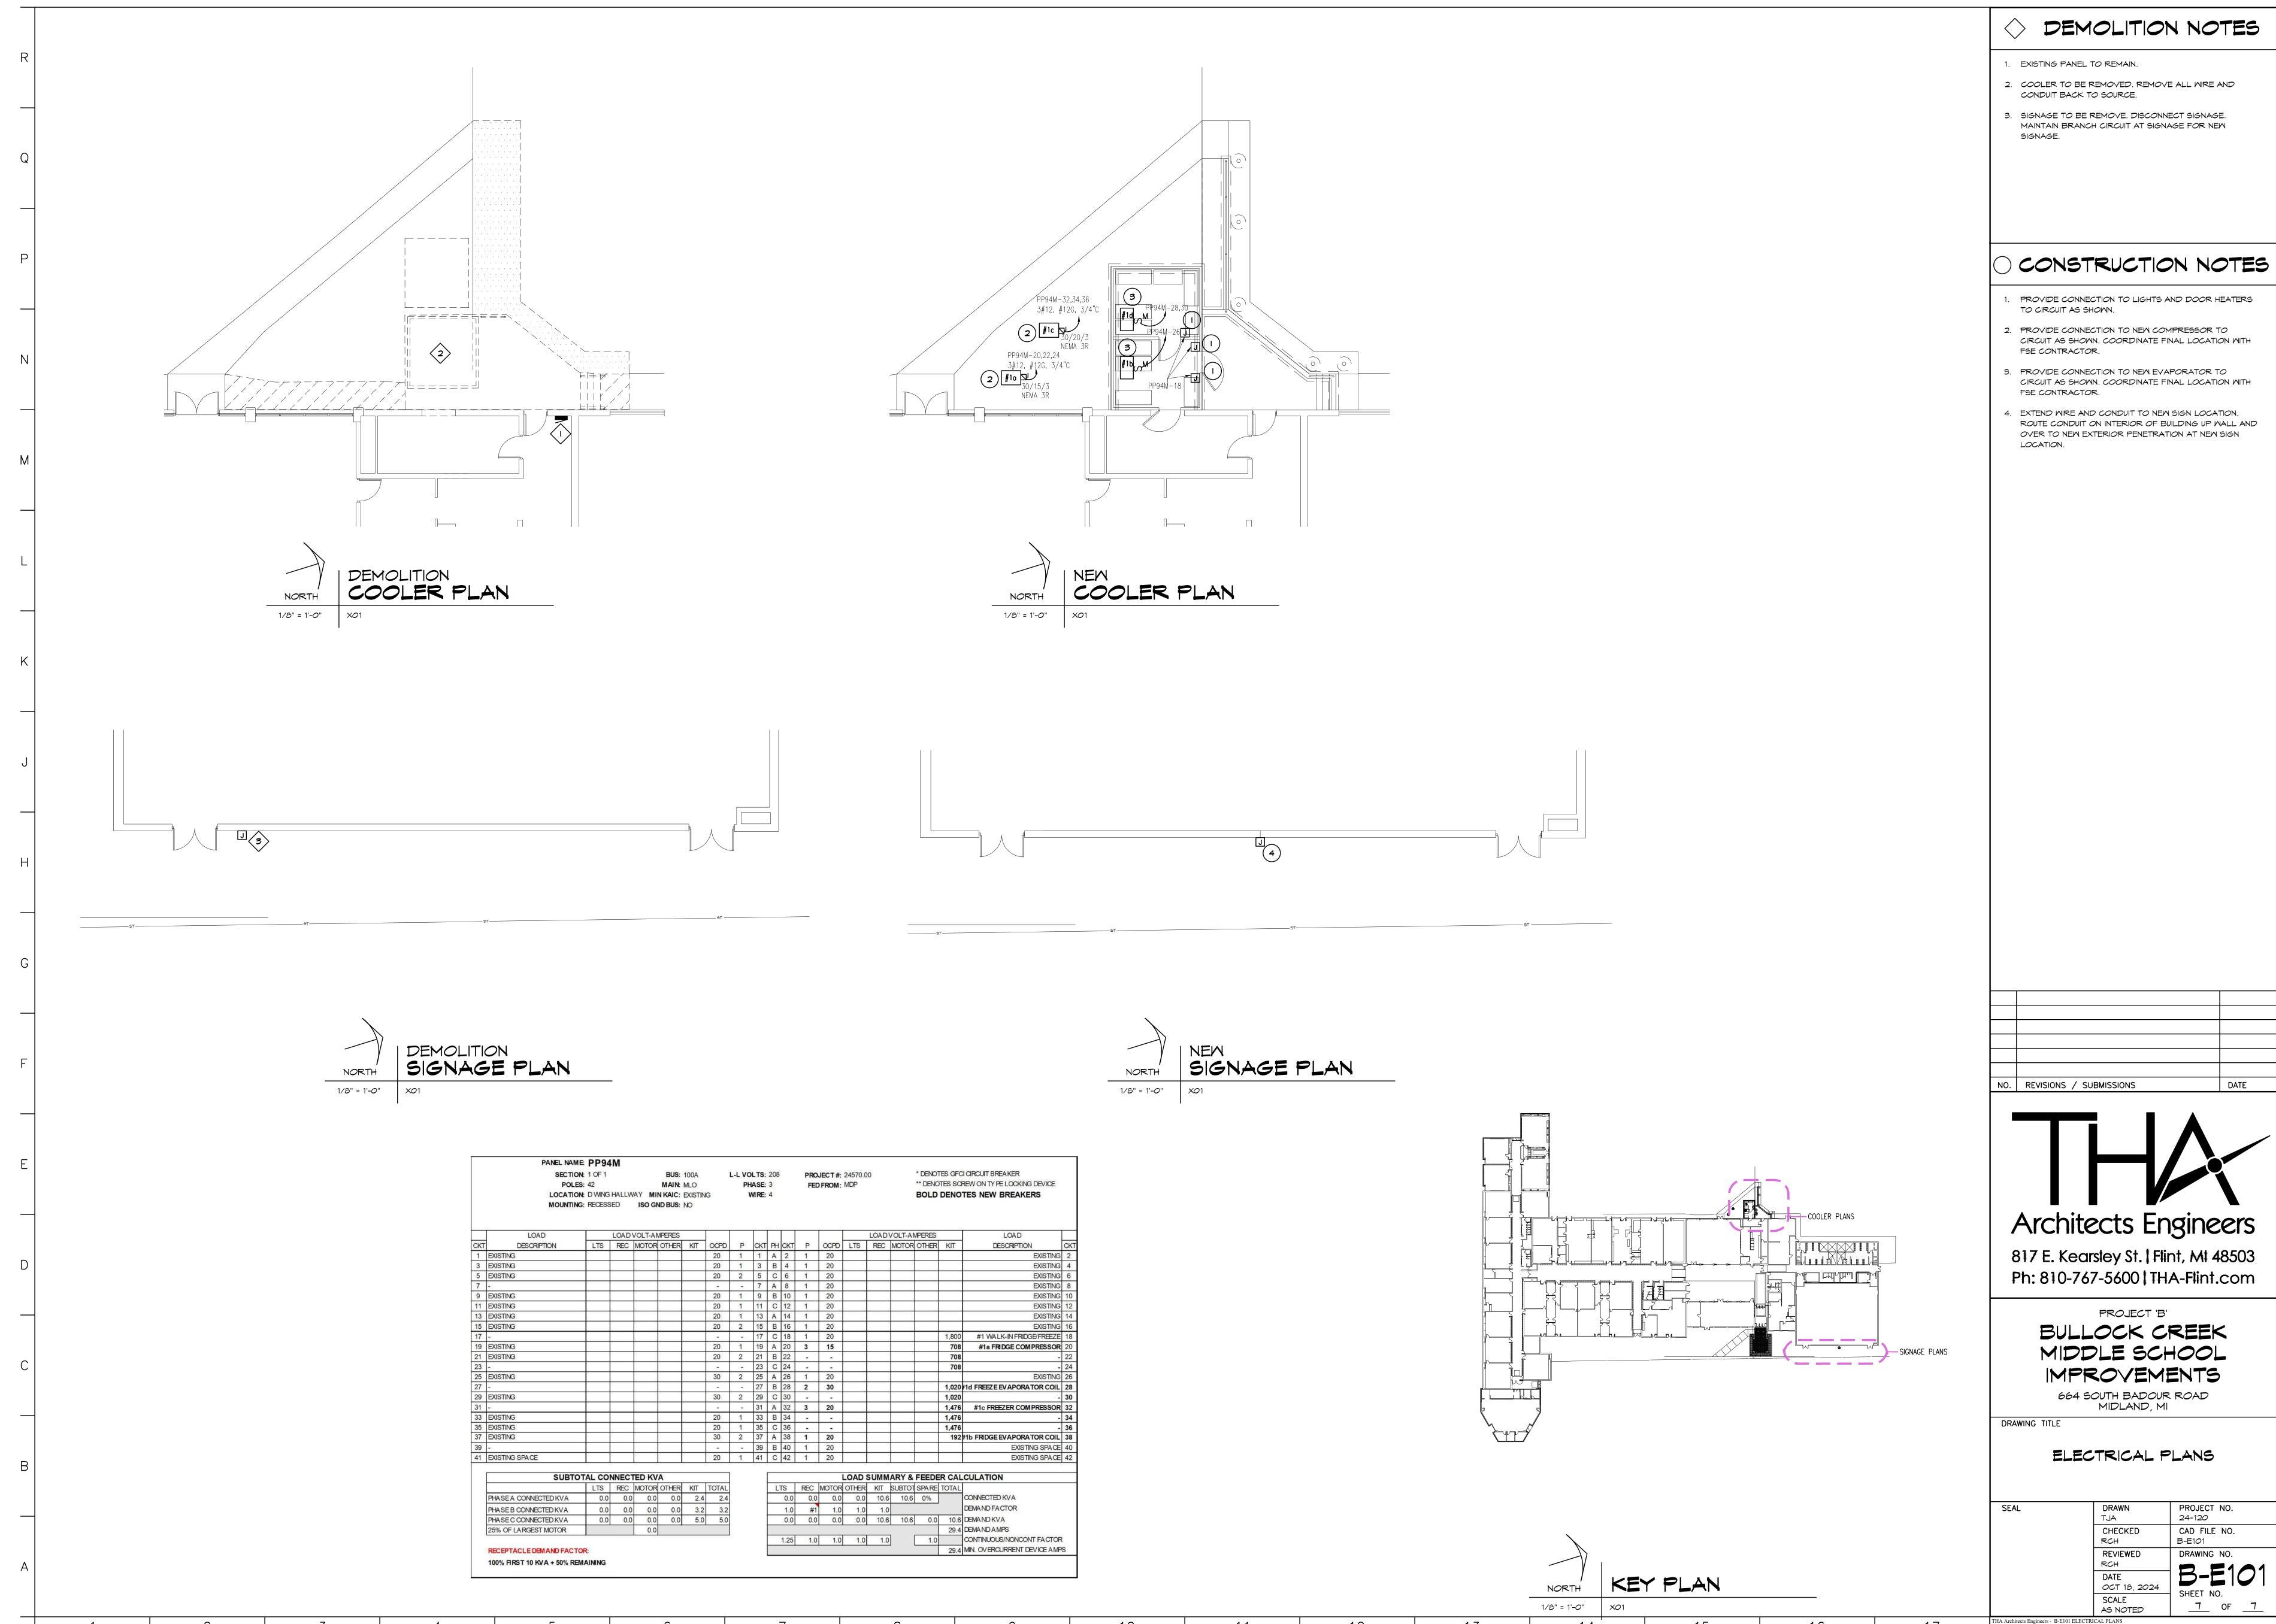

Plot date: 10/21/2024 12:37 PM

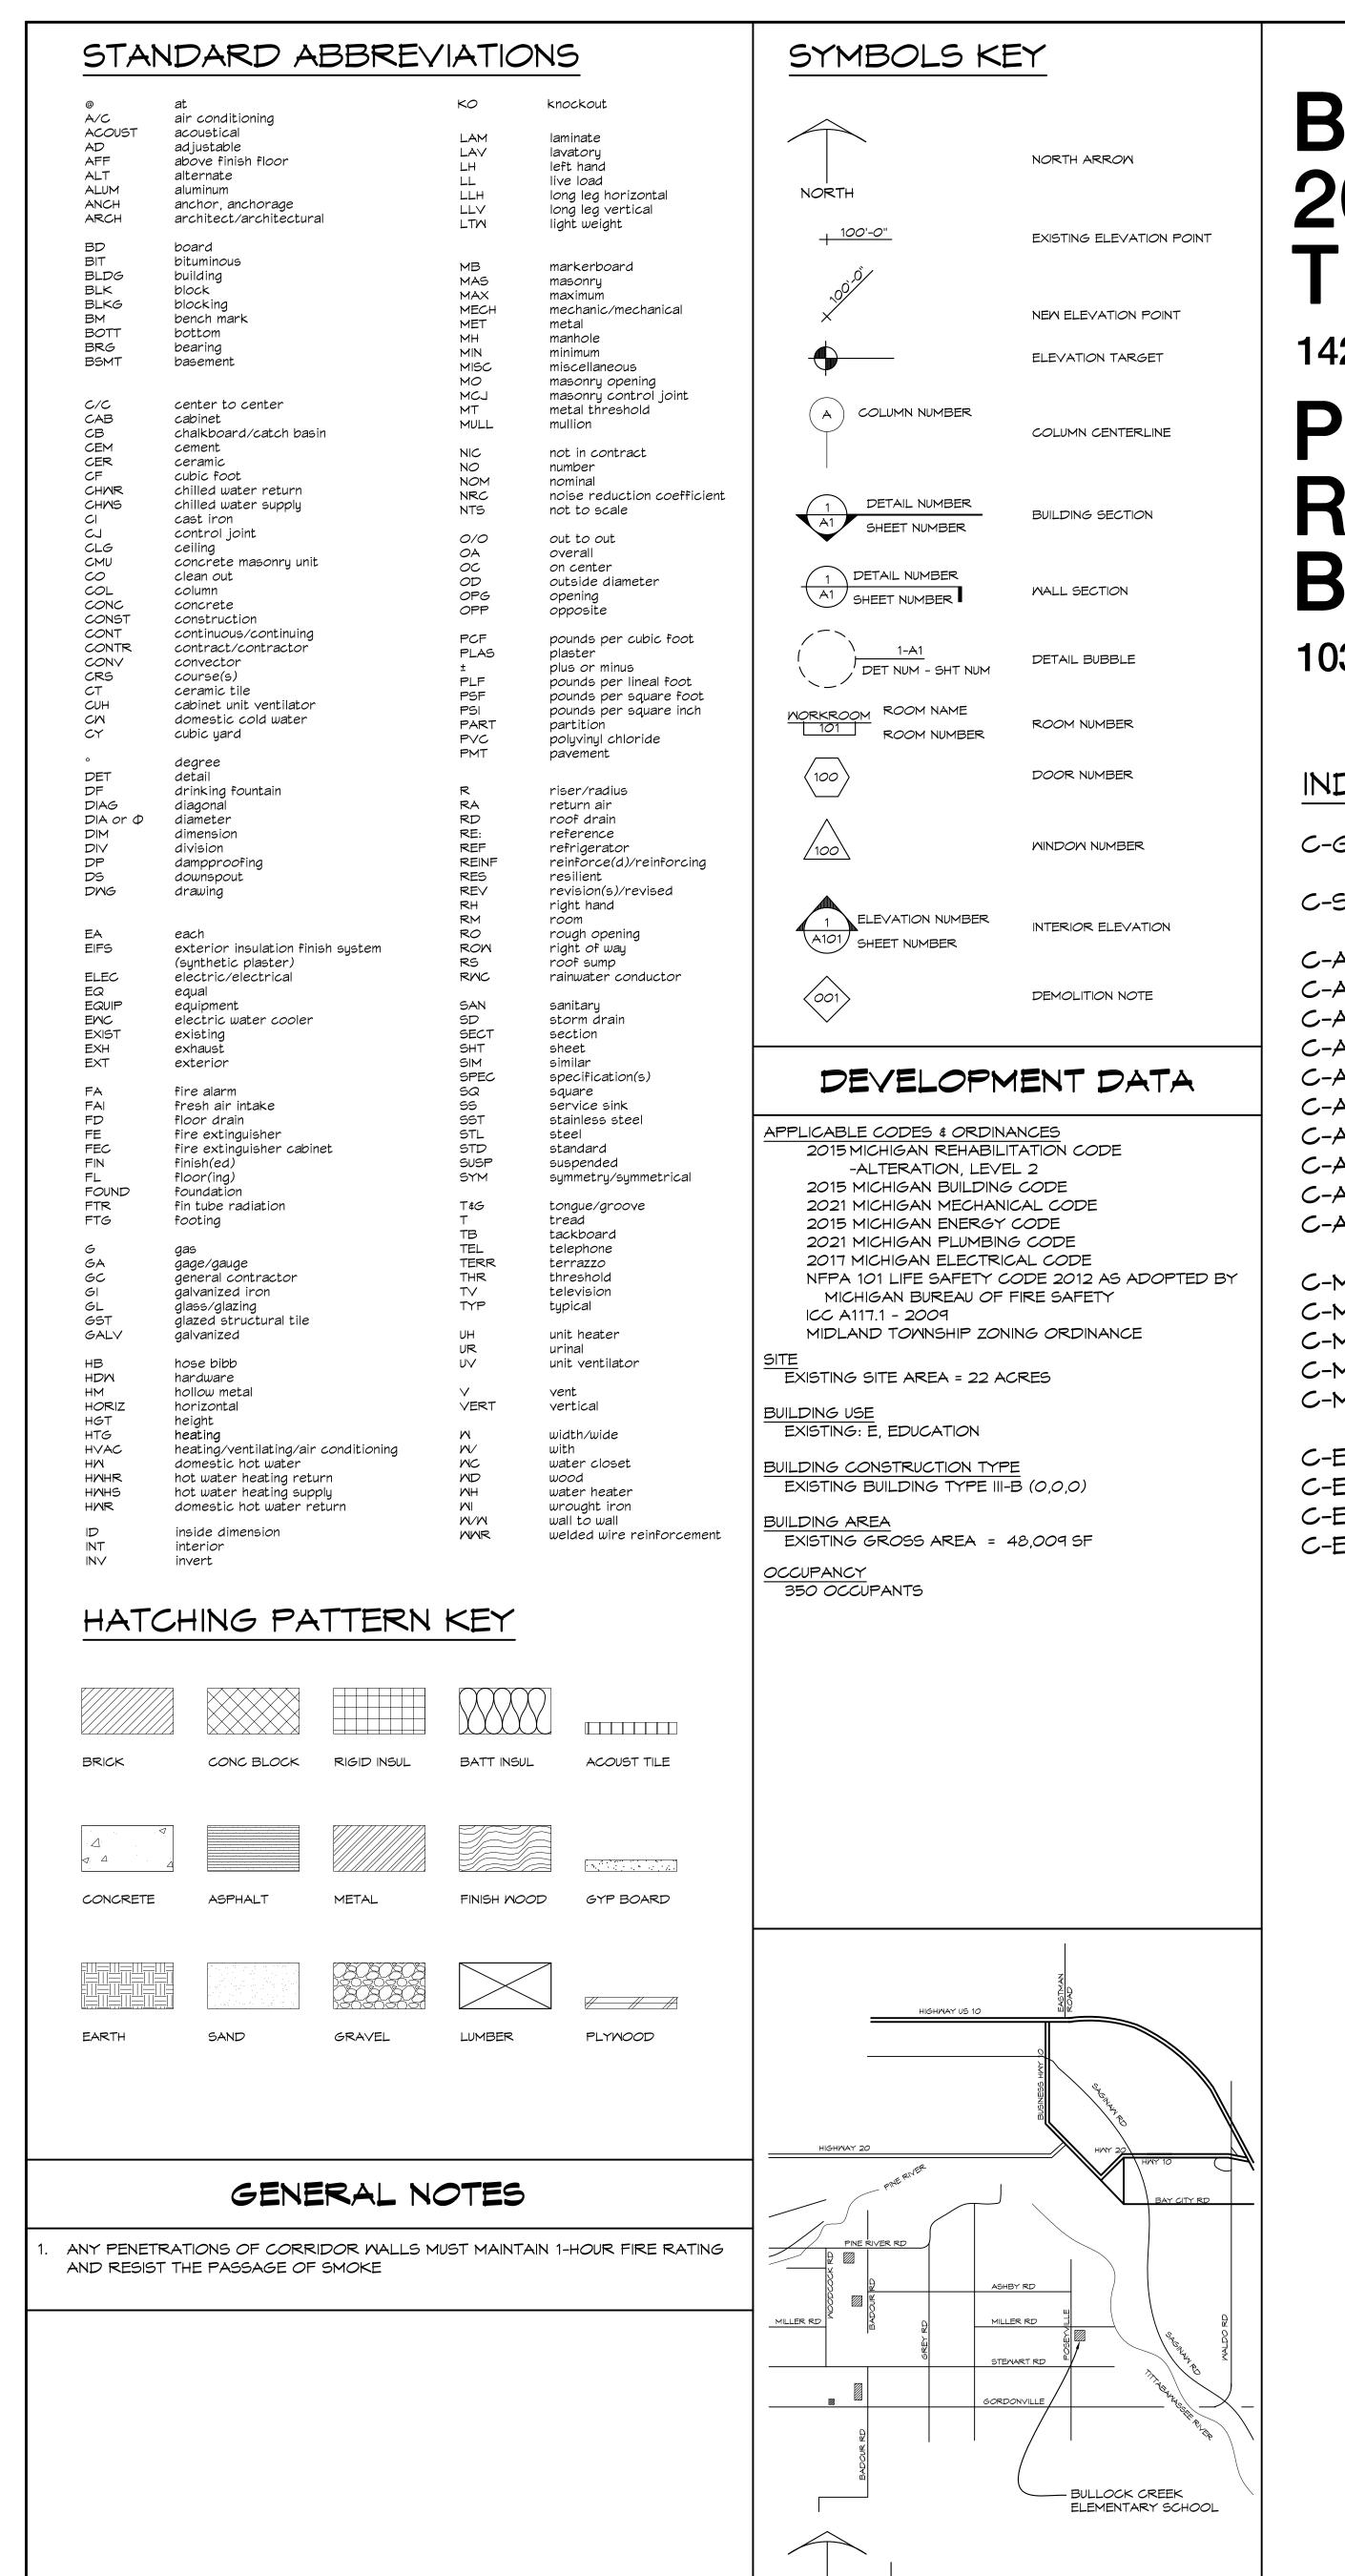

LOCATION MAP

NO SCALE

BULLOCK CREEK SCHOOL DISTRICT 2023 BOND- SERIES 1 2025 IMPROVEMENTS THA PROJECT #24-120


1420 SOUTH BADOUR ROAD MIDLAND MI 48640

PROJECT 'C' RENOVATIONS TO: BULLOCK CREEK ELEMENTARY SCHOOL

1037 S. POSEYVILLE RD MIDLAND MI 48640

INDEX OF DRAWINGS

C-G001	TITLE SHEET
C-S100	FRAMING PLAN
C-A101 C-A102 C-A103 C-A104 C-A105 C-A106 C-A107 C-A201 C-A301 C-A601	DEMOLITION PLAN ROOF DEMOLITION PLAN FLOOR PLAN REFLECTED CEILING PLAN ROOF PLAN ROOF DETAILS ROOF DETAILS EXTERIOR ELEVATIONS WALL SECTIONS DOOR SCHEDULE, ROOM FINISH SCHEDULE, & DETAILS
C-M001 C-M101 C-M102 C-M103 C-M104	MECHANICAL SCHEDULES MECHANICAL DEMOLITION ROOF PLAN MECHANICAL ROOF PLAN UNIT A MECHANICAL PLAN UNITS B & C MECHANICAL PLAN
	ELECTRICAL COVER SHEET ELECTRICAL DEMOLITION PLAN ELECTRICAL PLANS ELECTRICAL ROOF PLAN

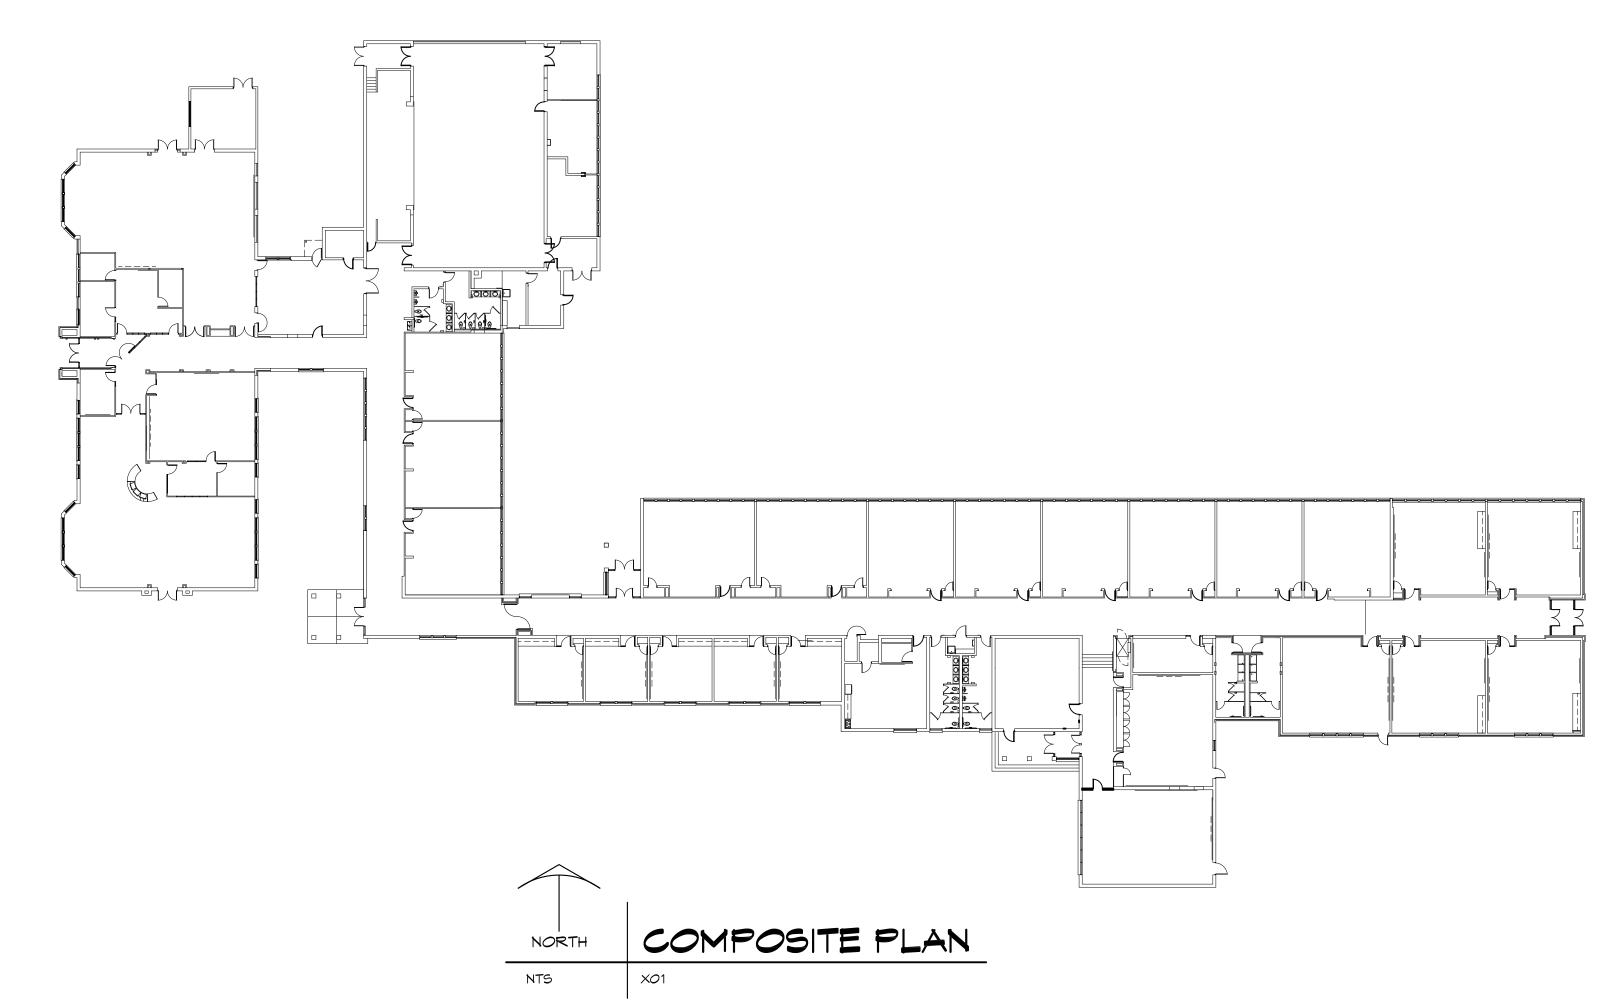





Executive One Building 4835 Towne Centre Road Suite 203 Saginaw, MI 48604 Phone: (989) 790-9120 Fax: (989) 790-9063 www.wolgastconstruction.com

PROJECT # 24-120 BOUR ROAD MIDLAND MI 48640 ECT 'C' VATIONS TO:

NO. REVISIONS / SUBMISSIONS

DATE

DRAWN
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MLB

DATE
OCT 18, 2024

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DATE

PROJECT NO.
24-120

CAD FILE NO.
C-GOO1

SHEET NO.
1 OF 21

B S ← F C C E

N.T.S.

THA Architects Engineers - P:\Bullock Creek\24-120 2023 Bond Series 1 2025 Improvements\Drafting\01-CAD\BC EL\03-Cl

3/8" X 7" X 7" W/ (2) 1/2" Ø X 6" LG HEADED STUDS (GA = 5")

BEARING PLATE SCHEDULE

STEEL LINTEL SCHEDULE

BRICK VENEER,

SEE ARCH

1/4 / 4-12

W8X10 + 5/16" PL

W14X26 + 5/16" PL

BEARING PLATE

— EX CMU TO REMAIN

PROVIDE 1/2" Ø X 6" LG

EXISTING CMU WALLS

MUST BE SHORED.


- HEADED STUDS @ 24" AT

EXTERIOR STEEL LINTELS




1/2" Ø X 6" LG

HEADED STUDS

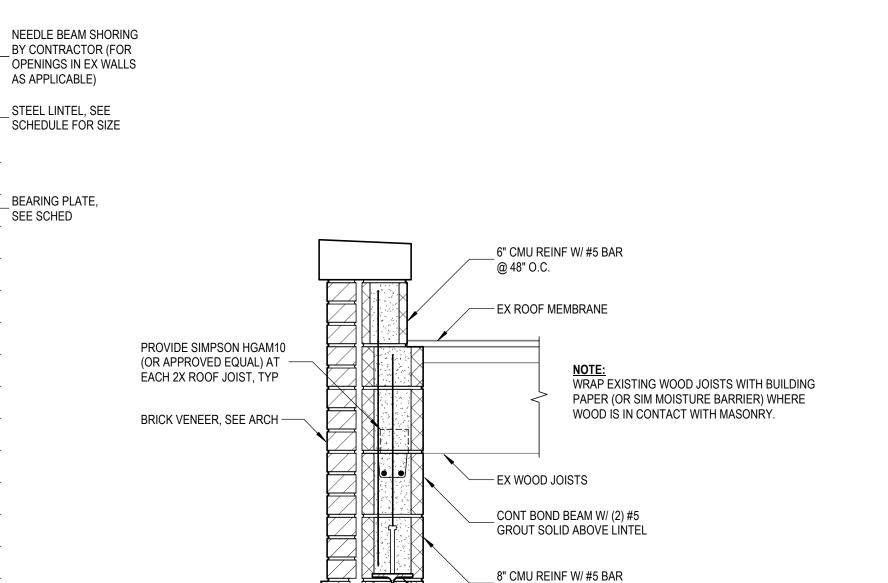

@ 48" O.C.

STEEL LINTEL SEE 2/C-S100

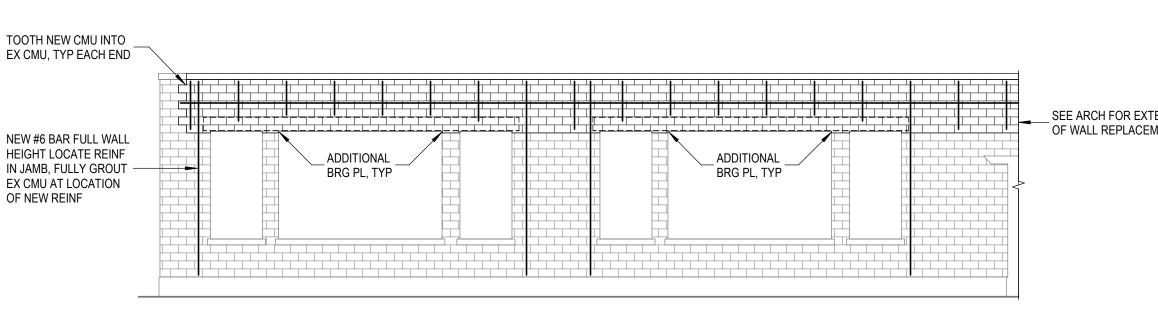

GROUT POCKET SOLID

SEE PLAN FOR SIZE OF BEAM.

REFER TO SCHEDULE FOR

PLACE BEARING PLATE ON

CENTER LINE OF CMU WALL

GROUT EX CMU BELOW LINTEL

BRG (IF GROUT NOT EXISTING)

- BEARING PLATE SIZE.

SEE BEARING PLATE

SCHEDULE

— END OF WALL

TYPICAL BEAM PARALLEL TO WALL

STOP PLATE AT

FOUNDATION DOWELS NOT SHOWN.

EDGE OF OPENING

4 TYPICAL MASONRY OPENING W/ STEEL LINTEL

AFTER ERECTION

WALL ABOVE LINTEL NOT

SHOWN FOR CLARITY.

CMU WALL ---

FINISH FLOOR
SEE PLAN



NO.	REVISIONS / SUBMISSIONS DATE
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	Architects Engineers 317 E. Kearslev St. Flint, MI 48503

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> PROJECT 'C' RENOVATIONS FOR: **BULLOCK CREEK ELEMENTARY SCHOOL**

1037 S. POSEYVILLE RD MIDLAND, MI DRAWING TITLE

FRAMING PLAN

PROJECT NO. D. BART CHECKED CAD FILE NO. N. STURTEVANT E. MANNOR C-S100 10-18-24

DESIGN CRITERIA

MICHIGAN BUILDING CODE 2015 (ASCE 7-10)

- 1. THIS BUILDING HAS BEEN DESIGNED AND SHALL BE CONSTRUCTED IN ACCORDANCE WITH THE MICHIGAN BUILDING CODE, 2015 EDITION. 2. THE OWNER WILL EMPLOY QUALIFIED SPECIAL INSPECTORS TO PERFORM INSPECTIONS IN ACCORDANCE WITH CHAPTER 17 OF THE MICHIGAN BUILDING CODE,
- EXCEPT AS NOTED BELOW. SPECIAL INSPECTIONS WILL BE PERFORMED FOR THE FOLLOWING: A. MASONRY. I. MASONRY SPECIAL INSPECTION SHALL BE PERFORMED IN ACCORDANCE WITH
- TMS 402 & TMS 602 AND SHALL BE LEVEL B QUALITY ASSURANCE. B. STEEL. I. STEEL SPECIAL INSPECTION SHALL BE PERFORMED IN ACCORDANCE WITH AISC
- . WHEN "PROFESSIONAL ENGINEER" IS REFERRED TO IN THE FOLLOWING NOTES, IT DENOTES A LICENSED PROFESSIONAL ENGINEER REGISTERED IN THE STATE OF MICHIGAN, QUALIFIED TO PERFORM THE WORK.
- 4. THE CONTRACTOR SHALL VISIT THE SITE TO BECOME FAMILIAR WITH THE EXISTING CONDITIONS, THE OWNERS REQUIREMENTS FOR ACCESS TO THE SITE AND CONTINUED OPERATIONS DURING CONSTRUCTION.
- 5. THE PLAN, DETAIL DIMENSIONS & ELEVATIONS RELATIVE TO THE EXISTING STRUCTURE HAVE BEEN TAKEN FROM AVAILABLE DRAWINGS. IT SHALL BE THE RESPONSIBILITY OF THE CONTRACTOR TO VERIFY SUCH DIMENSIONS, ELEVATIONS & DETAILS AS NECESSARY AND MAKE APPROVED ADJUSTMENTS PRIOR TO CONSTRUCTION OR ORDERING OF MATERIAL.
- 6. THE STRUCTURE SHALL BE CONSIDERED TO BE IN AN UNSTABLE CONDITION UNTIL ALL WALL STRUCTURES ARE COMPLETED. CONTRACTOR SHALL PROVIDE TEMPORARY BRACING FOR STABILITY AND TO RESIST LATERAL LOADS DURING ERECTION.

DIVISION 2 - DEMOLITION/SHORING

- 1. CONTRACTOR SHALL PROVIDE ALL NECESSARY SHORING WHERE REQUIRED DURING CONSTRUCTION. SHORING SHALL BE DESIGNED & DETAILED UNDER THE DIRECT SUPERVISION OF A PROFESSIONAL ENGINEER. SHORING PROCEDURES, DESIGNS AND DETAILS SHALL BE SUBMITTED FOR REVIEW PRIOR TO COMMENCEMENT OF WORK,
- 2. THE CONTRACTOR IS RESPONSIBLE FOR DETERMINING ERECTION PROCEDURE AND SEQUENCING AND TO SUBMIT WRITTEN PROCEDURES TO ENSURE THE SAFETY OF THE STRUCTURE AND IT'S COMPONENTS DURING ERECTION.
- 3. FIELD VERIFY ALL EXISTING CONDITIONS PRIOR TO DEMOLITION. IF CONDITIONS EXIST THAT ARE DIFFERENT FROM WHAT IS INDICATED ON THE DRAWINGS, NOTIFY

- 1. THE LATEST REVISION OF THE FOLLOWING CODES GOVERN THE DESIGN, DETAILING AND CONSTRUCTION OF ALL MASONRY:
- A. THE MASONRY SOCIETY (TMS) TMS 402, BUILDING CODE REQUIREMENTS FOR MASONRY STRUCTURES. B. TMS 602, SPECIFICATIONS FOR MASONRY STRUCTURES.
- 2. ALL MASONRY SHALL HAVE A MINIMUM COMPRESSIVE STRENGTH OF F'm = 2000 PSI.
- 4. ALL GROUT SHALL HAVE A MINIMUM 28 DAY COMPRESSIVE STRENGTH OF 2000 PSI AND
- SHALL BE PROPORTIONED BY VOLUME ACCORDING TO ASTM C476.
- UNITS UNLESS NOTED OTHERWISE. UNITS SHALL HAVE A MINIMUM NET AREA COMPRESSIVE STRENGTH OF 2000 PSI.
- 6. ALL MASONRY REINFORCING SHALL BE SECURED IN PLACE WITH REBAR POSITIONERS AND SPACERS.
- 7. IN ADDITION TO ALL OTHER REINFORCING IN MASONRY WALLS PROVIDE A MINIMUM OF (1) #5 BAR AT EACH SIDE OF ALL OPENINGS, EACH SIDE OF CONTROL JOINTS, AT CORNERS OR ENDS OF WALLS AND AT BEAM OR LINTEL BEARING. BAR TO BE FULL HEIGHT OF WALL.
- 8. THE CONTRACTOR IS RESPONSIBLE FOR PROVIDING TEMPORARY WALL BRACING ADEQUATE TO RESIST LATERAL LOADS.
- 9. REFER TO ARCHITECTURAL DRAWINGS AND SPECIFICATIONS FOR TYPE, SIZE, LOCATION AND ATTACHMENT REQUIREMENTS FOR MASONRY VENEER AND OTHER

DIVISION 5 - STRUCTURAL STEEL

- 1. THE LATEST REVISION OF THE FOLLOWING CODES GOVERN THE DESIGN, DETAILING, FABRICATION AND ERECTION OF ALL STRUCTURAL STEEL.
- A. AMERICAN INSTITUTE OF STEEL CONSTRUCTION (AISC) AISC 360, SPECIFICATION FOR STRUCTURAL STEEL BUILDINGS. B. AISC 303, CODE OF STANDARD PRACTICE FOR STEEL BUILDINGS AND BRIDGES.
- 2. STRUCTURAL STEEL SHALL CONFORM TO THE FOLLOWING ASTM MATERIAL SPECIFICATIONS:
- A. W AND WT SHAPES: ASTM A992, GRADE 50 (Fy = 50 KSI). B. MISCELLANEOUS SHAPES AND PLATES: ASTM A36 (Fy = 36 KSI).

WILL DETERMINE THE CORRECTIVE ACTION REQUIRED.

- 3. ALL WELDING SHALL BE PERFORMED USING THE ELECTRIC ARC METHOD IN ACCORDANCE WITH THE LATEST REVISION OF THE AMERICAN WELDING SOCIETY (AWS) D1.1 "STRUCTURAL WELDING CODE". E70XX ELECTRODES CONFORMING TO AWS A5.1 OR A5.5 SHALL BE USED FOR SHIELDED METAL ARC METHOD & FX7-ECXX FLUX -ELECTRODE COMBINATION CONFORMING TO AWS A5.17 FOR SUBMERGED ARC METHOD.
- 4. ALL BOLTS SHALL BE 3/4" DIAMETER ASTM F3125 GRADE A325 TYPE N BOLTS. ALL BOLTED CONNECTIONS SHALL BE SNUG-TIGHT BEARING TYPE BOLTS UNLESS NOTED OTHERWISE.
- 5. ALL SHOP AND FIELD WELDS SHALL BE VISUALLY INSPECTED PER AWS D1.1. ALL DEFICIENT OR NON CONFORMING ITEMS SHALL BE REPORTED TO THE ENGINEER WHO
- 6. GROUT REQUIRED UNDER COLUMN BASE PLATES AS SHOWN IN THE DETAILS SHALL BE A STANDARD NON-SHRINK GROUT SUCH AS "MASTERFLOW 100" BY MASTER BUILDERS.
- 7. PROVIDE AND HAVE IN PLACE ADEQUATE LATERAL BRACING AND VERTICAL SUPPORTS FOR THE SAFE ERECTION AND TRUE ALIGNMENT OF THE STRUCTURAL STEEL. THIS CONTRACTOR ASSUMES FULL RESPONSIBILITY FOR THE SAFE ERECTION AND TEMPORARY BRACING OF STRUCTURAL STEEL.
- 8. VERIFY NUMBER AND SIZE OF OPENINGS IN WALLS WITH ARCHITECTURAL, MECHANICAL AND ELECTRICAL DRAWINGS. SEE DETAILS, AND SPECIFICATIONS, FOR STRUCTURAL REQUIREMENTS. VERIFY ALL INFORMATION WITH THE APPROPRIATE CONTRACTOR.
- 9. ALL DIMENSIONS RELATED TO STRUCTURAL STEEL USED TO SUPPORT EQUIPMENT OR FRAME OPENINGS SHALL BE VERIFIED WITH CERTIFIED AND APPROVED SHOP DRAWINGS OF PURCHASED EQUIPMENT PRIOR TO DETAILING AND FABRICATION.
- 10. ALL BEAMS, JOISTS, OR LINTELS BEARING ON MASONRY WALLS SHALL HAVE BEARING PLATES WITH ANCHOR BOLTS. IF NOT NOTED ON PLAN, SEE TYPICAL DETAILS.
- 11. ALL WF BEAMS SUPPORTING MASONRY AND WITH SPANS GREATER THAN 6'-0" SHALL HAVE 1/2" DIAMETER BY 6" LONG HEADED CONCRETE ANCHORS SPACED AT 2'-0" O.C. WELDED TO THE TOP FLANGE.
- 12. ALL STEEL IN EXTERIOR MASONRY WALLS IS TO BE HOT-DIP GALVANIZED IN ACCORDANCE WITH ASTM A-123.

RISK CATEGORY III. ROOF DEAD LOADS WOOD SHEATHING 5 PSF WOOD JOISTS 1 PSF EPDM 3 PSF CEILING SAP MECHANICAL AND ELECTRICAL 4 PSF 5 PSF MISCELLANEOUS 2 PSF 22 PSF INSULATION TOTAL SNOW LOADS IMPORTANCE FACTOR GROUND SNOW LOAD $P_g = 35 PSF$ SNOW EXPOSURE FACTOR $C_e = 1.0$ THERMAL FACTOR $C_t = 1.0$ FLAT USE SNOW $P_f = 27 PSF$ SNOW DRIFT PER ASCE 7

ABBREVIATIONS

ANCHOR BOLT

ADD'L	ADDITIONAL
A.F.F.	ABOVE FINISHED FLOOR
B.C.	BOTTOM CHORD
B.O.	BOTTOM OF
B.O.D.	BOTTOM OF DECK
B.O.F.	BOTTOM OF FOOTING
B.O.S.	BOTTOM OF STEEL
B.O.T.	BOTTOM OF TRUSS
B.S.	BOTH SIDES
BM	BEAM
BOTT	BOTTOM
BRG	BEARING
C.L.	CENTER LINE
CJ	CONTROL JOINT
COL	COLUMN
CONC	CONCRETE
CONT	CONTINUOUS
CSJ	CONSTRUCTION JOINT
DET	DETAIL
DIA	DIAMETER
DIAG	DIAGONAL
DIM	DIMENSION
DL	DEAD LOAD
DWG	DRAWING

EACH FACE **ELEVATION** ELEV EQUAL **EXISTING**

FAR SIDE FIELD VERIFY FINISH FLG FLANGE FLOOR **FOUNDATION** FOOT

FOOTING GAGE GIRT LINE HIGH POINT HORIZ HORIZONTAL LONG LOW POINT LIVE LOAD LONG LEG HORIZONTAL

LONG LEG VERTICAL L.L.V. LONG SIDE HORIZONTAL MAXIMUM MTL METAL MINIMUM MISCELLANEOUS NEAR SIDE NOT TO SCALE NUMBER ON CENTER

> OPPOSITE PIECE PLATE **PLACES** REFERENCE RINFORC-ED, -ING, EMENT REQUIRED

WITH WELDED WIRE REINFORCEMENT

POUNDS PER SQUARE FOOT POUNDS PER SQUARE INCH REQ'D SCHED SECT SCHEDULE SECTION SIMILAR SPACES STANDARD STEEL TOP OF TOP OF CONCRETE TOP OF FOOTING TOP OF MASONRY T.O.S. TOP OF STEEL TYPICAL U.N.O. UNLESS NOTED OTHERWISE VERTICAL W.P. **WORK POINT** WWR

 $\mathsf{TYP} \underbrace{\left(\begin{array}{c} 2 \\ \mathsf{C-S100} \end{array} \right)}_{\text{ } \parallel \mathbf{h} \text{ } .}$ SHORING LOAD: D.L. = 880 PLF L.L. 300 PLF (ASSUMED MAX 20 PSF LIVE LOAD ON ROOF

SHORING LOAD) TYPICAL ALONG WEST WALL

6 C-S100

LINTEL T.O.S.
9'-8" A.F.F., TYP

ROOF SHORING LOAD: L.L. 300 PLF (ASSUMED MAX 20 PSF LIVE LOAD ON ROOF

PARTIAL ROOF FRAMING PLAN
SCALE: 1/8" = 1'-0"

EX 2X @ 16" O.C. TYP

__EX 2X @ 16" O.C. TYP

SEE ARCH FOR EXTENT OF WALL REPLACEMENT

ENGINEERS | ARCHITECTS | SURVEYORS

STRUCTURAL GENERAL NOTES

- ALLOW (2) WEEKS FOR ENGINEER TO REVIEW.
- ARCHITECT FOR DIRECTION BEFORE PROCEEDING.

DIVISION 4 - MASONRY

- 3. ALL MORTAR SHALL BE TYPE S, PROPORTIONED BY VOLUME ACCORDING TO ASTM
- 5. ALL CONCRETE MASONRY UNITS SHALL BE NORMAL WEIGHT ASTM C90, GRADE N,


EX 2X @ 16" O.C. TYP


SHORING LOAD)


LOCATIONS WHERE


WALL IS REMOVED


ABOVE EX WINDOWS

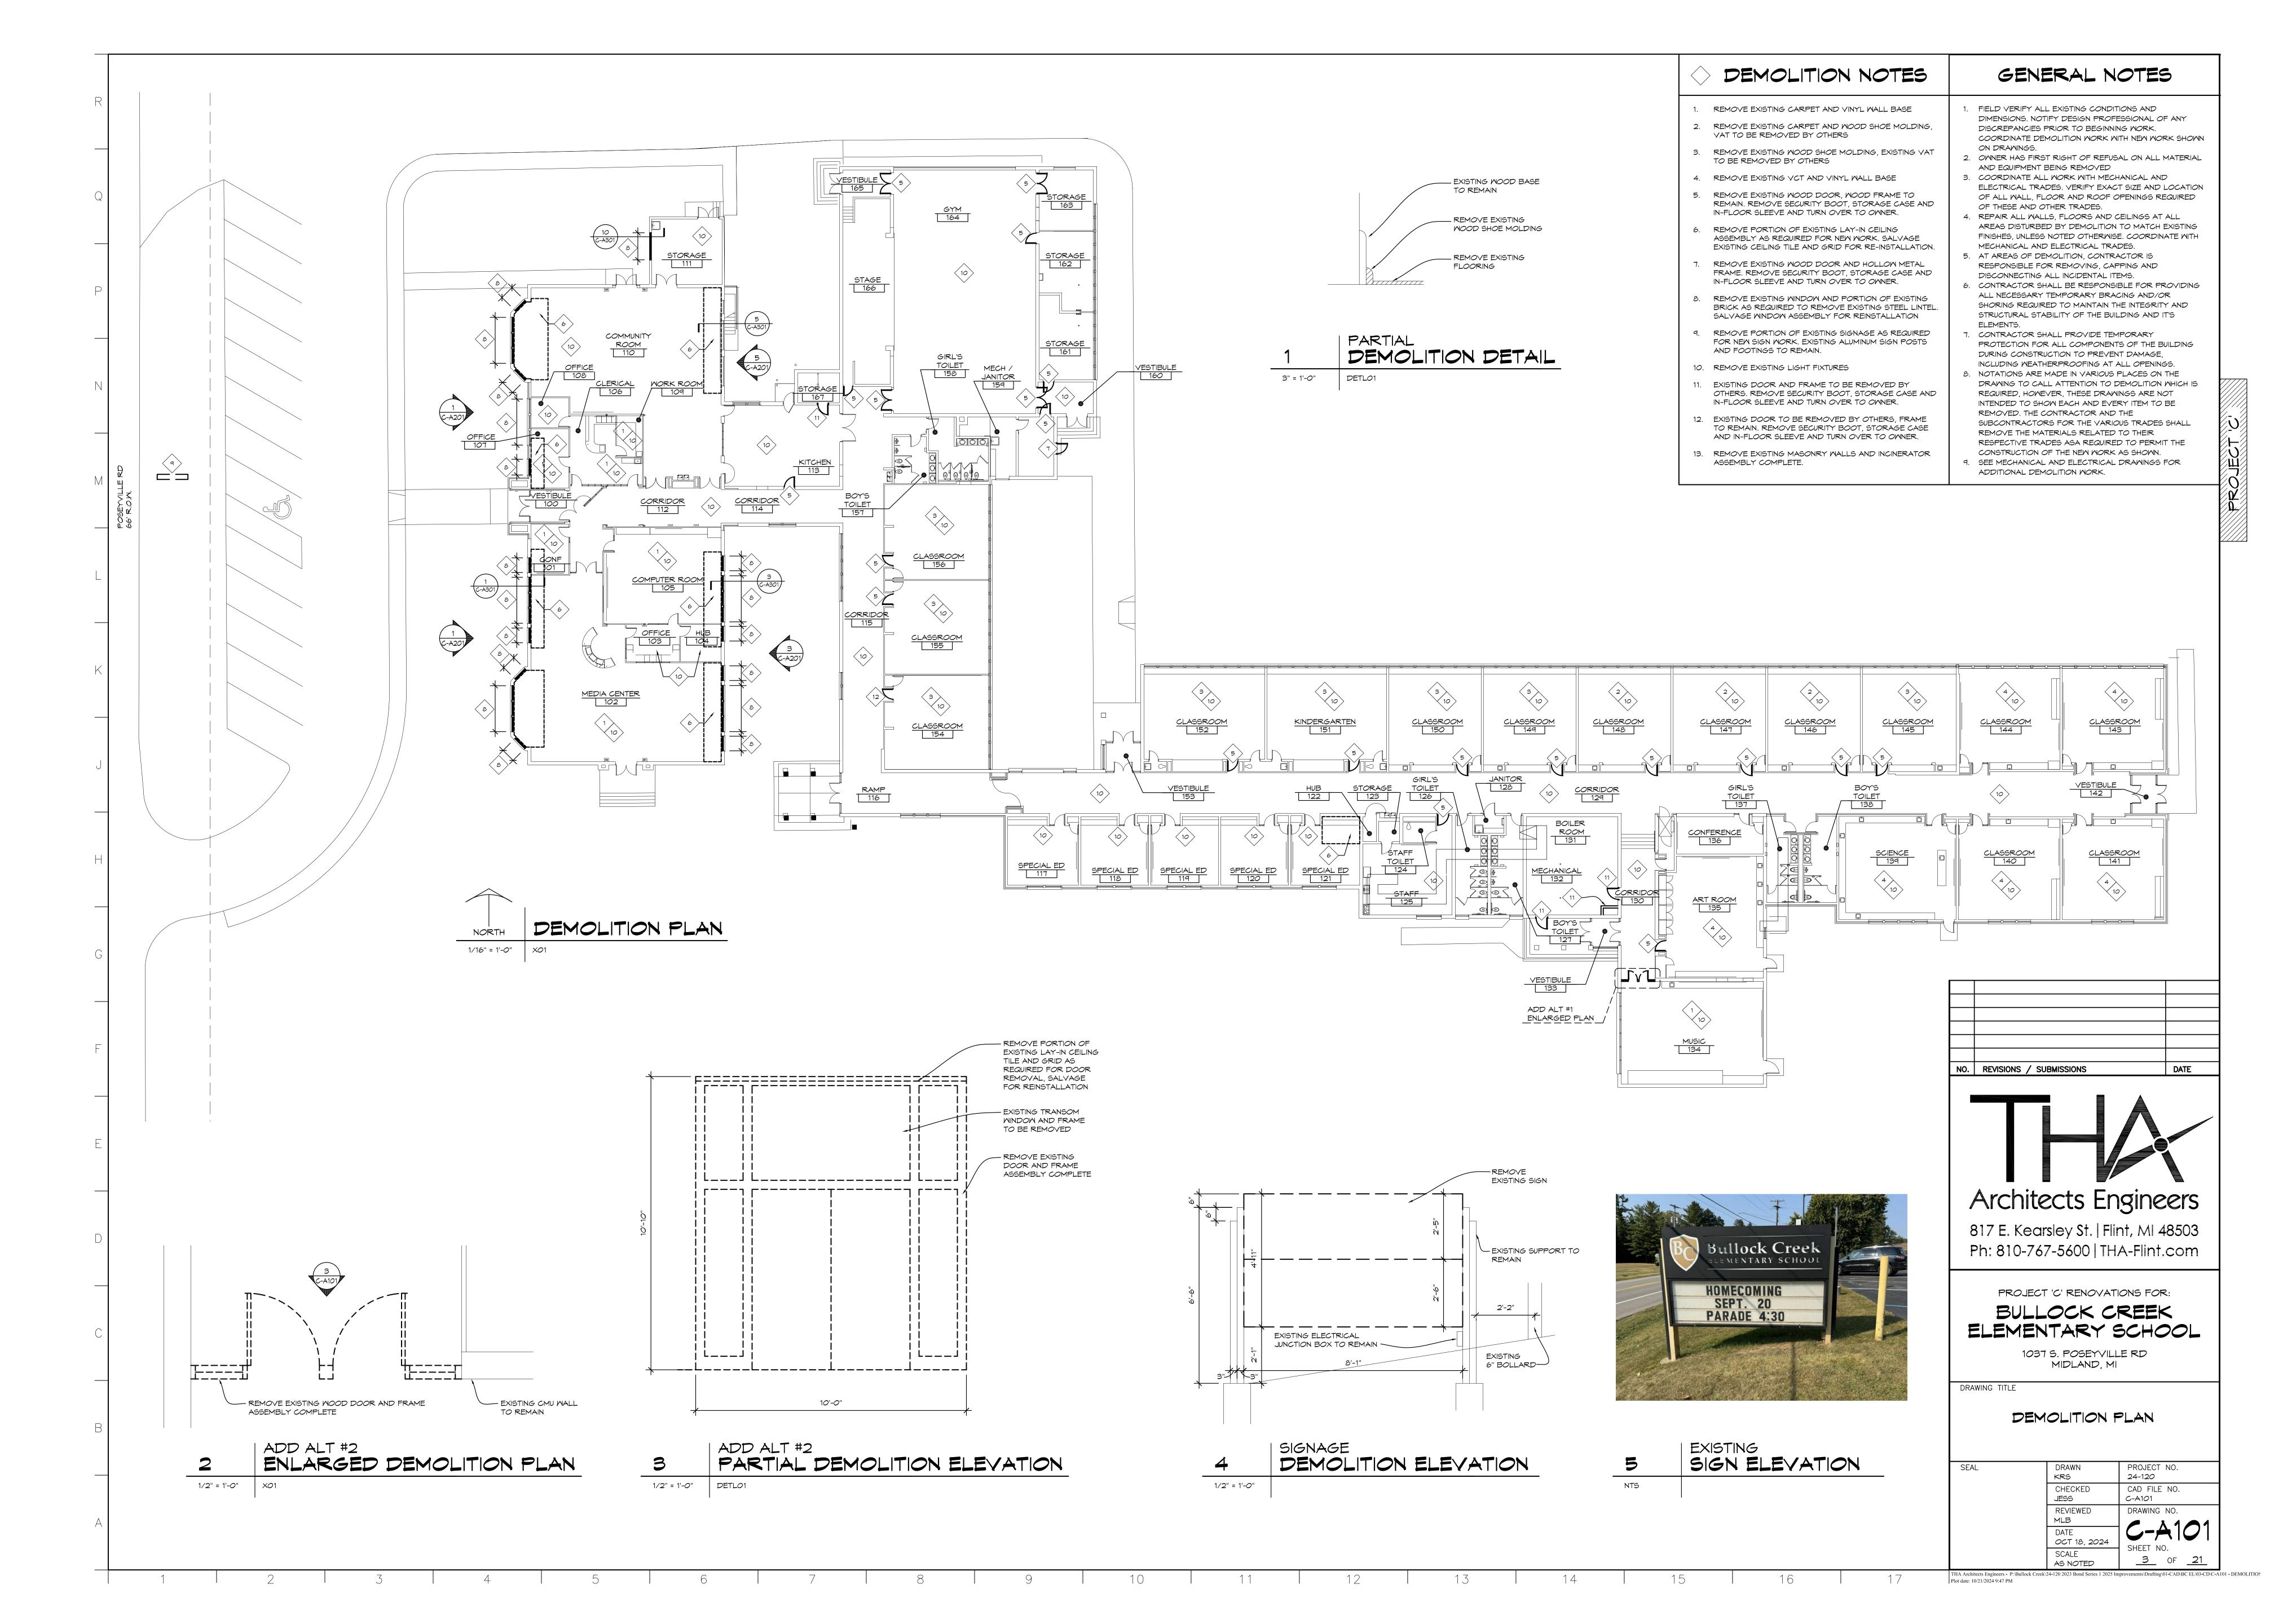


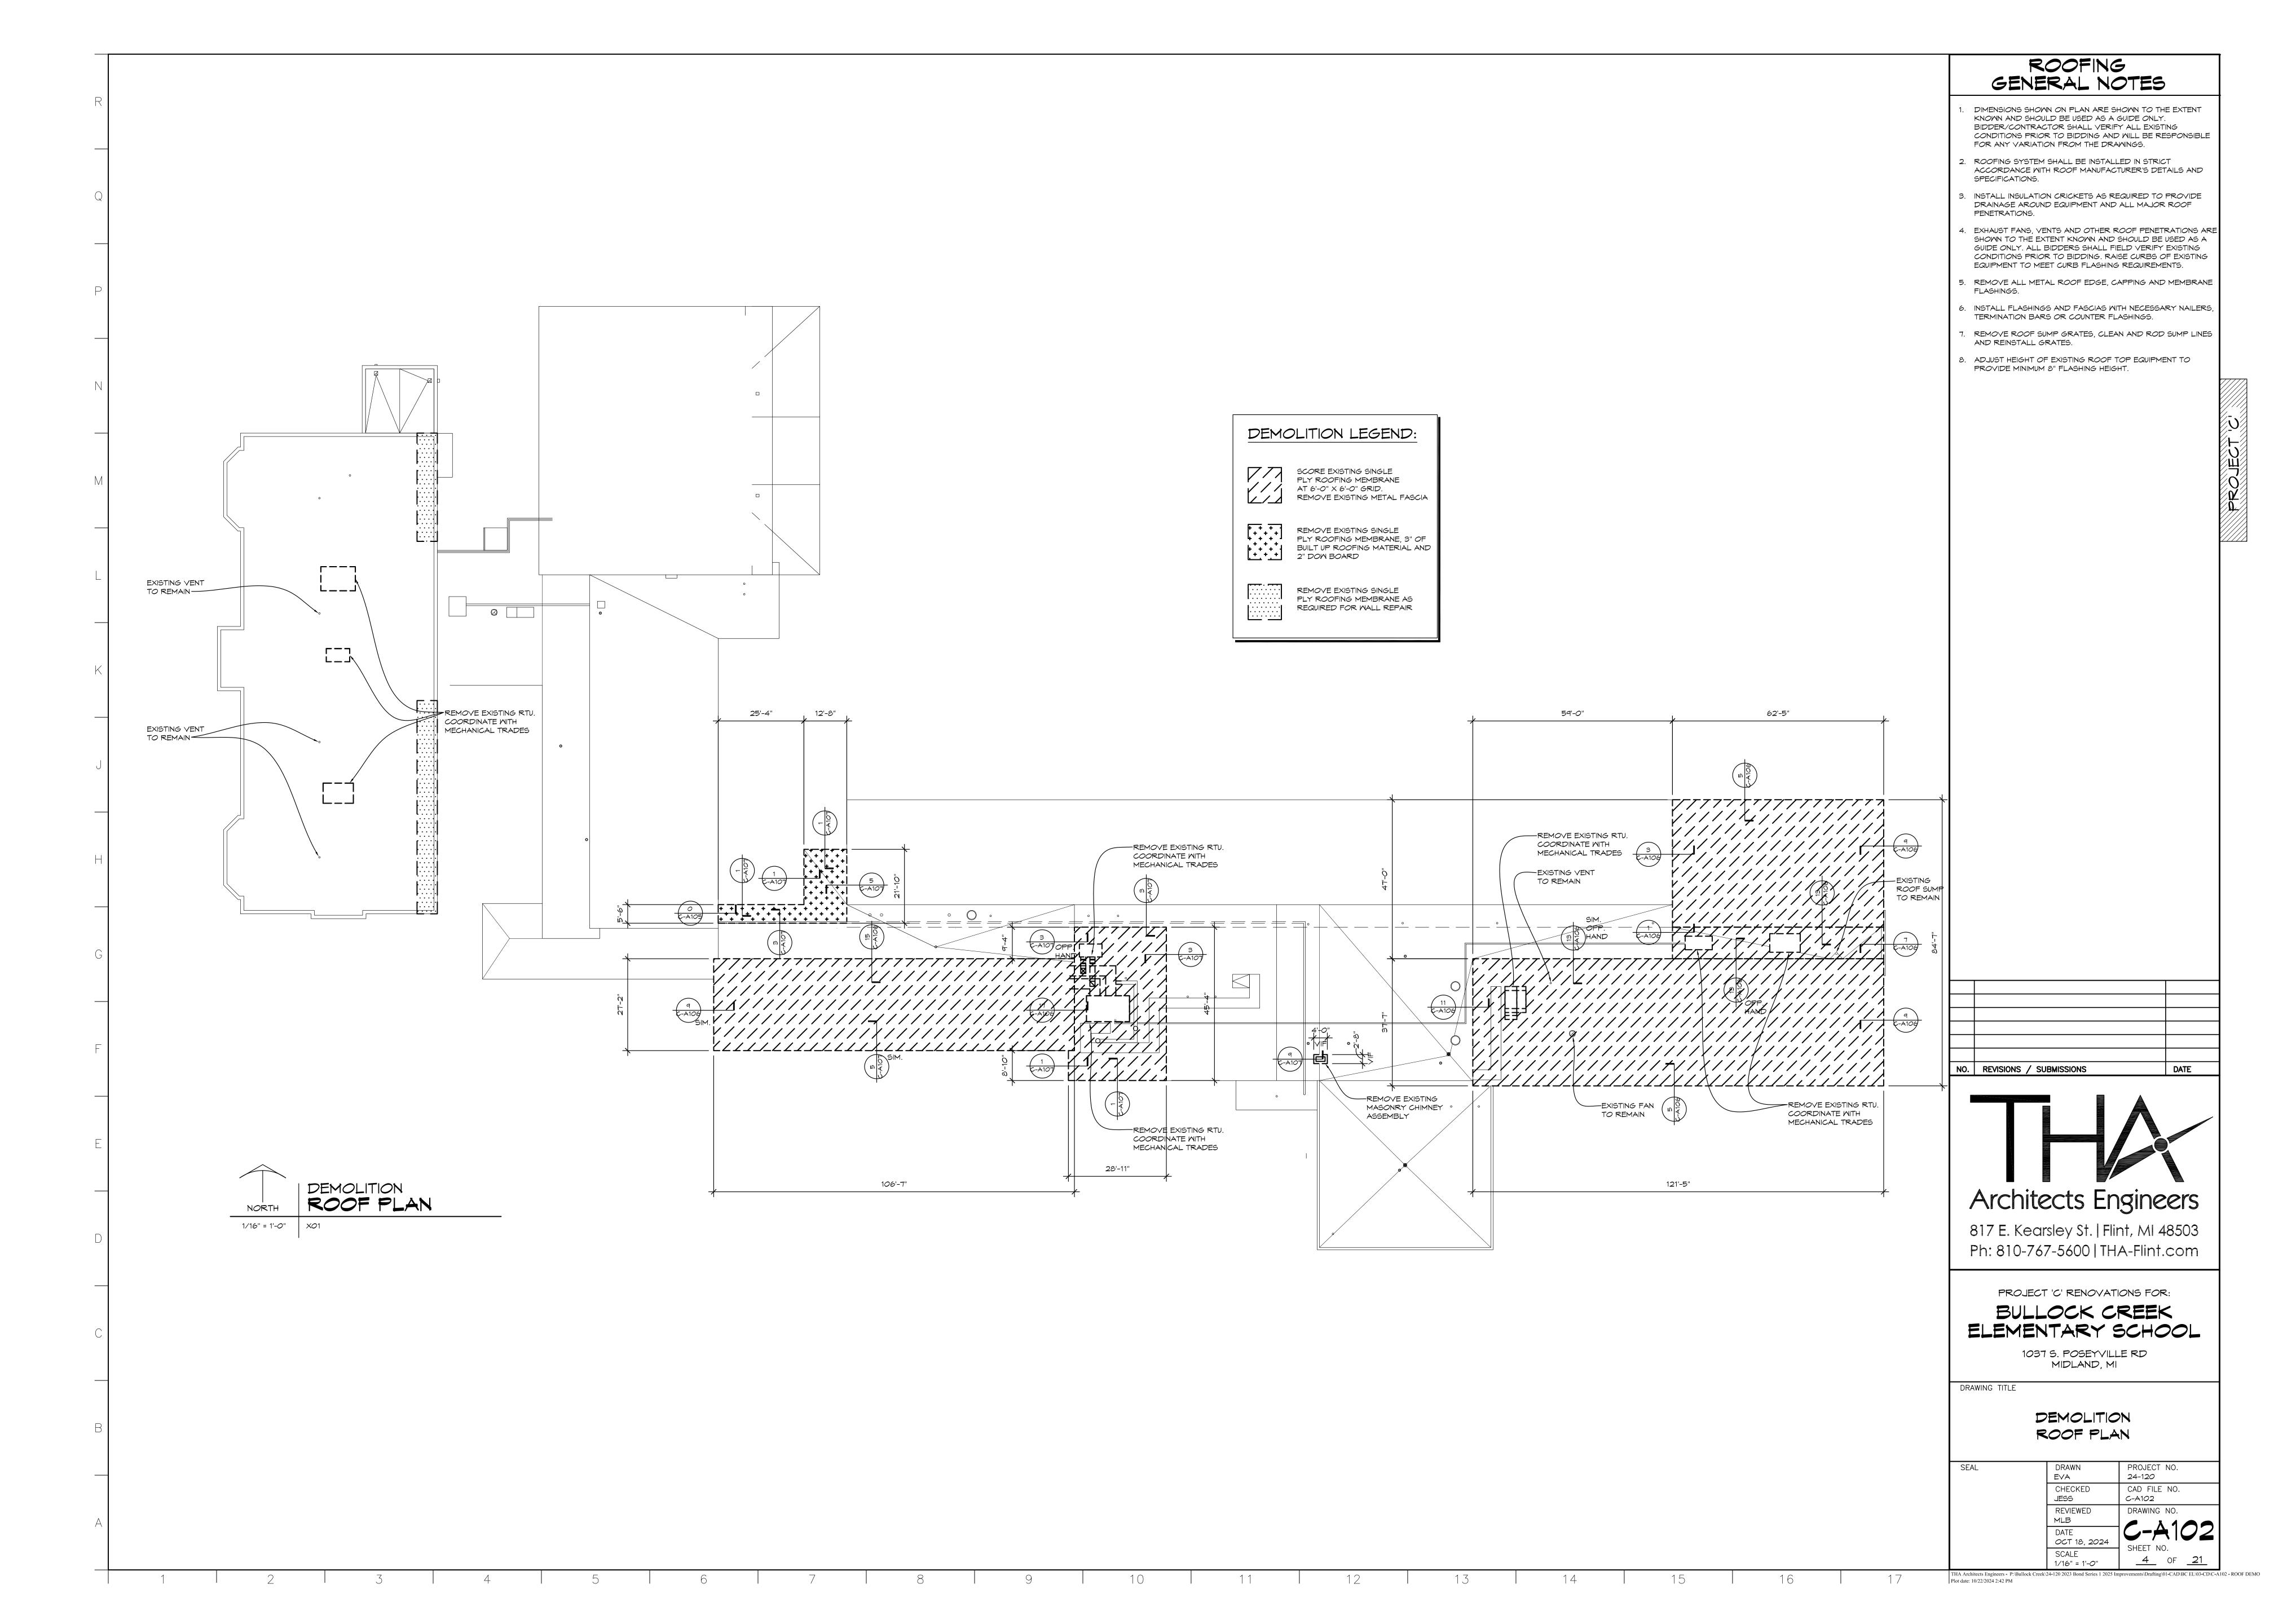


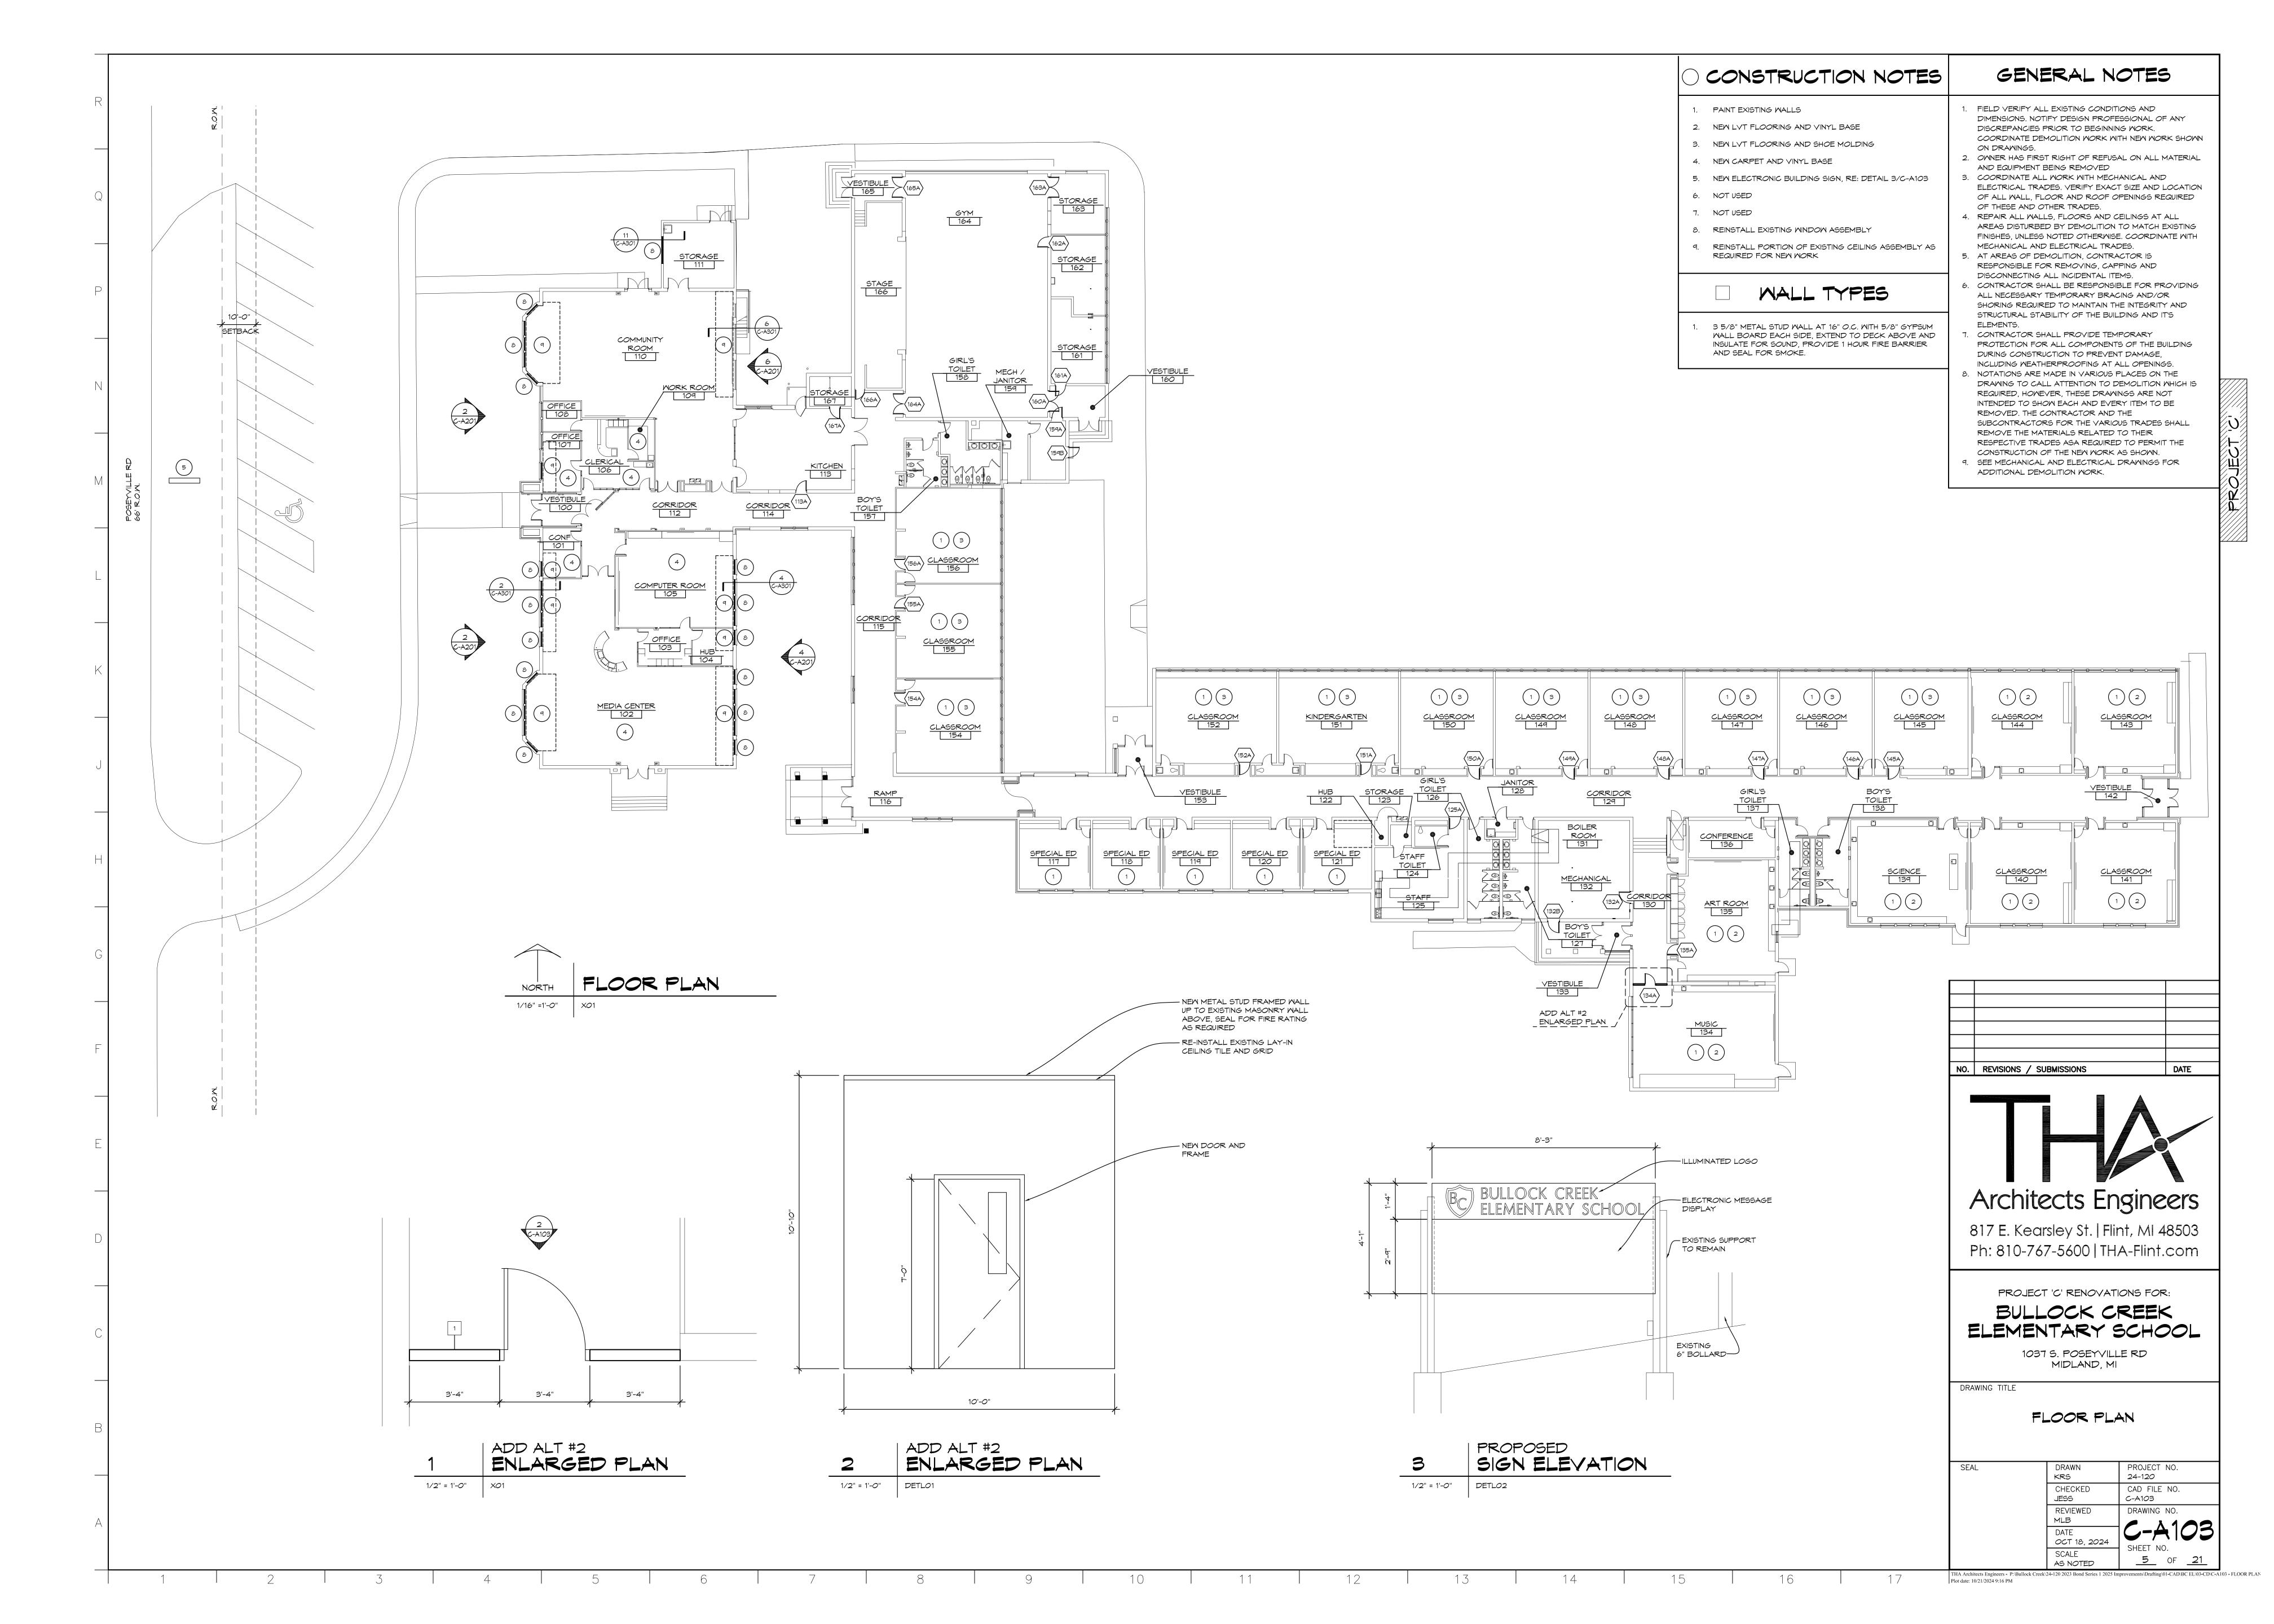


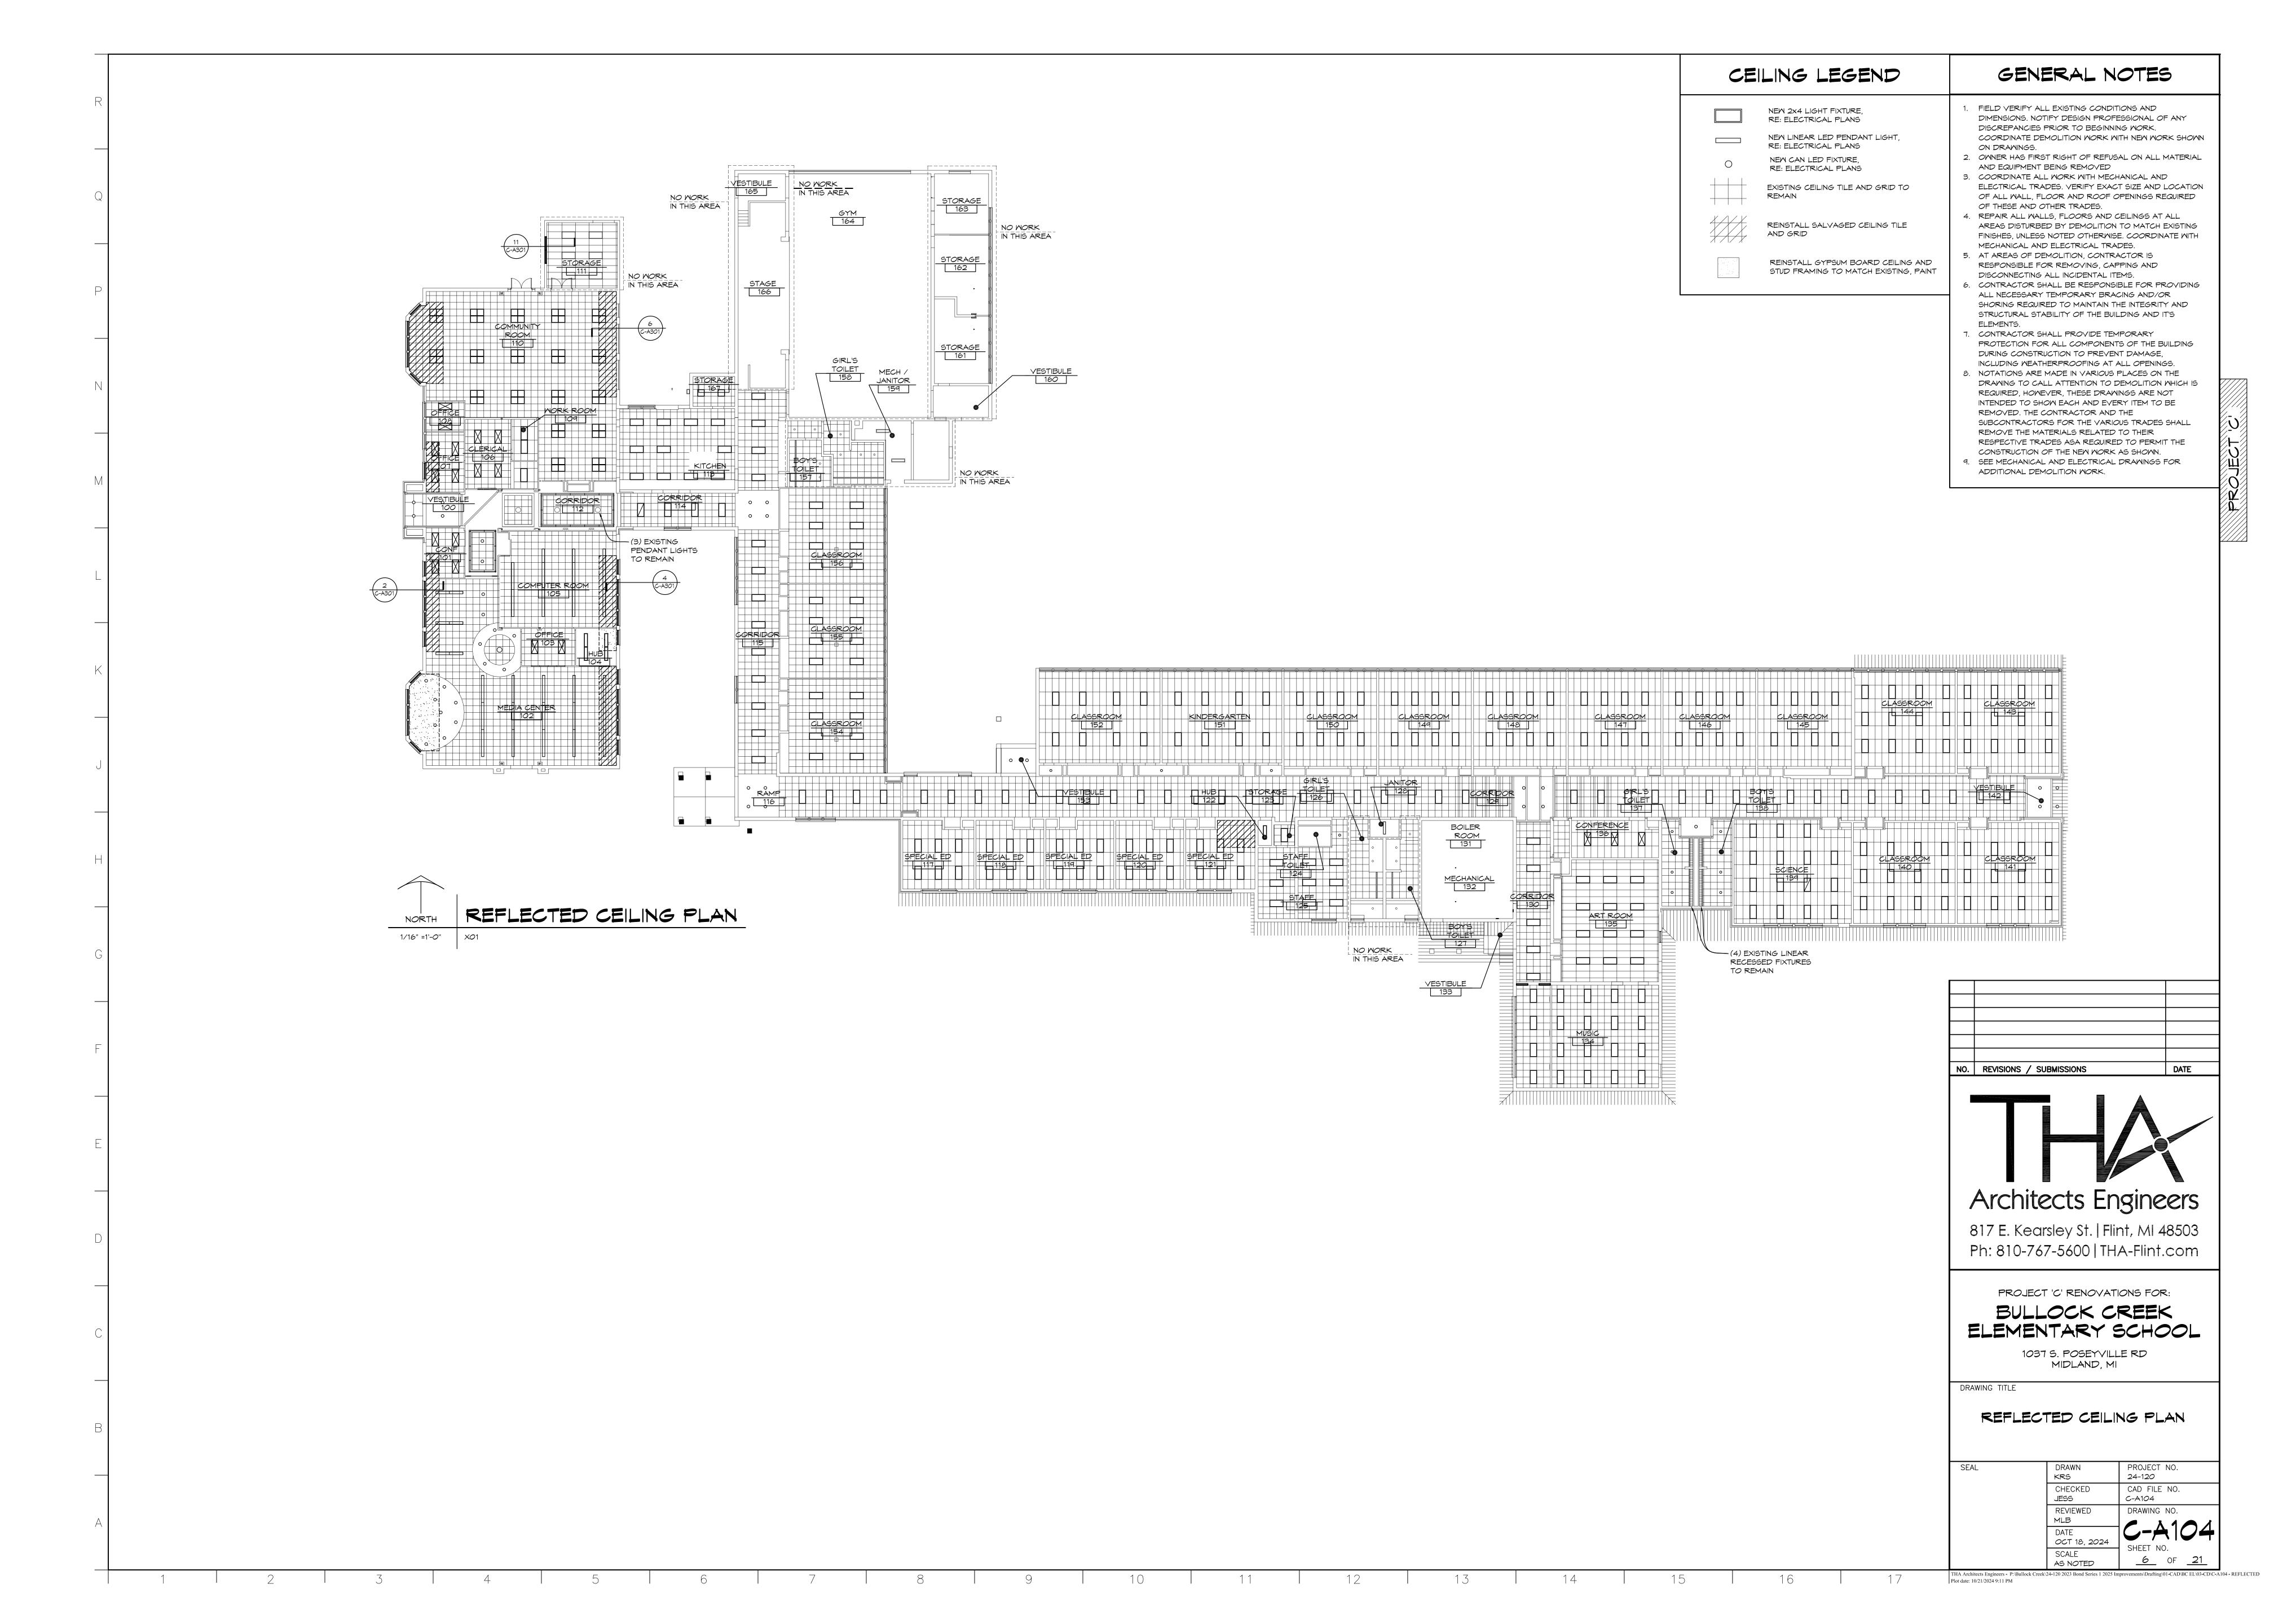


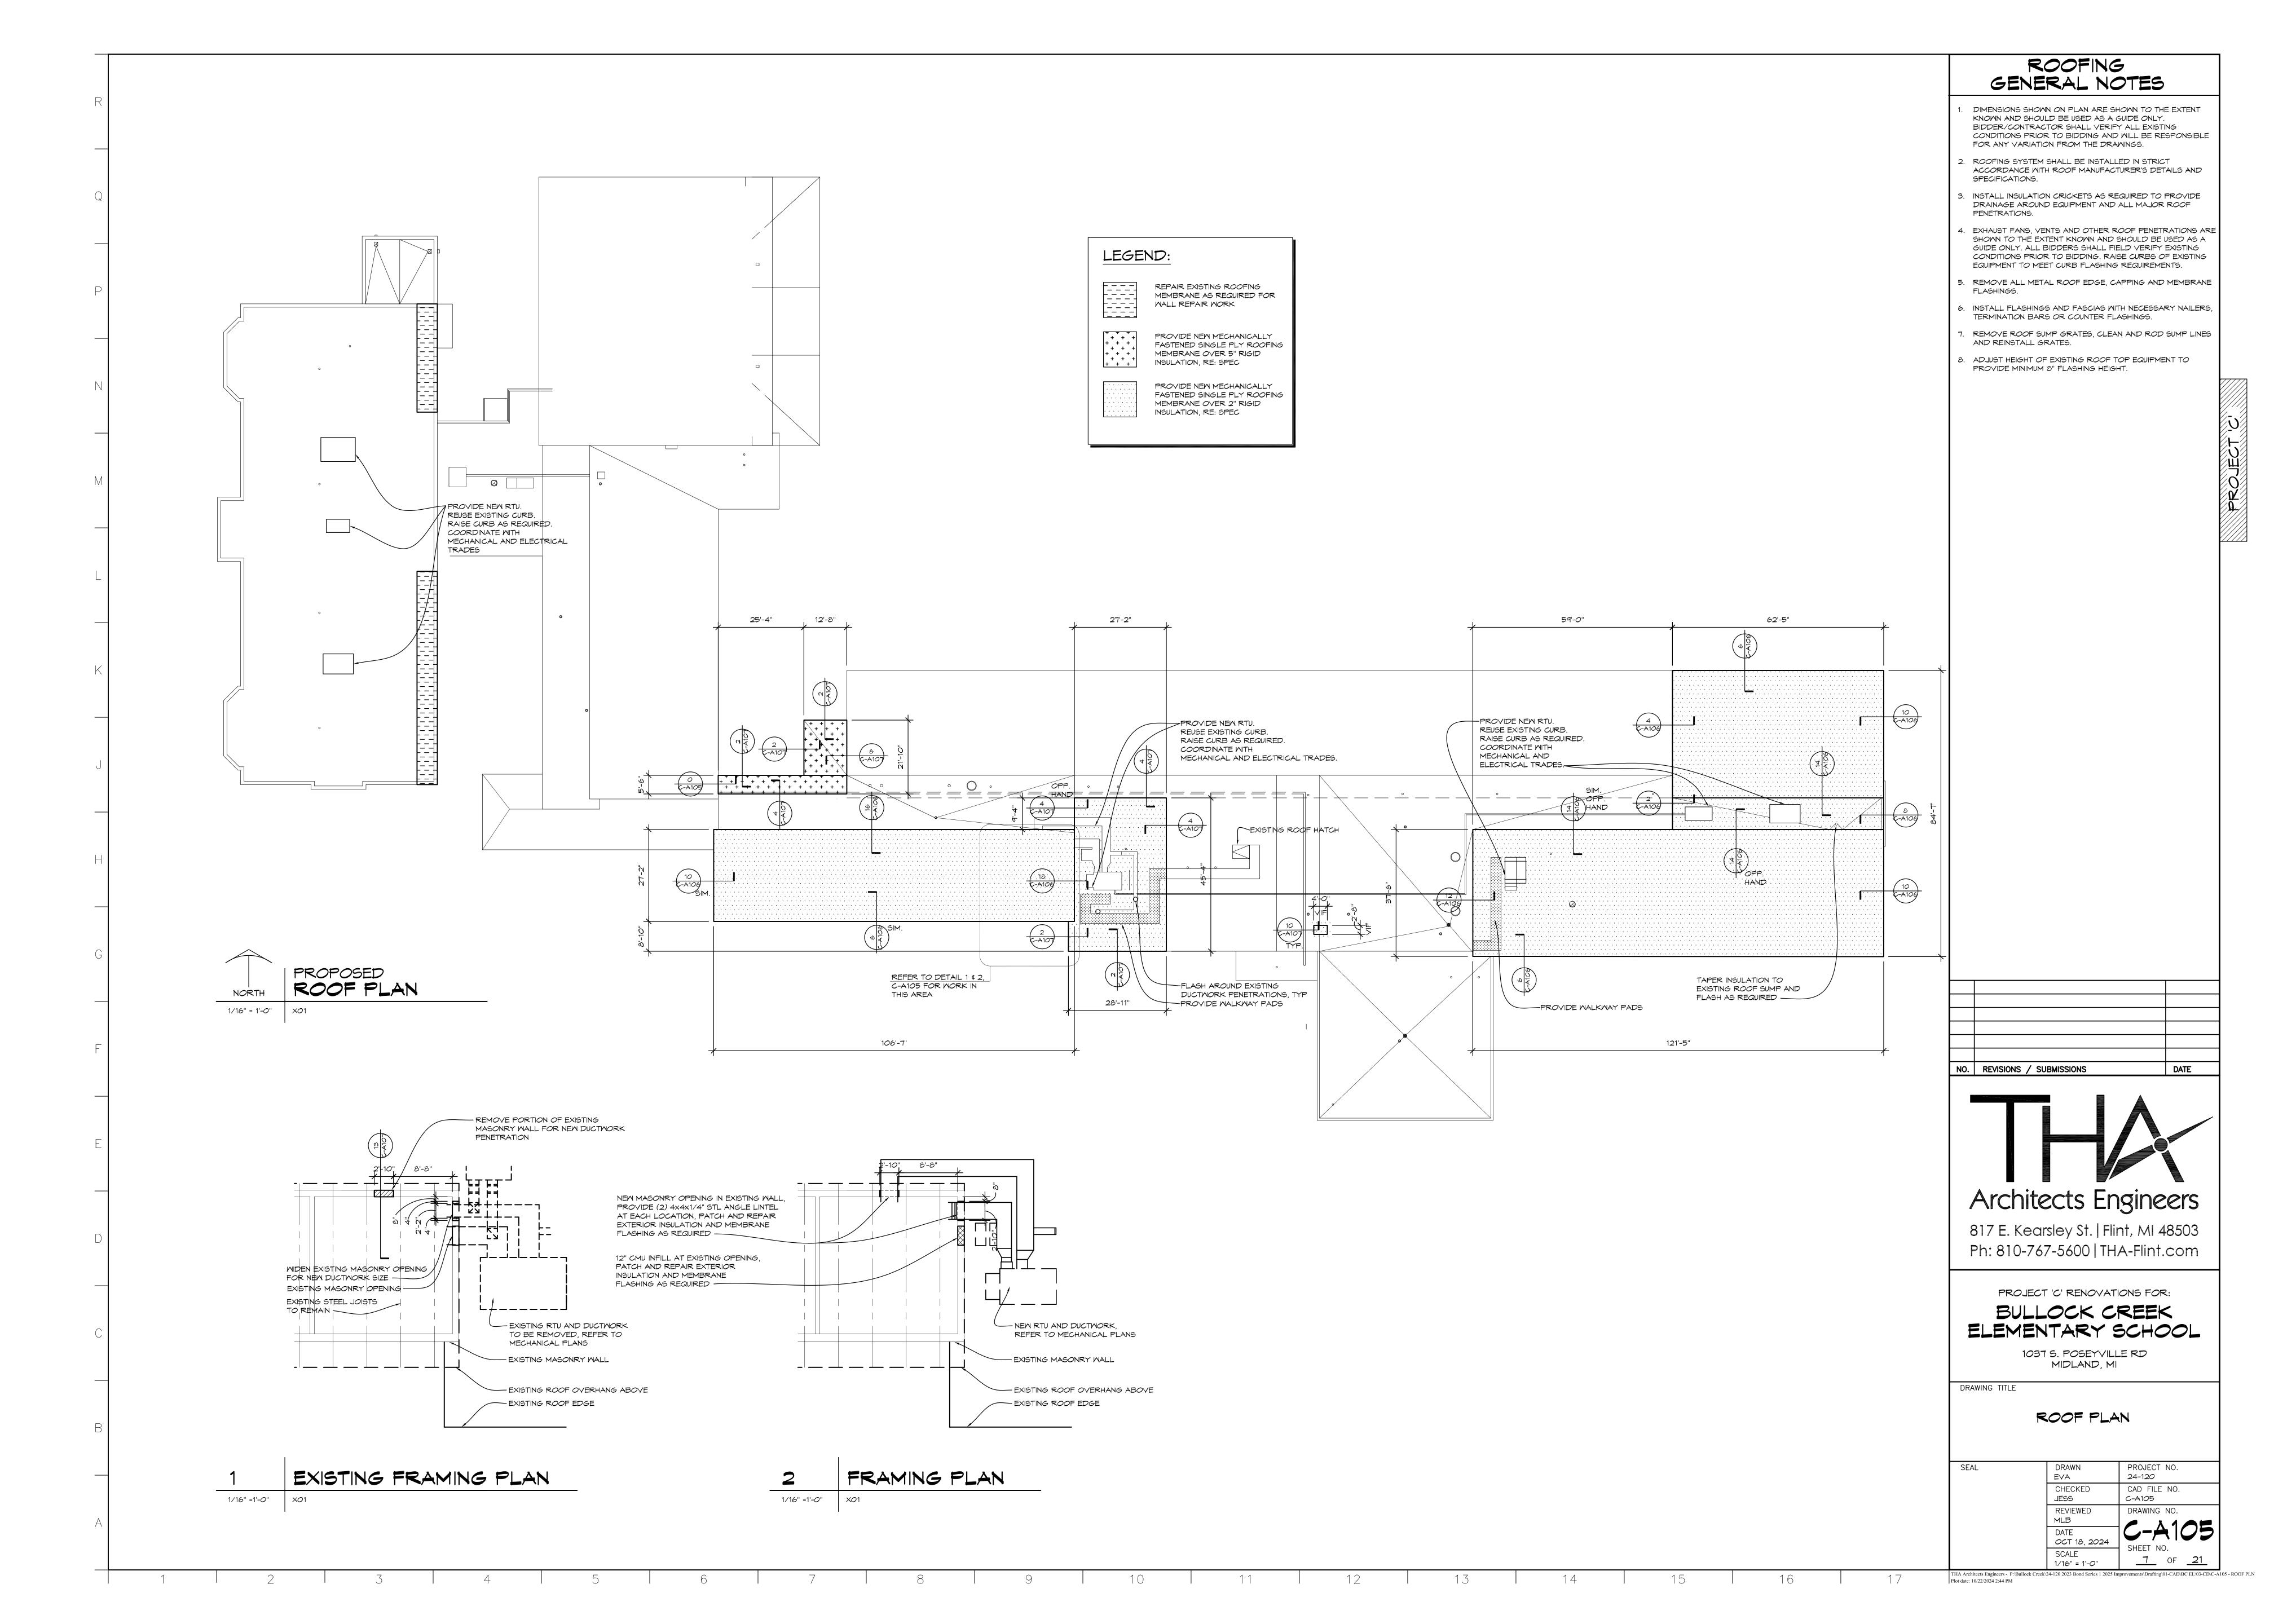


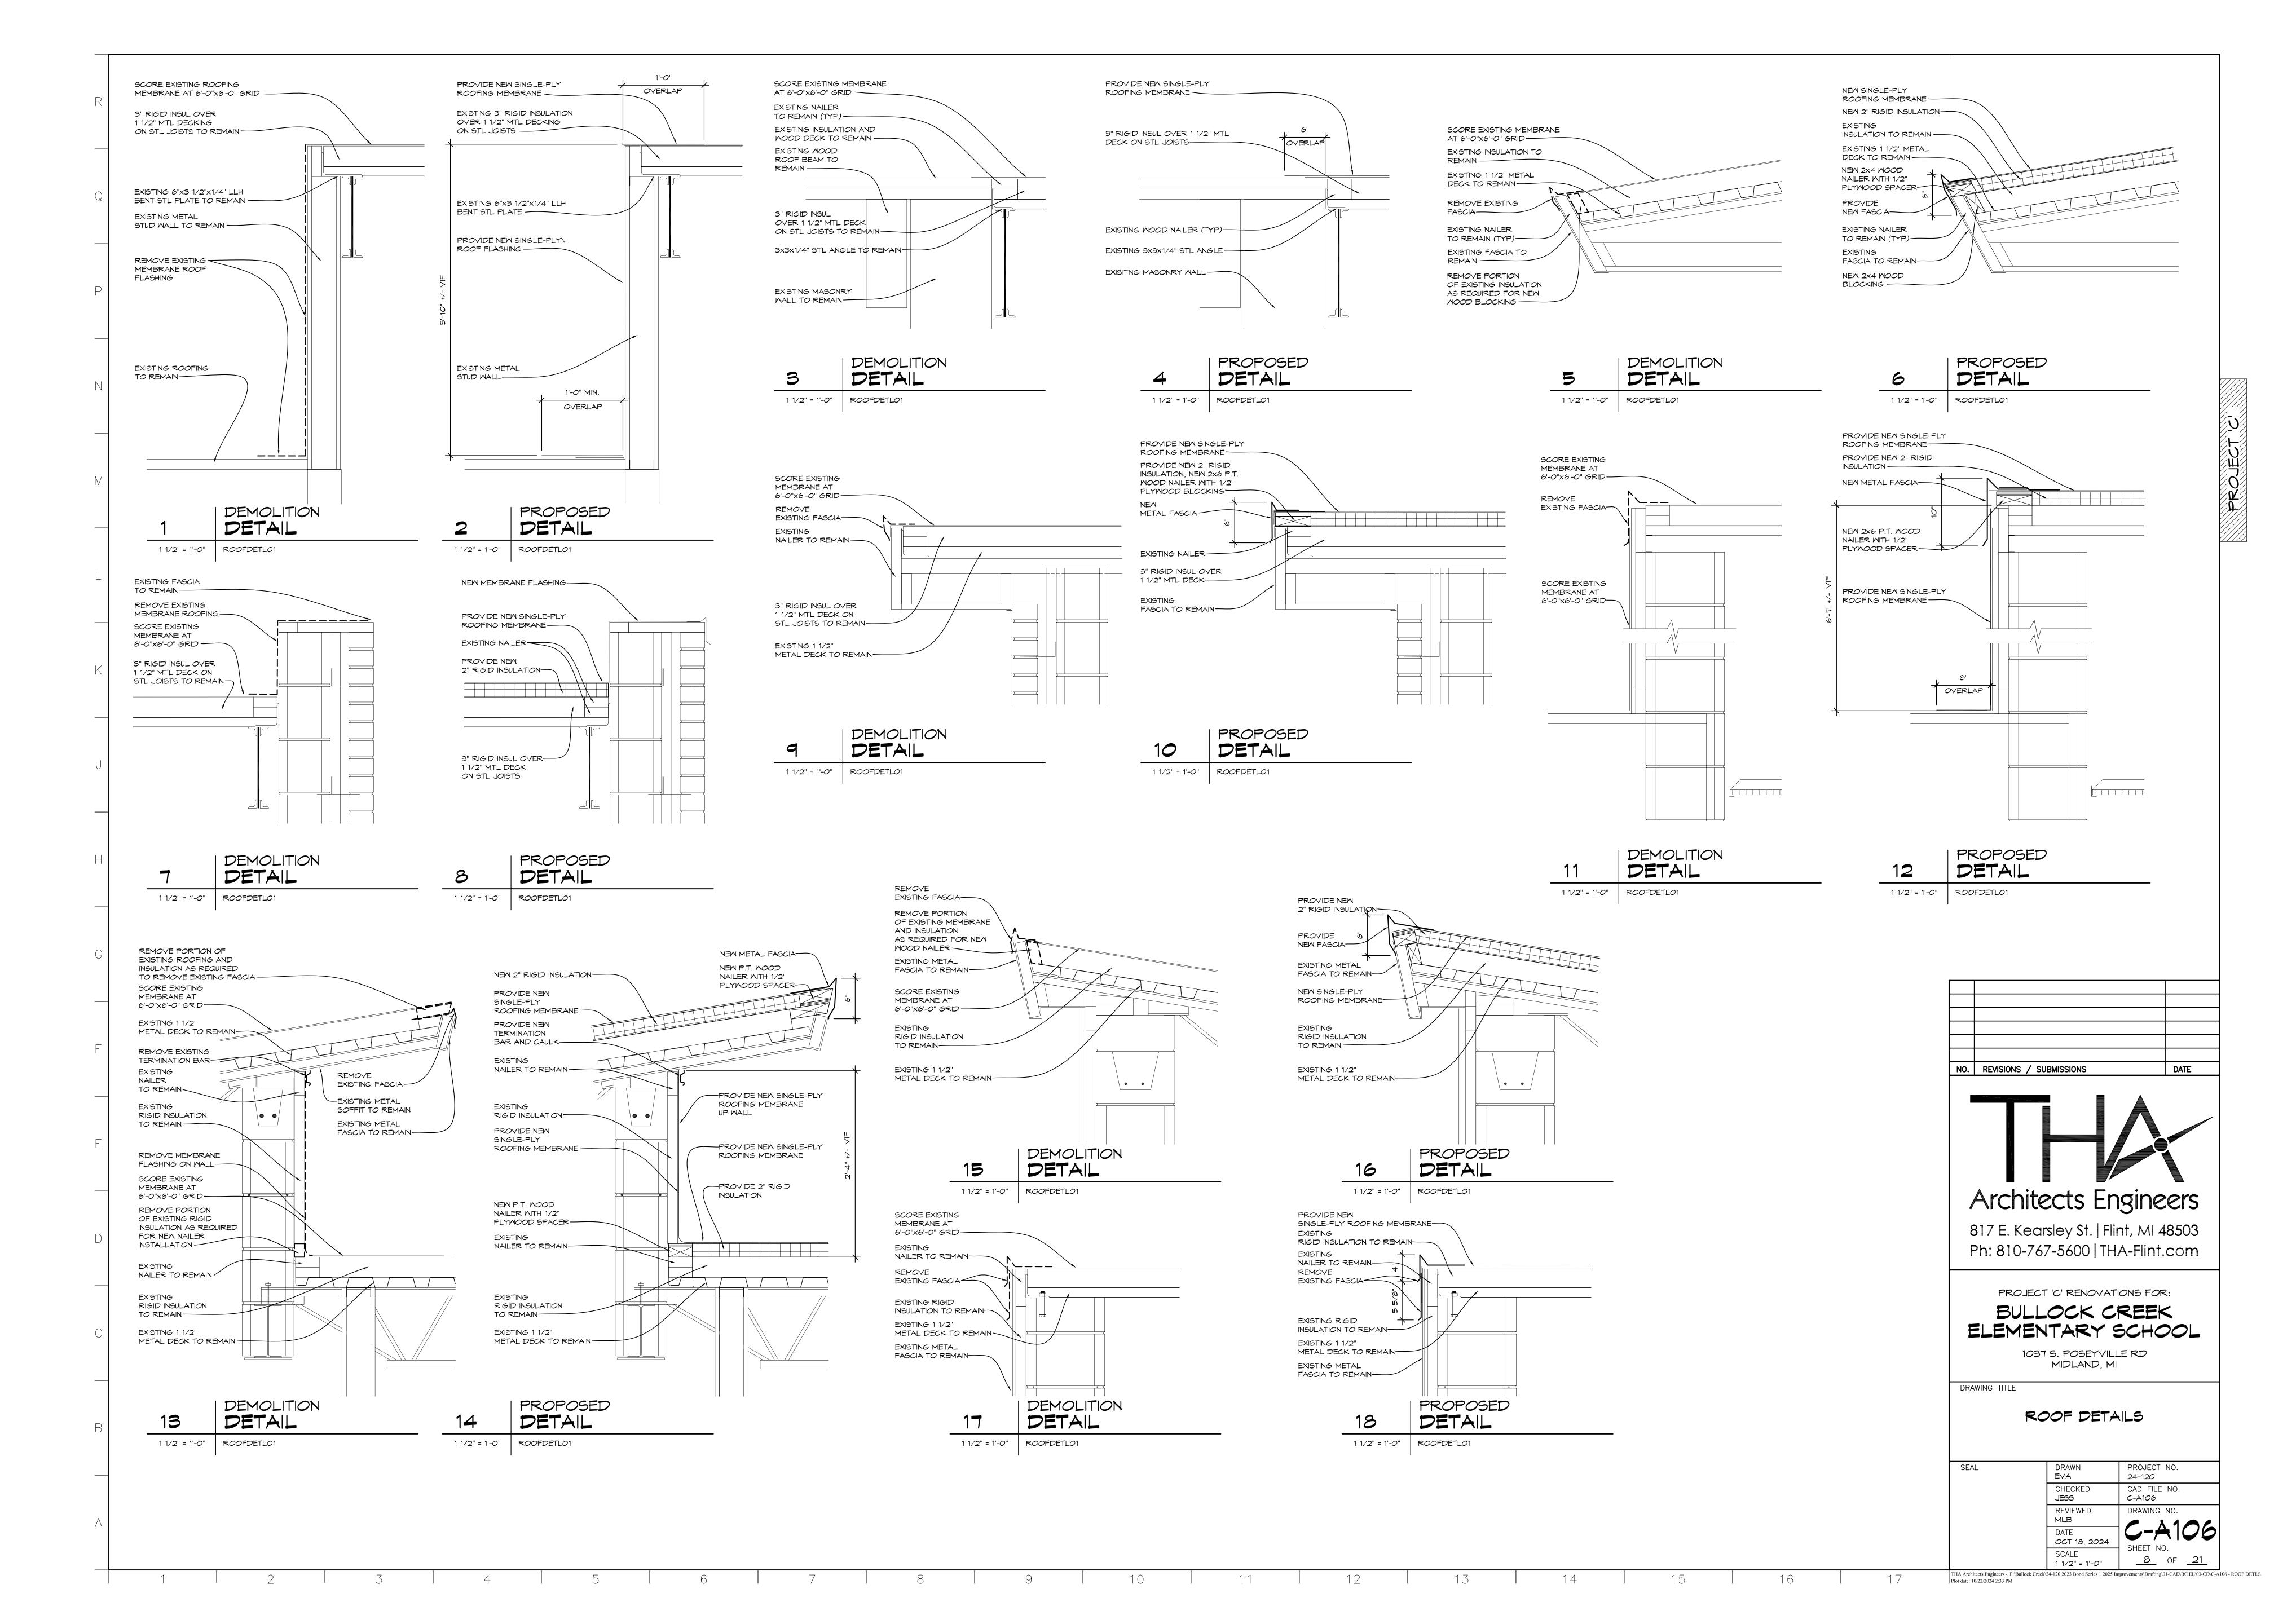

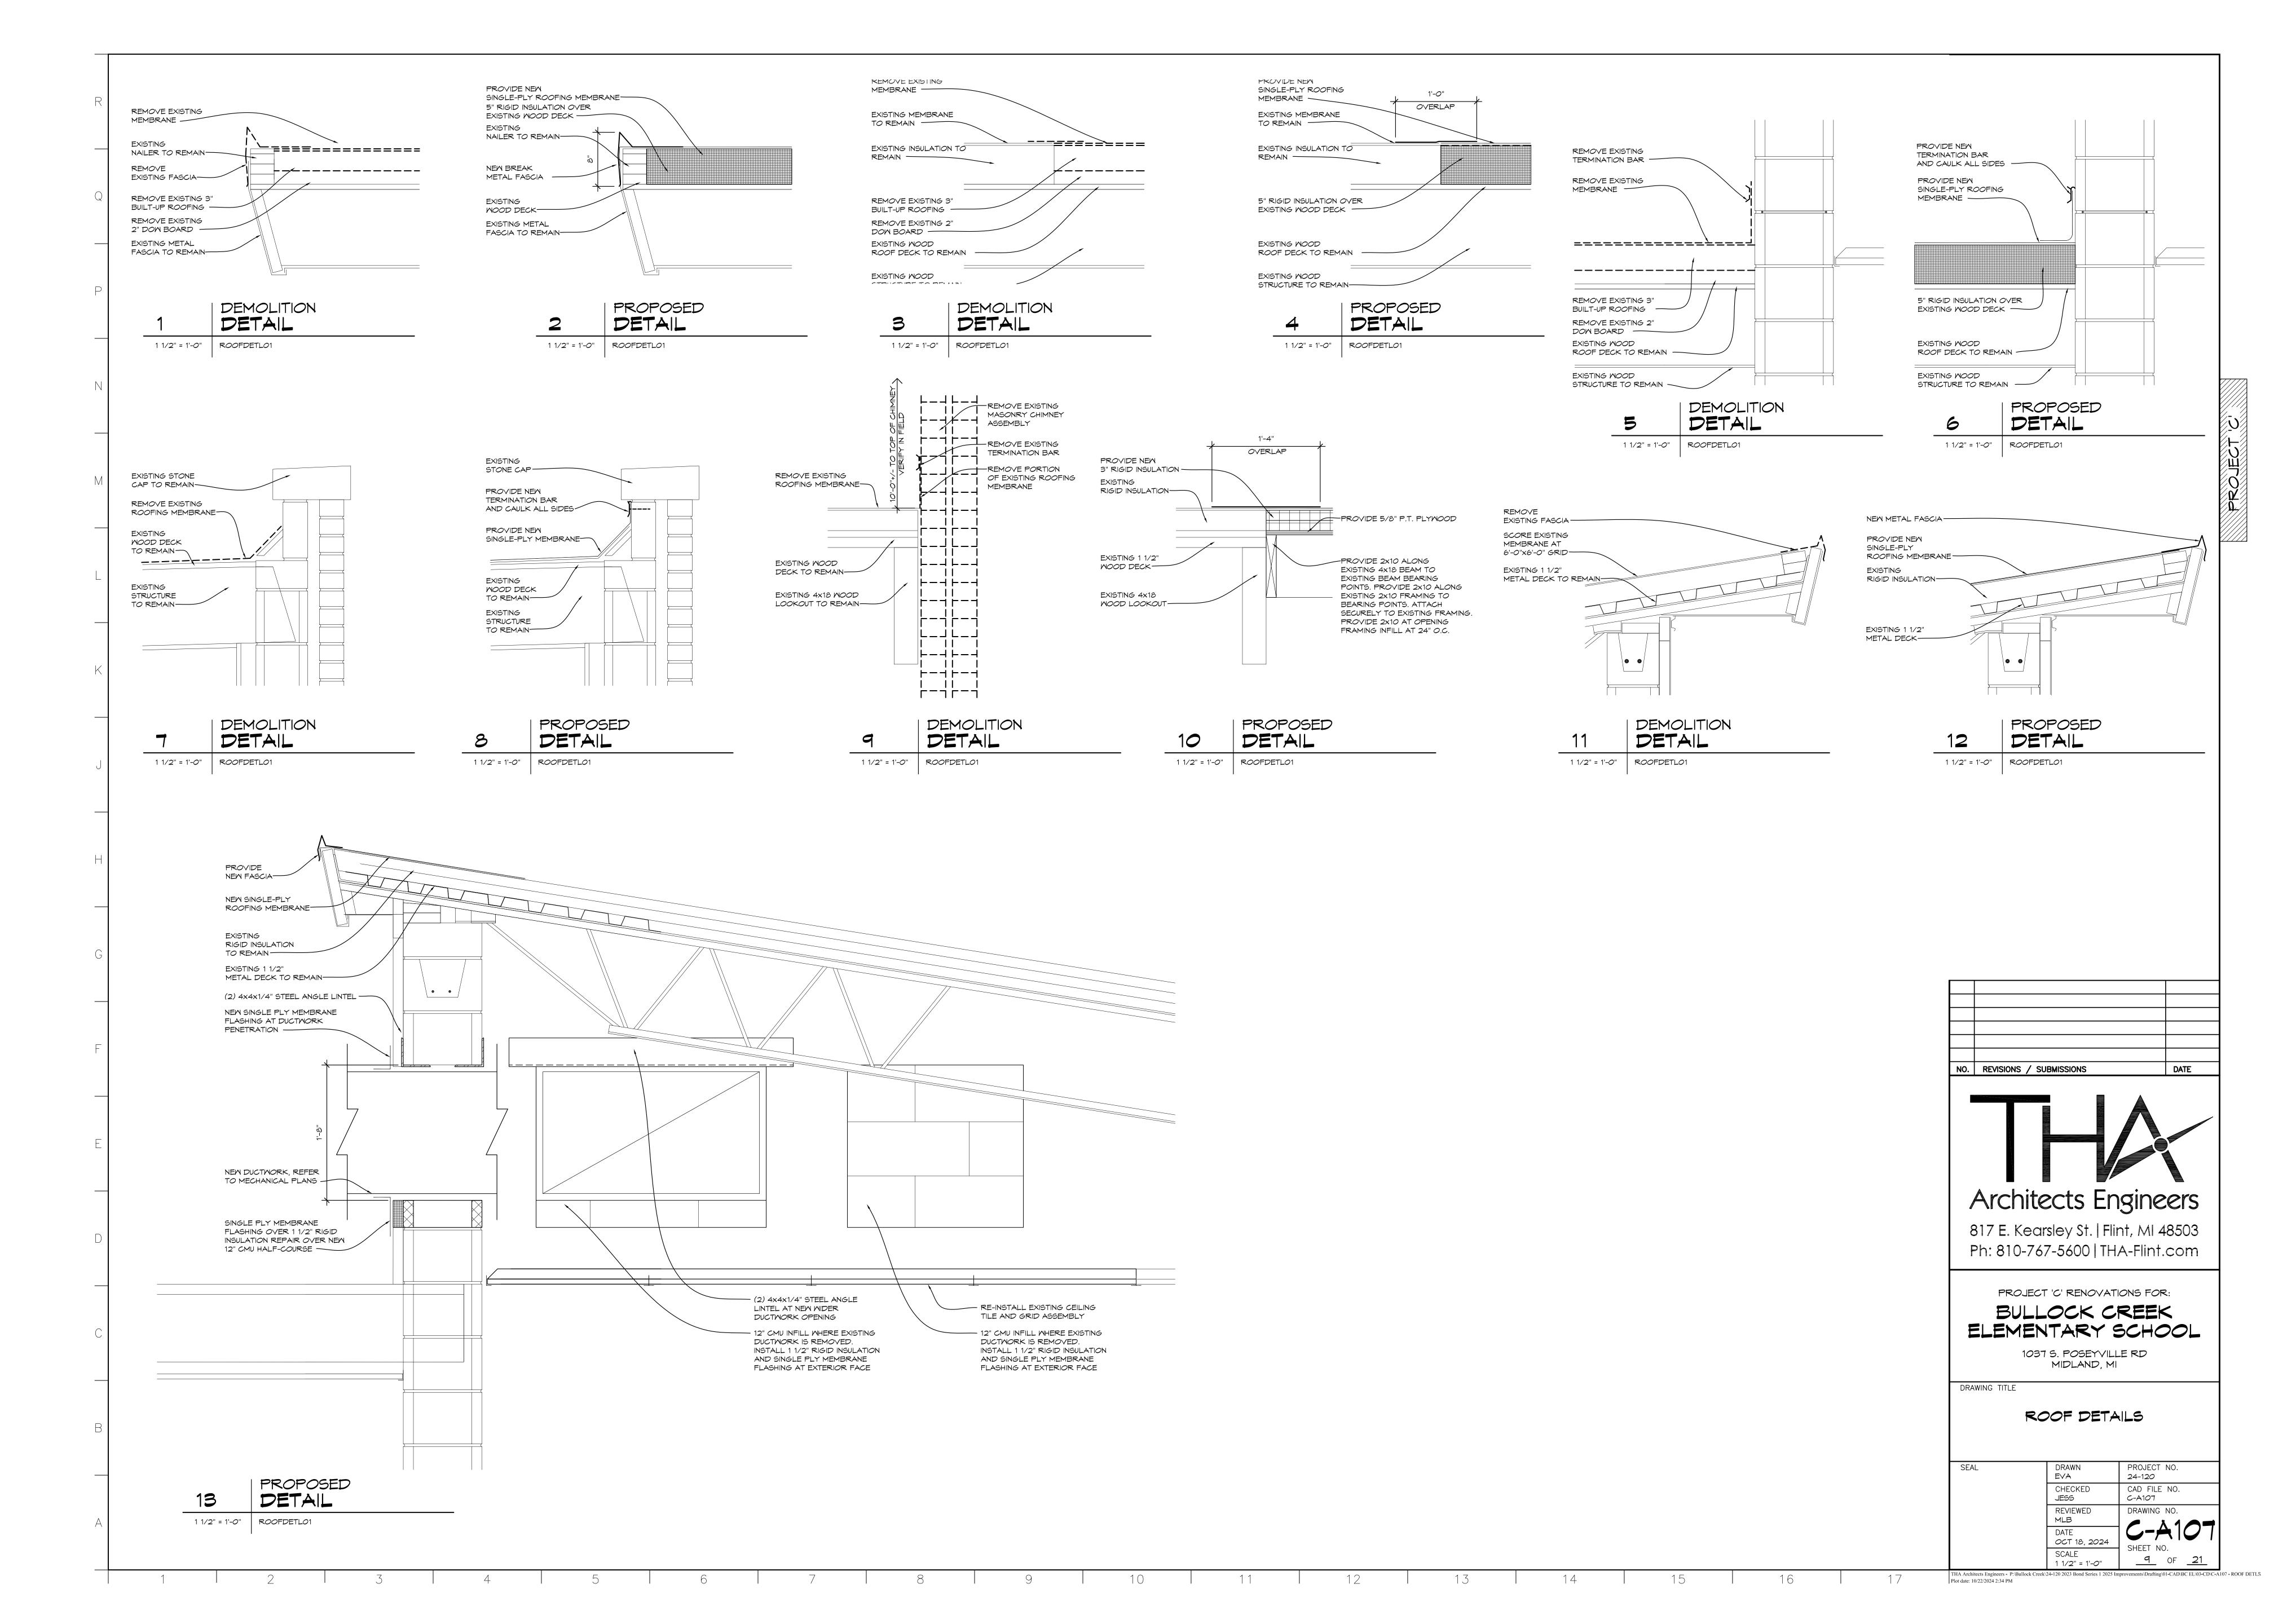

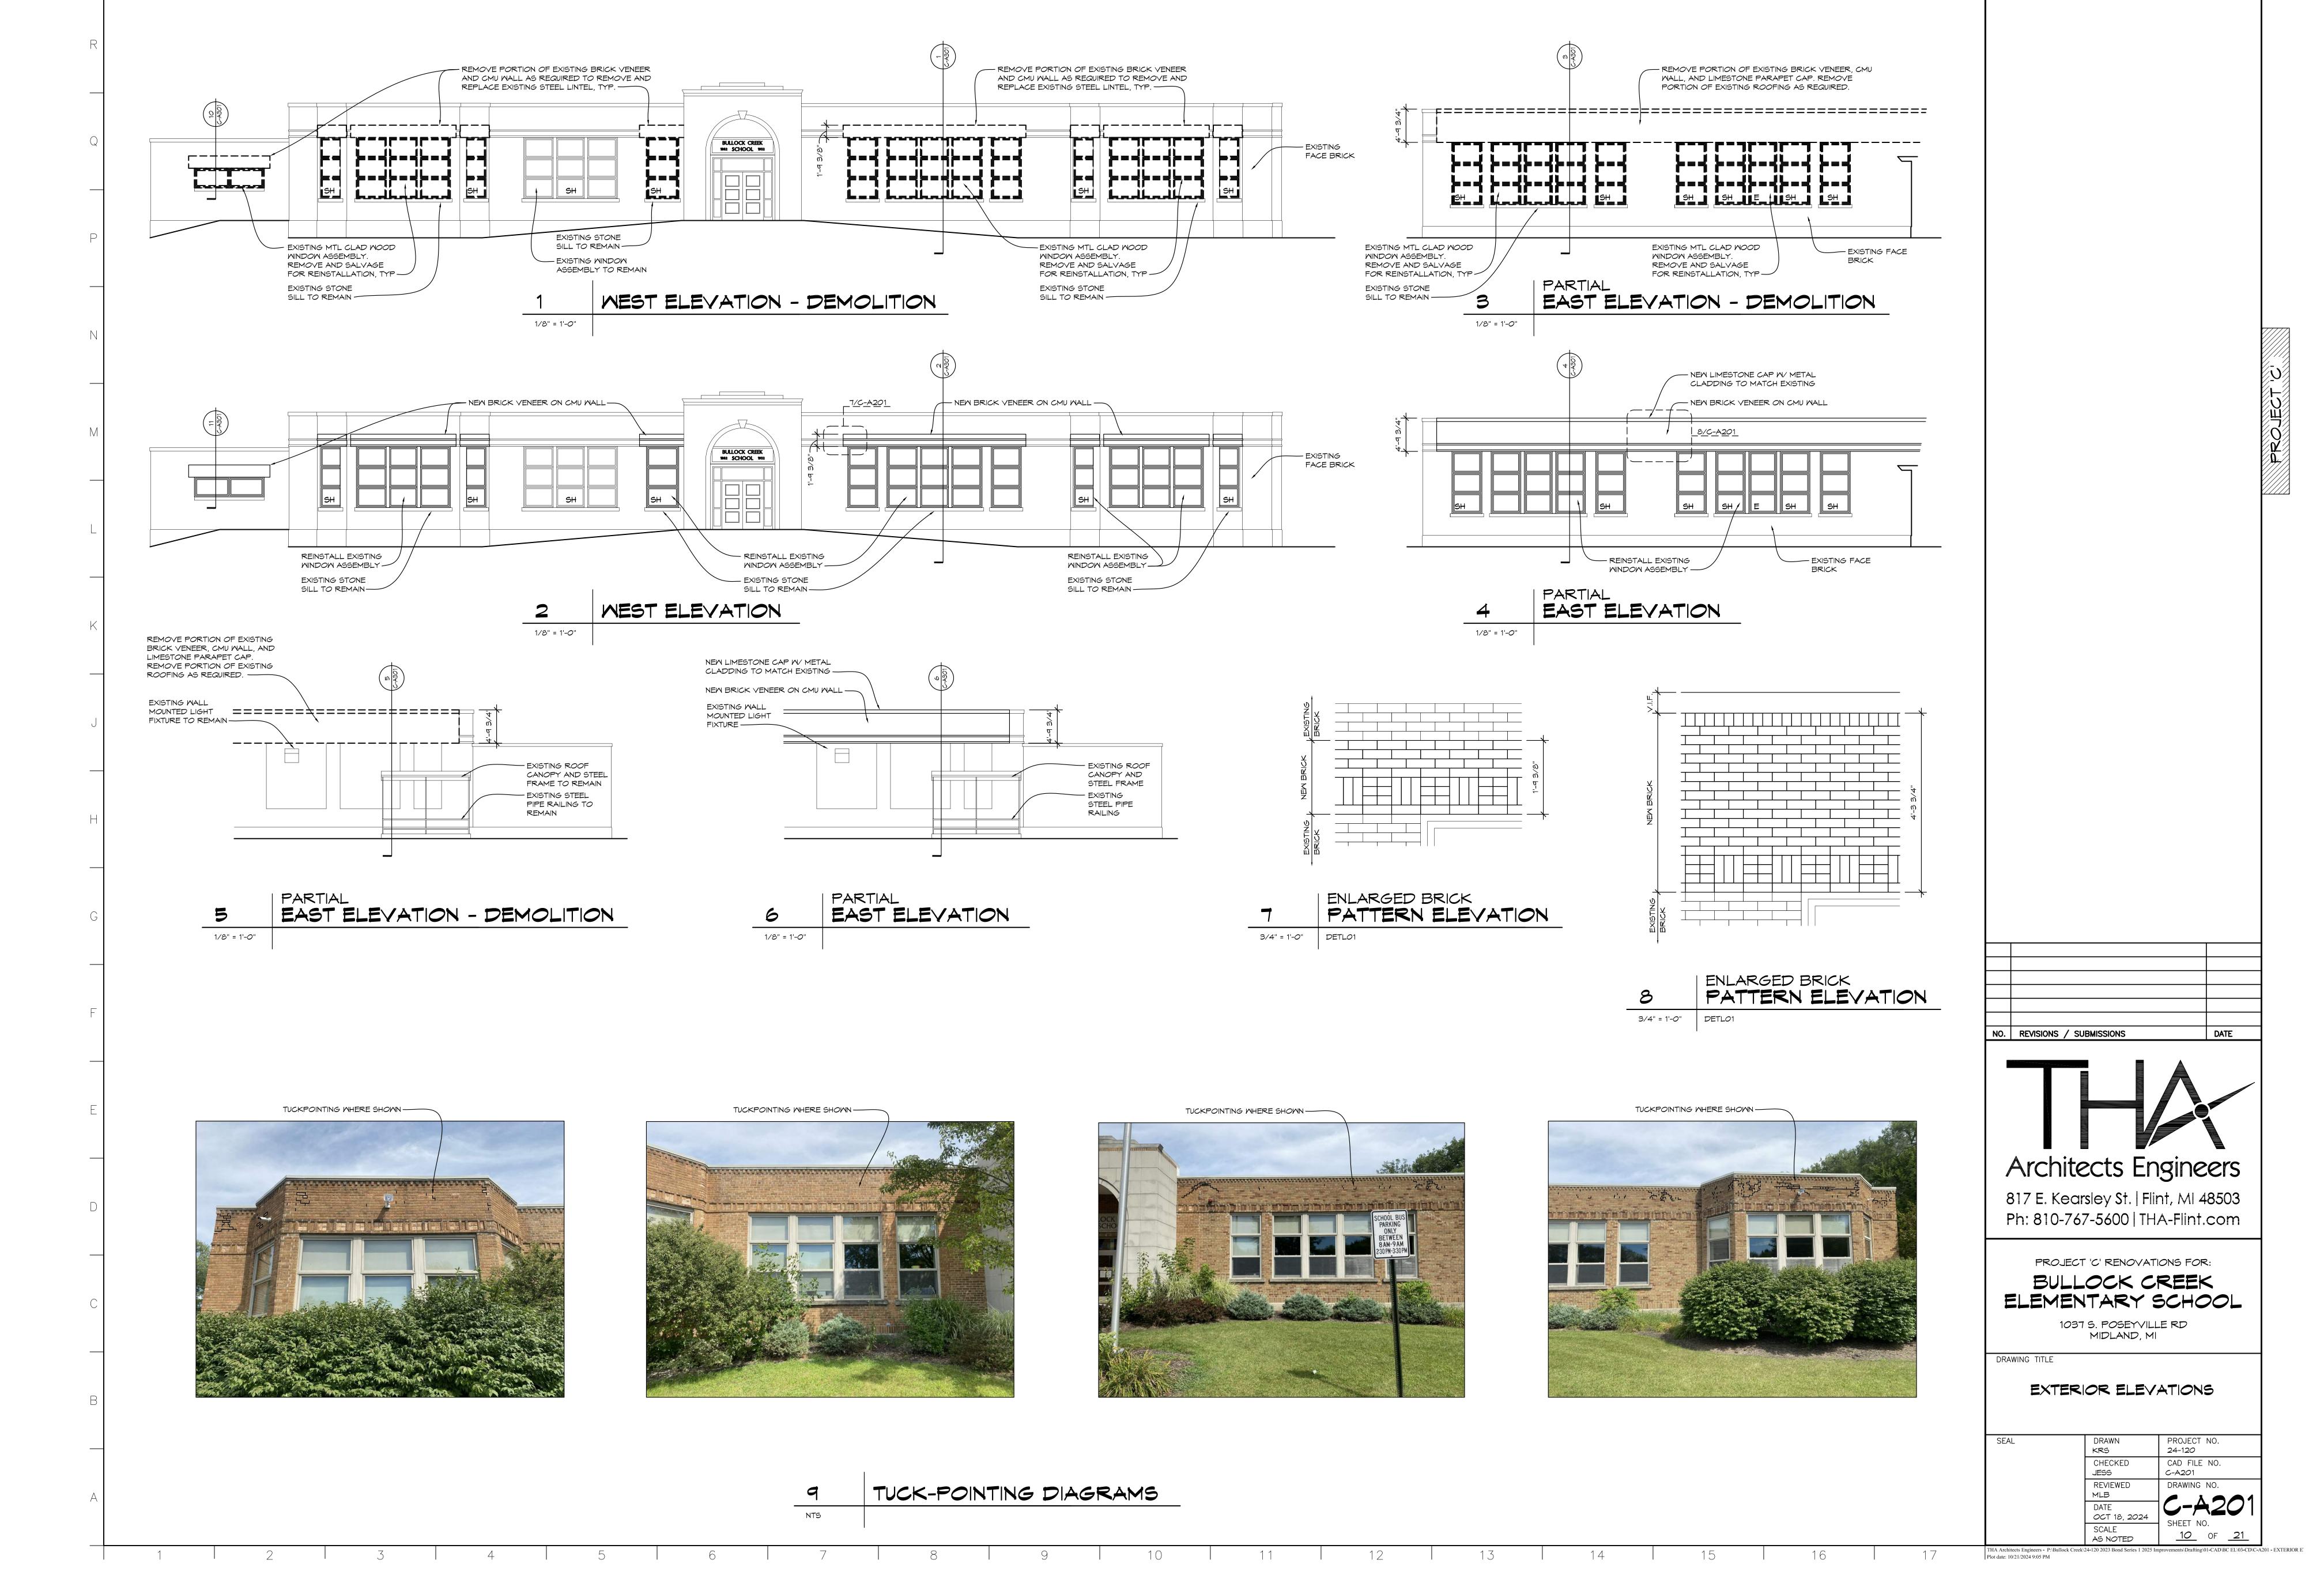

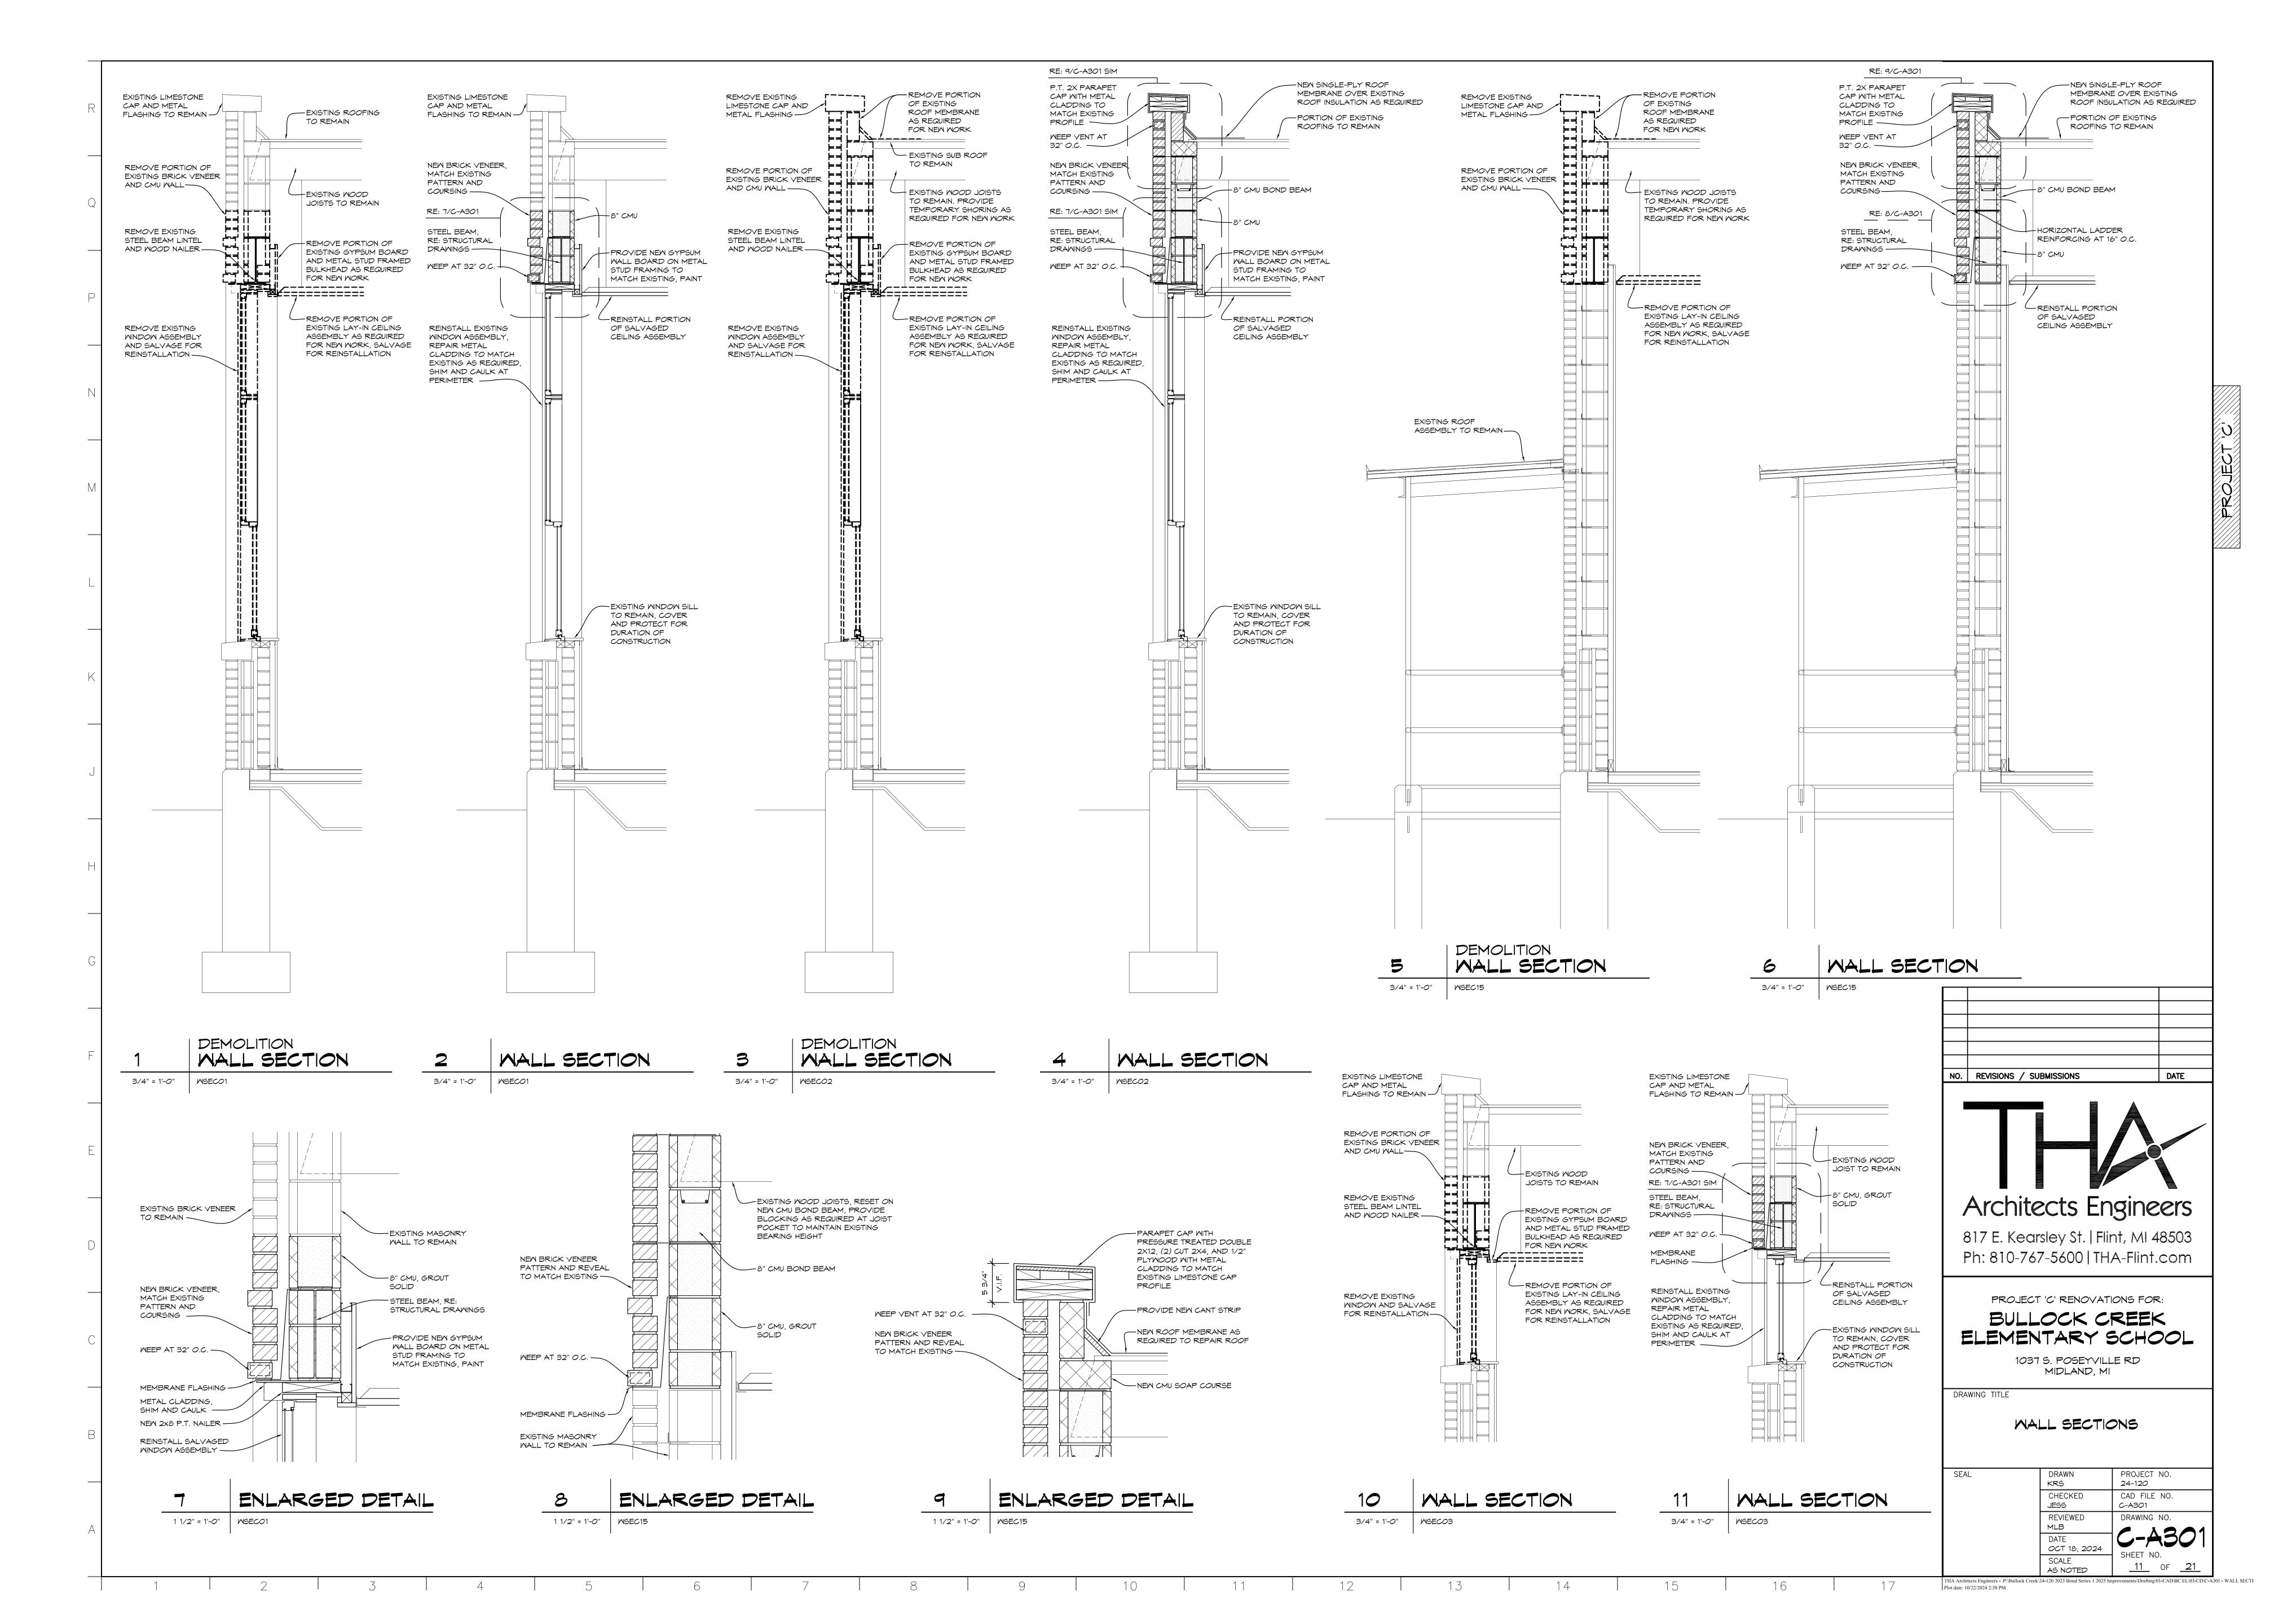

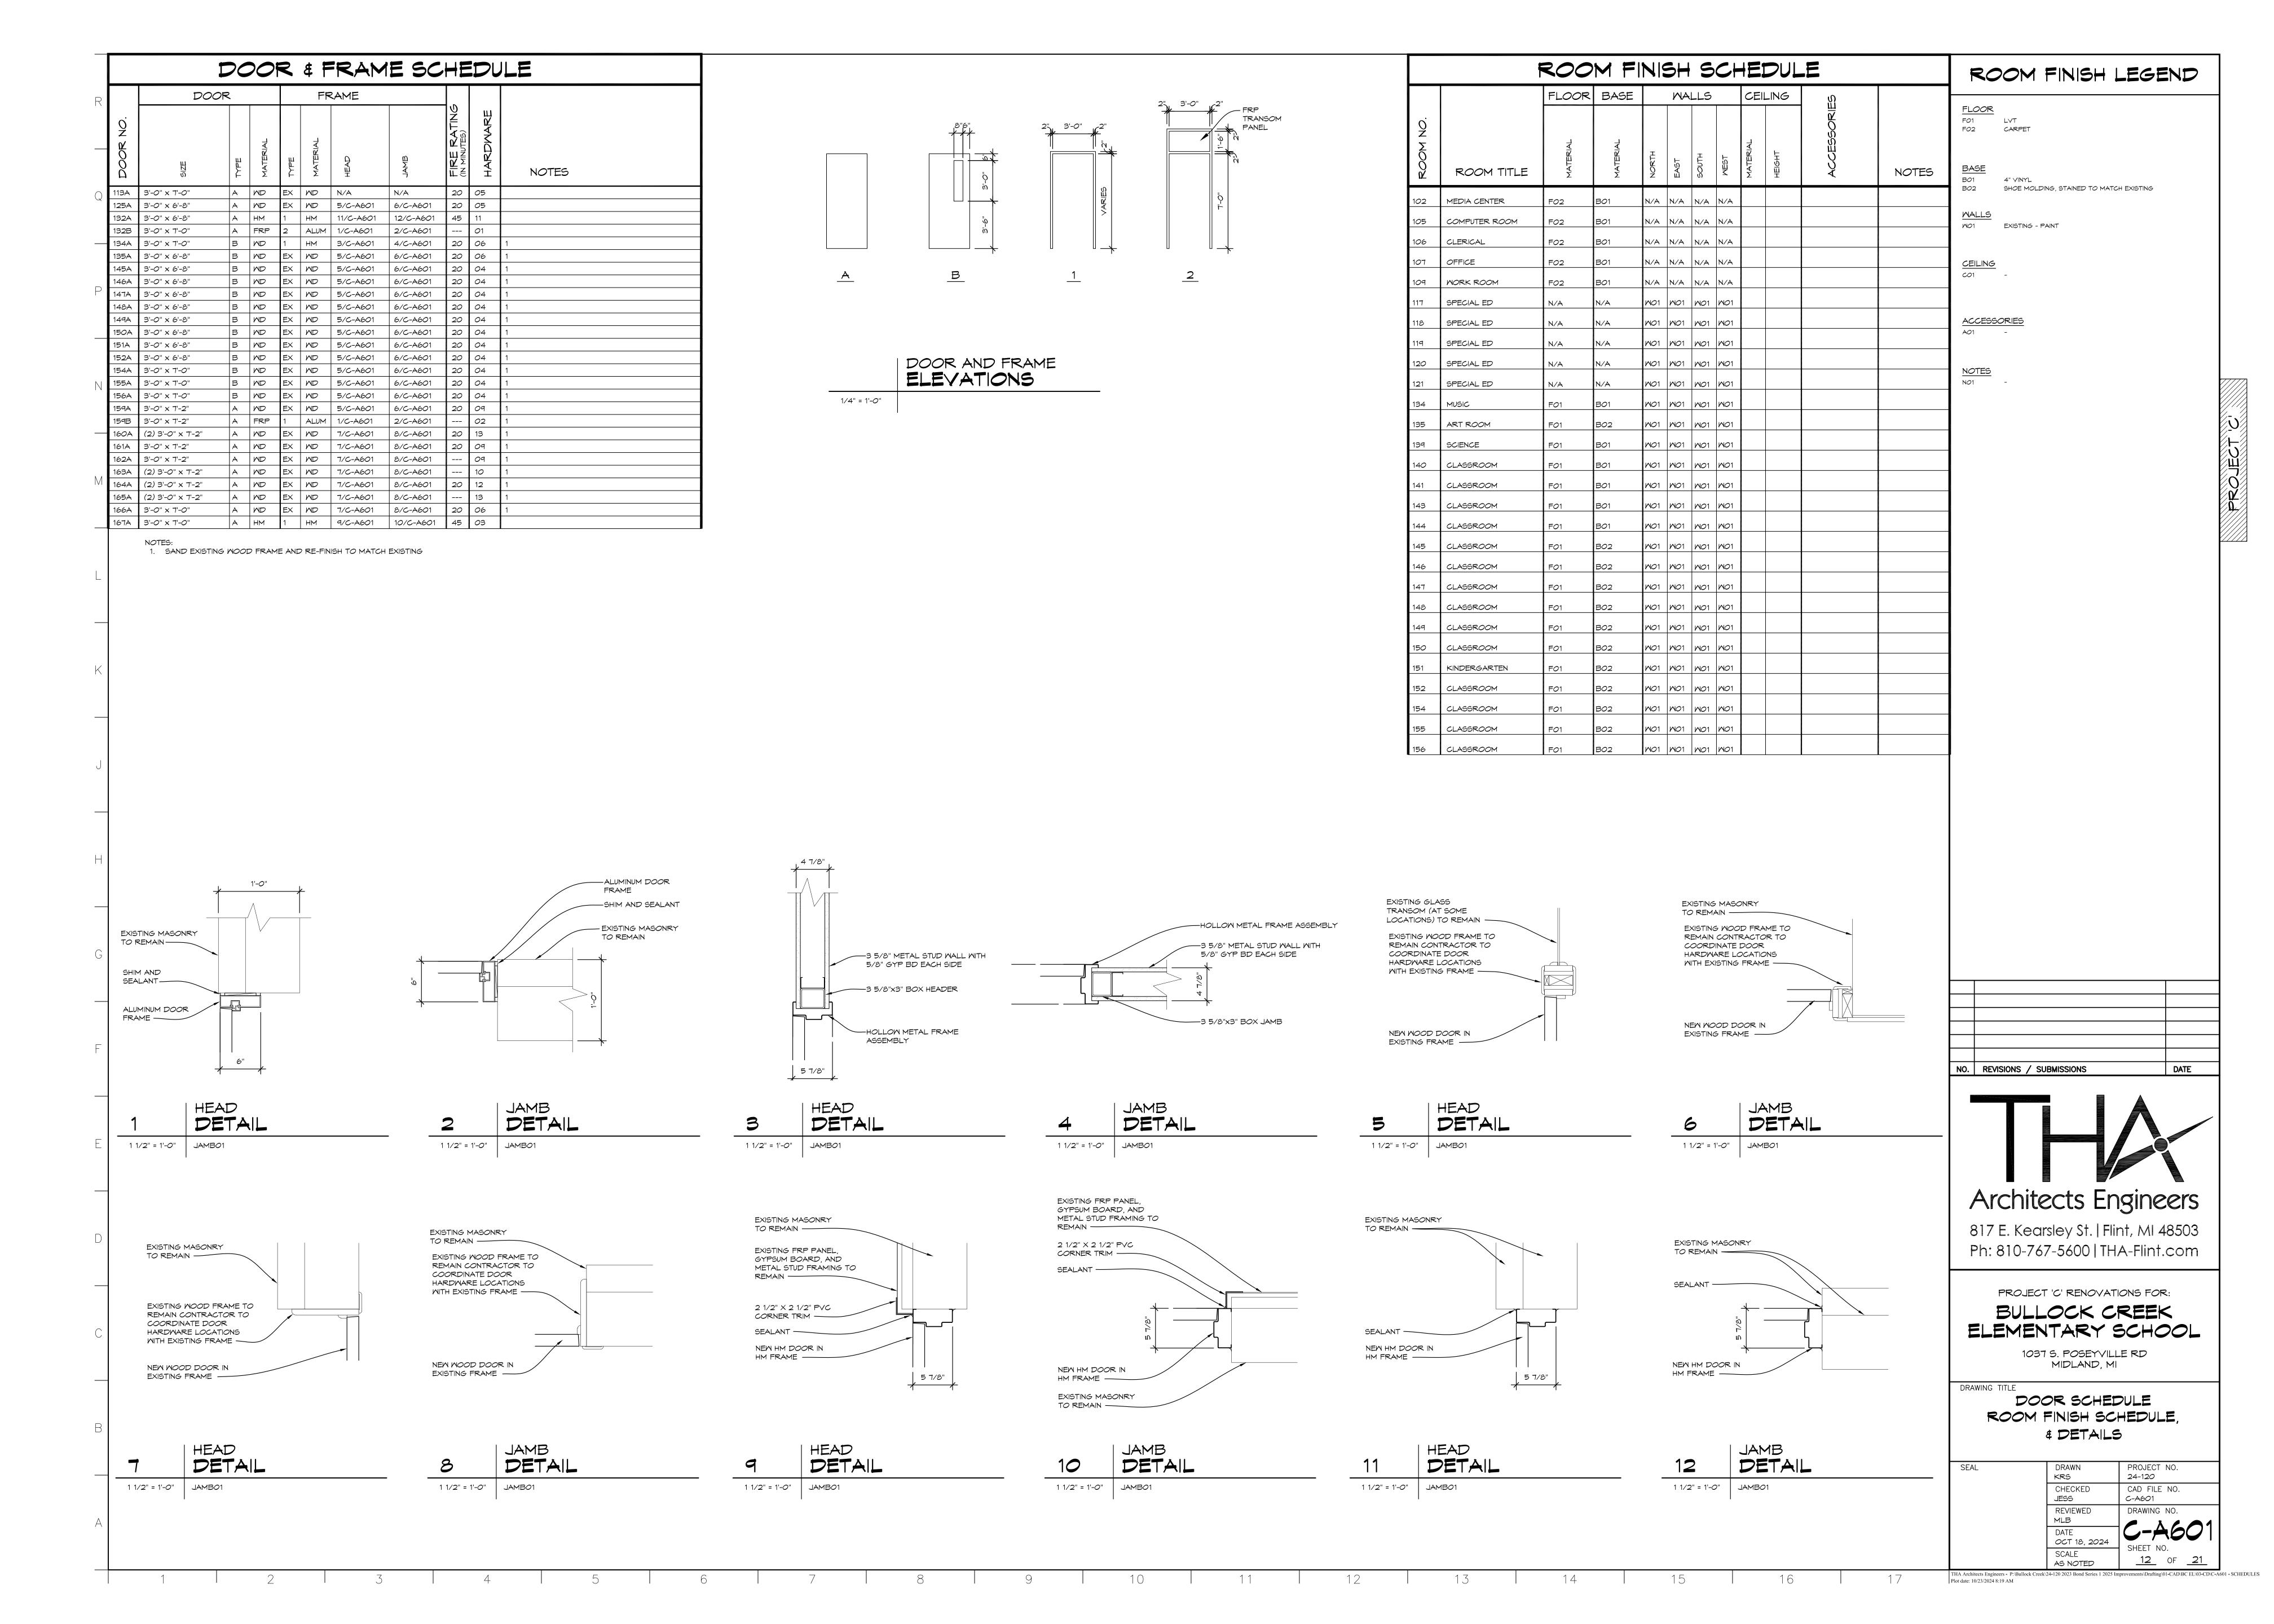

AFF	ABOVE FINISHED FLOOR	(C IAL (DOMESTIC COLD WATER	10×8	DUCT SIZE(CLEAR INSIDE DIMENSION)
AHU	AIR HANDLING UNIT	5	DOMESTIC COLD MATER	5 10,25	
BFF	BELOW FINISH FLOOR	S	DOMESTIC HOT WATER		FIRST FIGURE INDICATES PLAN SIZE
BHP	BRAKE HORSEPOWER	5-HM (140)-5	DOMESTIC HOT WATER 140F DEG	ς 10Φ ς	ROUND DUCT DIAMETER SIZE
BTUH	BRITISH THERMAL UNIT PER HOUR CONDENSATE	5	DOMESTIC HOT WATER RETURN		VOLUME DAMPER IN DUCT
CB	COMBINATION UNIT		DOMESTIC HOT WATER	, , , , ,	VOLUME DAMPER IN DOCT
CFM	CUBIC FEET PER MINUTE	S-HWR (140)-S	RETURN 140F DEG		DUCT DOWN
COND	CLEANOUT CONDENSATE		CONDENSATE	, ,	DOCT DONN
CONT	CONTINUATION	5—6—	GAS		SLOT DIFFUSER
CM	CABINET UNIT HEATER COLD WATER	SAN -S	SANITARY		CEILING SUPPLY DIFFUSER
EC	ELECTRICAL CONTRACTOR	<u> </u>	VENT		CEILING RETURN DIFFUSER
ef Esp	EXHAUST FAN EXTERNAL STATIC PRESSURE	5	STORM		
EXH	EXHAUST	S-HWHS	HOT WATER HEATING SUPPLY		CEILING EXHAUST DIFFUSER
° =	DEGREE FAHRENHEIT			\Box	THERMOSTAT
FCU	FAN COIL UNIT	5	HOT WATER HEATING RETURN		INCOMOSIAI
FD	FLOOR DRAIN	S—CHMS—S	CHILLED MATER SUPPLY		HORIZONTAL FIRE DAMPER
FPM FT	FEET PER MINUTE FEET	S-CHMR-S	CHILLED WATER RETURN		W/ACCESS DOOR
6	GAS			_	VERTICAL FIRE DAMPER
GPH	GALLONS PER HOUR	5	PIPE DROP		W/ACCESS DOOR
GPM	GALLONS PER MINUTE	\	PIPE RISE		7 V AGG122 2001
HP	HORSEPOWER		ADDOIAL INDIC ATEC	SD_	HORIZONTAL SMOKE DAMPER
HW (140)	HOT WATER HOT WATER (140 °F)	5	ARROW INDICATES DIRECTION OF FLOW		W/ACCESS DOOR
HWHR	HOT WATER HEATING RETURN		BALL VALVE	A	VENELS ALL CAROLE DALANES
HMHS	HOT WATER HEATING SUPPLY) 101 >	DALL VALVE	SD A	VERTICAL SMOKE DAMPER W/ACCESS DOOR
HMR	HOT WATER RETURN	├	GATE VALVE		, ,
HWR (140)	HOT WATER RETURN (140 °F)	.1.			
KM	KILOWATT	S	UNION	← /-	DIRECTION OF AIR FLOW
L OR LAV	LAVATORY	\bigcirc			
MBH	ONE THOUSAND BTUH	}	PRESSURE GAUGE W/ SHUTOFF		HOOD EXHAUST DUCT
MC MIN	MECHANICAL CONTRACTOR MINIMUM	5 5	STRAINER		HOOD SUPPLY AIR DUCT
MTD	MOUNTED	·			
PH	PHASE	├	CHECK VALVE		RECTANGULAR SUPPLY DUCT UP
PSI	POUND PER SQUARE INCH	<u></u>	THERMOMETER W/ SHUTOFF		RECTANGULAR RETURN DUCT UP
PVC	POLYVINYL CHLORIDE RETURN AIR				
RA RD	ROOF DRAIN	\$ \$	THREE WAY CONTROL VALVE		RECTANGULAR EXHAUST DUCT UP
RE:	REFER TO DRAWING	, 2,			RECTANGULAR SUPPLY DUCT DN
RG	RETURN GRILLE	T (PETE'S PLUG (TEMPERATURE-		
RH	RELIEF HOOD	,	PRESSURE TEST FITTING)		RECTANGULAR RETURN DUCT DN
RTU S	ROOFTOP UNIT SINK	ζ	MANUAL AIR VENT		RECTANGULAR EXHAUST DUCT DN
SA	SUPPLY AIR	, Πλλ\/	DA MARKE MILE A FILE		neo i anguean earaust duct din
SAN	SANITARY	Ş	AUTOMATIC AIR VENT		
56	SUPPLY GRILLE				ELBOW WITH TURNING VANES
SP	STATIC PRESSURE		FLOW CONTROL	一人。	
55	SERVICE SINK	Δ			
ST	STORM	├	TMO-MAY CONTROL VALVE		
UH	UNIT HEATER	├			
UR	URINAL	, , ,	THREE-WAY CONTROL VALVE		
UV	UNIT VENTILATOR				

NON FREEZE WALL HYDRANT

CARBON DIOXIDE SENSOR

FLOOR CLEANOUT

THERMOSTAT

SYMBOLS & ABBREVIATIONS LEGEND

	TRANE	AREA	 .			FAN	FAN	GAS HEA	AT (MBH)	COOLI	NG (MBH)				MEIGHT	
TAG	MODEL #	SERVED	CFM	MIN OA	ESP	HP	RPM	INPUT	OUTPUT	TOTAL	SENSIBLE	VOLTAGE	MCA	MOP	(LBS)	NOTES
RTU-A1	Y5K180	OFFICES/ COMMUNITY ROOM	6,600	700/ 1,820	1.1	3.313	1365	400	324	190.4	151.68	208V/3Φ	79	110	2188	2,3,5,6,7,8,9
RTU-A2	YSK048	COMPUTER ROOM	1,600	200/ 400	0.85	0.8	1161	130	105.3	50.04	38.35	208V/3Ф	27	40	781	2,3,5,6,7,9
RTU-A3	YSK150	MEDIA CENTER/ CONFERENCE	4,200	500/ 1,000	0.9	3	1579	240	194.4	127.09	103.26	208V/3Ф	57	80	1225	1,3,5,6,7,8,9
(E) RTU-A4	(EXISTING) YSC120	CLASSROOMS/ TOILET ROOMS														10
(E) RTU-A5	(EXISTING) YHH180	GYM/ STORAGE														10
RTU-B1	YSK150	STAFF/ SPECIAL ED	5,000	500/ 1,100	1.3	4.6	1665	250	202.5	157.57	120.86	208√/3Ф	67	90	1426	1,3,4,5,6,7,8
(E) RTU-B2	(EXISTING) YCD360BEH	CLASSROOMS														10
RTU-C1	YSK090	SCIENCE/ CLASSROOMS	3,000	450/ 1,250	0.8	3	1224	200	162	96.92	77.19	208V/3Φ	43	50	1174	1,3,5,6,7,8,9
RTU-C2	YSK150	CLASSR <i>OO</i> MS	6,000	810	0.9	4.6	1823	250	202.5	158.35	129.18	208V/3Ф	67	90	1426	1,3,5,6,7,8,9
RTU-C3	YSK036	CONFERENCE	900	150	0.85	0.3	889	120	97.2	35.7	24.77	208√/3Ф	23	30	752	1,3,5,6,7,9
(E) RTU-C4	(EXISTING) YSC092	MUSIC ROOM/ ART ROOM														10
RTU-K1	YSK072	KITCHEN	1,950	200	0.5	3	<i>8</i> 51	150	121.5	80.6	56.31	208V/3Ф	38	50	1115	1,3,5,6,7,8

- NOTES: 1. PROVIDE WITH NEW ROOF CURB ADAPTER (WITH WIRING THROUGH CURB), FIELD VERIFY ALL EXISTING ROOF CURBS PRIOR TO ORDERING UNIT. 2. INSTALL UNIT AT EXISTING ROOF CURB, FIELD VERIFY REQUIREMENTS PRIOR TO ORDERING UNIT.
 - 3. PROVIDE WITH BAROMETRIC RELIEF HOOD, ECONOMIZER HOOD AND OUTSIDE ENTHALPY CONTROL (FACTORY EQUIPMENT FIELD CONNECTIONS) 4. PROVIDE WITH DUCT MOUNTED BAROMETRIC RELIEF HOOD, DAMPERS, AND UNIT MOUNTED RETURN AIR DAMPERS FIELD MOUNTED
 - 5. PROVIDE WITH 2" MERV 13 FILTERS, HAIL GUARDS 6. FACTORY INSTALLED GFI OUTLET (FIELD WIRE BY ELECTRICAL) AND PHASE MONITOR, COORDINATE DISCONNECTS WITH ELECTRICAL TRADES.
 - 7. PROVIDE CO2 CONTROL MINIMUM TO MAXIMUM OUTSIDE AIR FLOW

11. PROVIDE FLUE EXTENSION KIT AT RTU

VENT OR VOLT

VENT THRU ROOF

WASTE OR WATT WATER CLOSET

MATER HEATER


MASTE & VENT

8. PROVIDE UNIT WITH STAINLESS STEEL HEAT EXCHANGER AND MODULATING GAS HEAT. 9. PROVIDE UNIT WITH FACTORY DDC CONTROLS WITH BACNET INTERFACE, ETC. 10. EXISTING RTU SHOWN ON SCHEDULE AND PLANS FOR CONTROLS PURPOSES MAP ADDITIONAL CONTROL POINTS AND UP DATE GRAPHICS


			OUTI	DOOR	AIR VEN	TILATIO	n schei	DULE			
HVAC SYSTEM	OCCUPANCY CLASSIFICATION	AREA (SQ. FT.)	MAXIMUM OCCUPANCY PER 1000 S.F.	OCCUPANT LOAD	OUTDOOR AIR REQUIRED PER PERSON (CFM)	OUTDOOR AIR FLOW RATE BREATHING ZONE (CFM)	OUTDOOR AIR RATE BREATHING ZONE (CFM)	OUTDOOR AIR RATE FOR PEOPLE ZONE (CFM)	OUTDOOR AIR REQUIRED FOR EACH SPACE (CFM)	TOTAL OUTDOOR AIR REQUIRED (CFM)	TOTAL OUTDOOR AIR PROVIDED (CFM)
	COMMUNITY ROOM	2,570	120	308	5	0.06	154	1,542	1,696	1,814	
	STORAGE	404				0.12	49		49		1,8 <i>20</i>
RTU-A1 S.A.: 6,600 CFM	CLERICAL	339	5	2	5	0.06	20	10	30		
27% OA 1,820 OA	OFFICE	197	5	1	5	0.06	12	5	17		
	OFFICE	99	5	1	5	0.06	6	5	11		
	MORKROOM	93	4	1	5	0.06	6	5	11		
RTU-A2 S.A.: 1,600 CFM	COMPUTER ROOM	962	25	24	10	0.12	116	240	356	396	
25% OA 400 OA	CORRIDOR	660				0.06	40		40		400
RTU-A3	CONFERENCE	165	50	8	10	0.06	10	80	90	980	1,000
5.A.: 5,000 CFM 20% OA 1,000 OA	MEDIA CENTER	2,377	25	59	10	0.12	285	590	875		
	OFFICE	173	5	1	5	0.06	10	5	15		
	STAFF	591	30	17	7.5	0.06	36	128	164	1,087	1,100
	STAFF TOILET	58				EXH					
RTU-B1	SPECIAL ED	389	35	13	10	0.12	47	130	177		
S.A.: 5,000 CFM 22% OA	SPECIAL ED	382	35	13	10	0.12	46	130	176		
1,1 <i>00 O</i> A	SPECIAL ED	382	35	13	10	0.12	46	130	176		
	SPECIAL ED	382	35	13	10	0.12	46	130	176		
	SPECIAL ED	481	35	16	10	0.12	58	160	218		
RTU-C1	SCIENCE	1,033	25	25	10	0.18	186	250	436		1,250
5.A.: 3,000 CFM 41% OA	CLASSR <i>OO</i> M	876	35	30	10	0.12	105	300	405	1,246	
1,25 <i>0 O</i> A	CLASSR <i>OO</i> M	873	35	30	10	0.12	105	300	405		
RTU-C2 S.A.: 6,000 CFM	CLASSR <i>OO</i> M	871	35	30	10	0.12	105	300	405		810
13% OA 810 OA	CLASSROOM	877	35	30	10	0.12	105	300	405	810	
RTU-C3	CONFERENCE	276	50	13	10	0.06	17	130	147		
5.A.: 900 CFM 16% OA	GIRLS TOILET	215				EXH				147	150
150 OA	BOYS TOILET	231				EXH					
RTU-K1 S.A.: 1950 CFM	KITCHEN	816				EXH					

NOTES: 1. TOTAL OUTDOOR AIR PROVIDED IS IN COMPLIANCE W/ THE REQUIRED OUTDOOR VENTILATION AIR PER TABLE 403.3 OF THE 2015 MMC.

10% OA

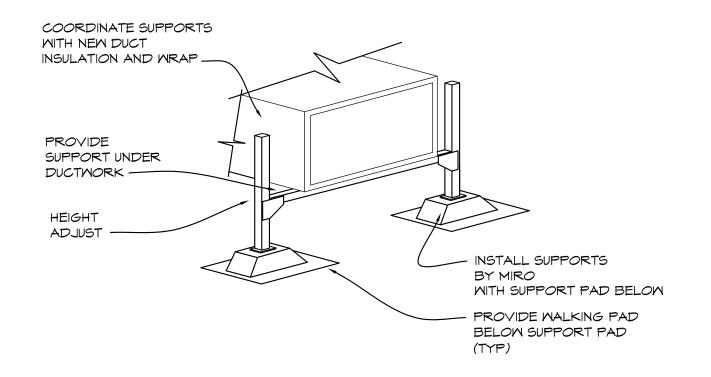

DUCT SUPPORT NO SCALE

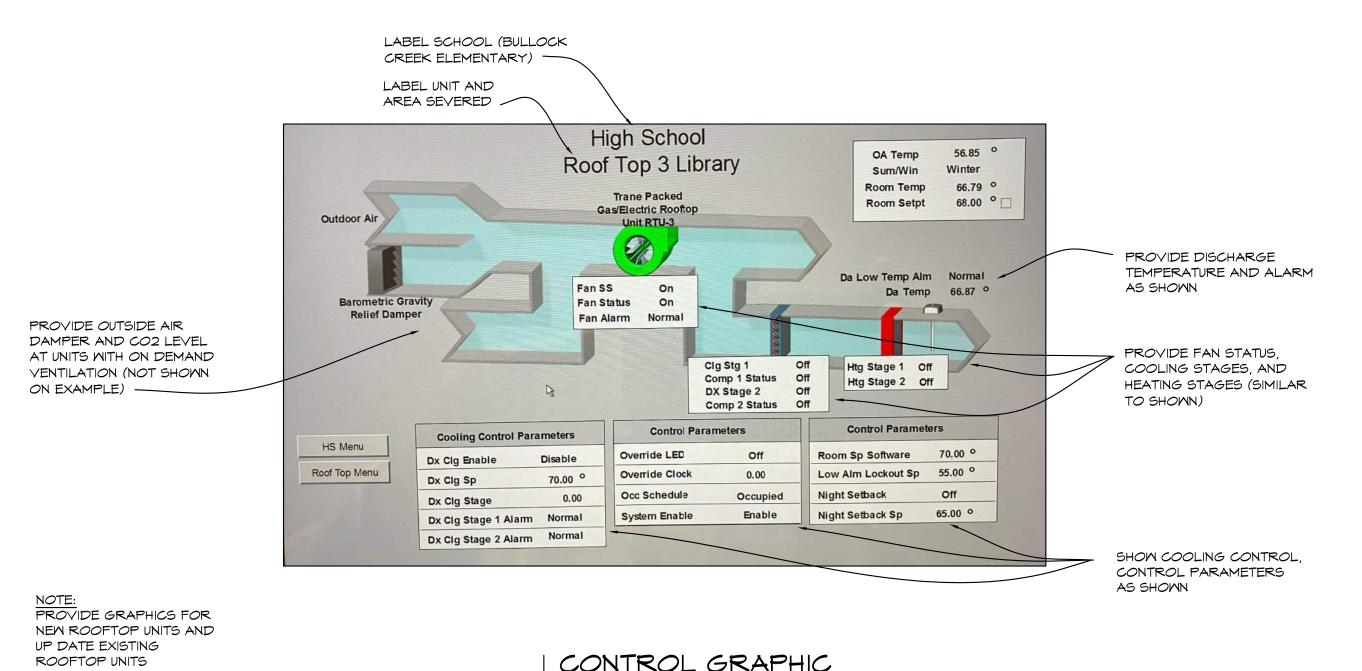



CONTROL GRAPHIC DETAIL

NO SCALE

GENERAL MECHANICAL NOTES

- SEE ALL PLANS FOR FOR REQUIRED WORK.
- OMNER HAS FIRST RIGHT OF REFUSAL, OTHERWISE DISPOSE FROM SITE.
- FIELD VERIFY ALL EXISTING PIPING, DUCTWORK AND
- CONTRACTOR TO RUN ALL DRAIN PIPING TO NEAREST
- COORDINATE ALL WORK WITH ARCHITECTURAL, STRUCTURAL AND ELECTRICAL DRAWINGS AND TRADES, VERIFY EXACT SIZES AND LOCATIONS OF ALL WALLS,
- AT AREAS OF DEMOLITION, CONTRACTOR IS RESPONSIBLE FOR REMOVING, CAPPING, DISCONNECTING ALL INCIDENTAL ITEMS.
- NOTATIONS ARE MADE IN VARIOUS PLACES ON THE DRAWINGS TO CALL ATTENTION TO DEMOLITION WHICH IS REQUIRED, HOWEVER, THESE DRAWINGS ARE NOT INTENDED TO SHOW EACH AND EVERY ITEM TO BE REMOVED. THE CONTRACTOR AND THE SUBCONTRACTORS FOR THE VARIOUS TRADES SHALL REMOVE THE MATERIALS RELATED TO THEIR RESPECTIVE TRADES AS REQUIRED TO PERMIT THE CONSTRUCTION OF THE NEW WORK AS SHOWN
- SEE ARCHITECTURAL AND ELECTRICAL DRAWINGS FOR ADDITIONAL DEMOLITION WORK
- INSTALL AT MECHANICAL EQUIPMENT MINIMUM OF 10'-0" FROM ROOF EDGE.
- 10. ALL EXHAUST FAN DISCHARGE AND VENTING SHALL BE INSTALLED MINIMUM OF 10'-0" FROM OUTSIDE AIR INTAKES.
- PAINT ALL EXTERIOR GAS PIPING AND INSTALL MINIMUM OF 3 1/2" ABOVE ROOF.
- 12. REMOVE EXISTING GAS PIPING AT EXISTING RTU'S, REROUTE AND INSTALL NEW DIRT LEG, UNION, ISOLATION AT UNIT.
- COORDINATE POWER WIRING WITH ELECTRIC TRADES, RUN
- 4. REMORK CONTROL WIRING TO NEW RTU'S AND CONNECT TO EXISTING BMS SYSTEM, INSTALL NEW THERMOSTATS,
- CO2 DETECTORS, ETC. 15. UPDATE CONTROL GRAPHICS FOR EXISTING RTU'S ADD ADDITIONAL POINTS TO MATCH EXISTING DISTRICT
- GRAPHICS AT OTHER BUILDINGS 16. PROVIDE EXTERIOR DUCT INSULATION AT RTU-B1 (SEE SPECIFICATION)

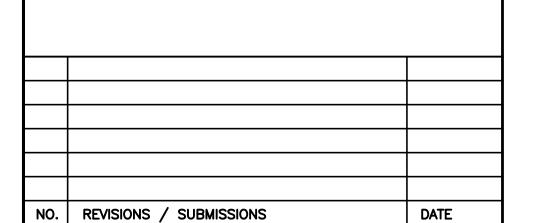

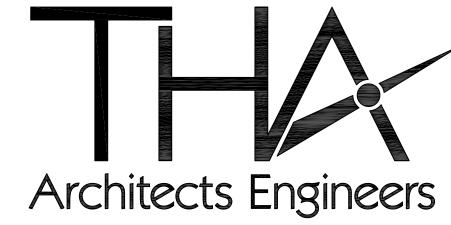

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PROJECT 'C' RENOVATIONS FOR: BULLOCK CREEK

ELEMENTARY SCHOOL 1037 S. POSEYVILLE RD

MIDLAND, MI

DRAWING TITLE

SEAL


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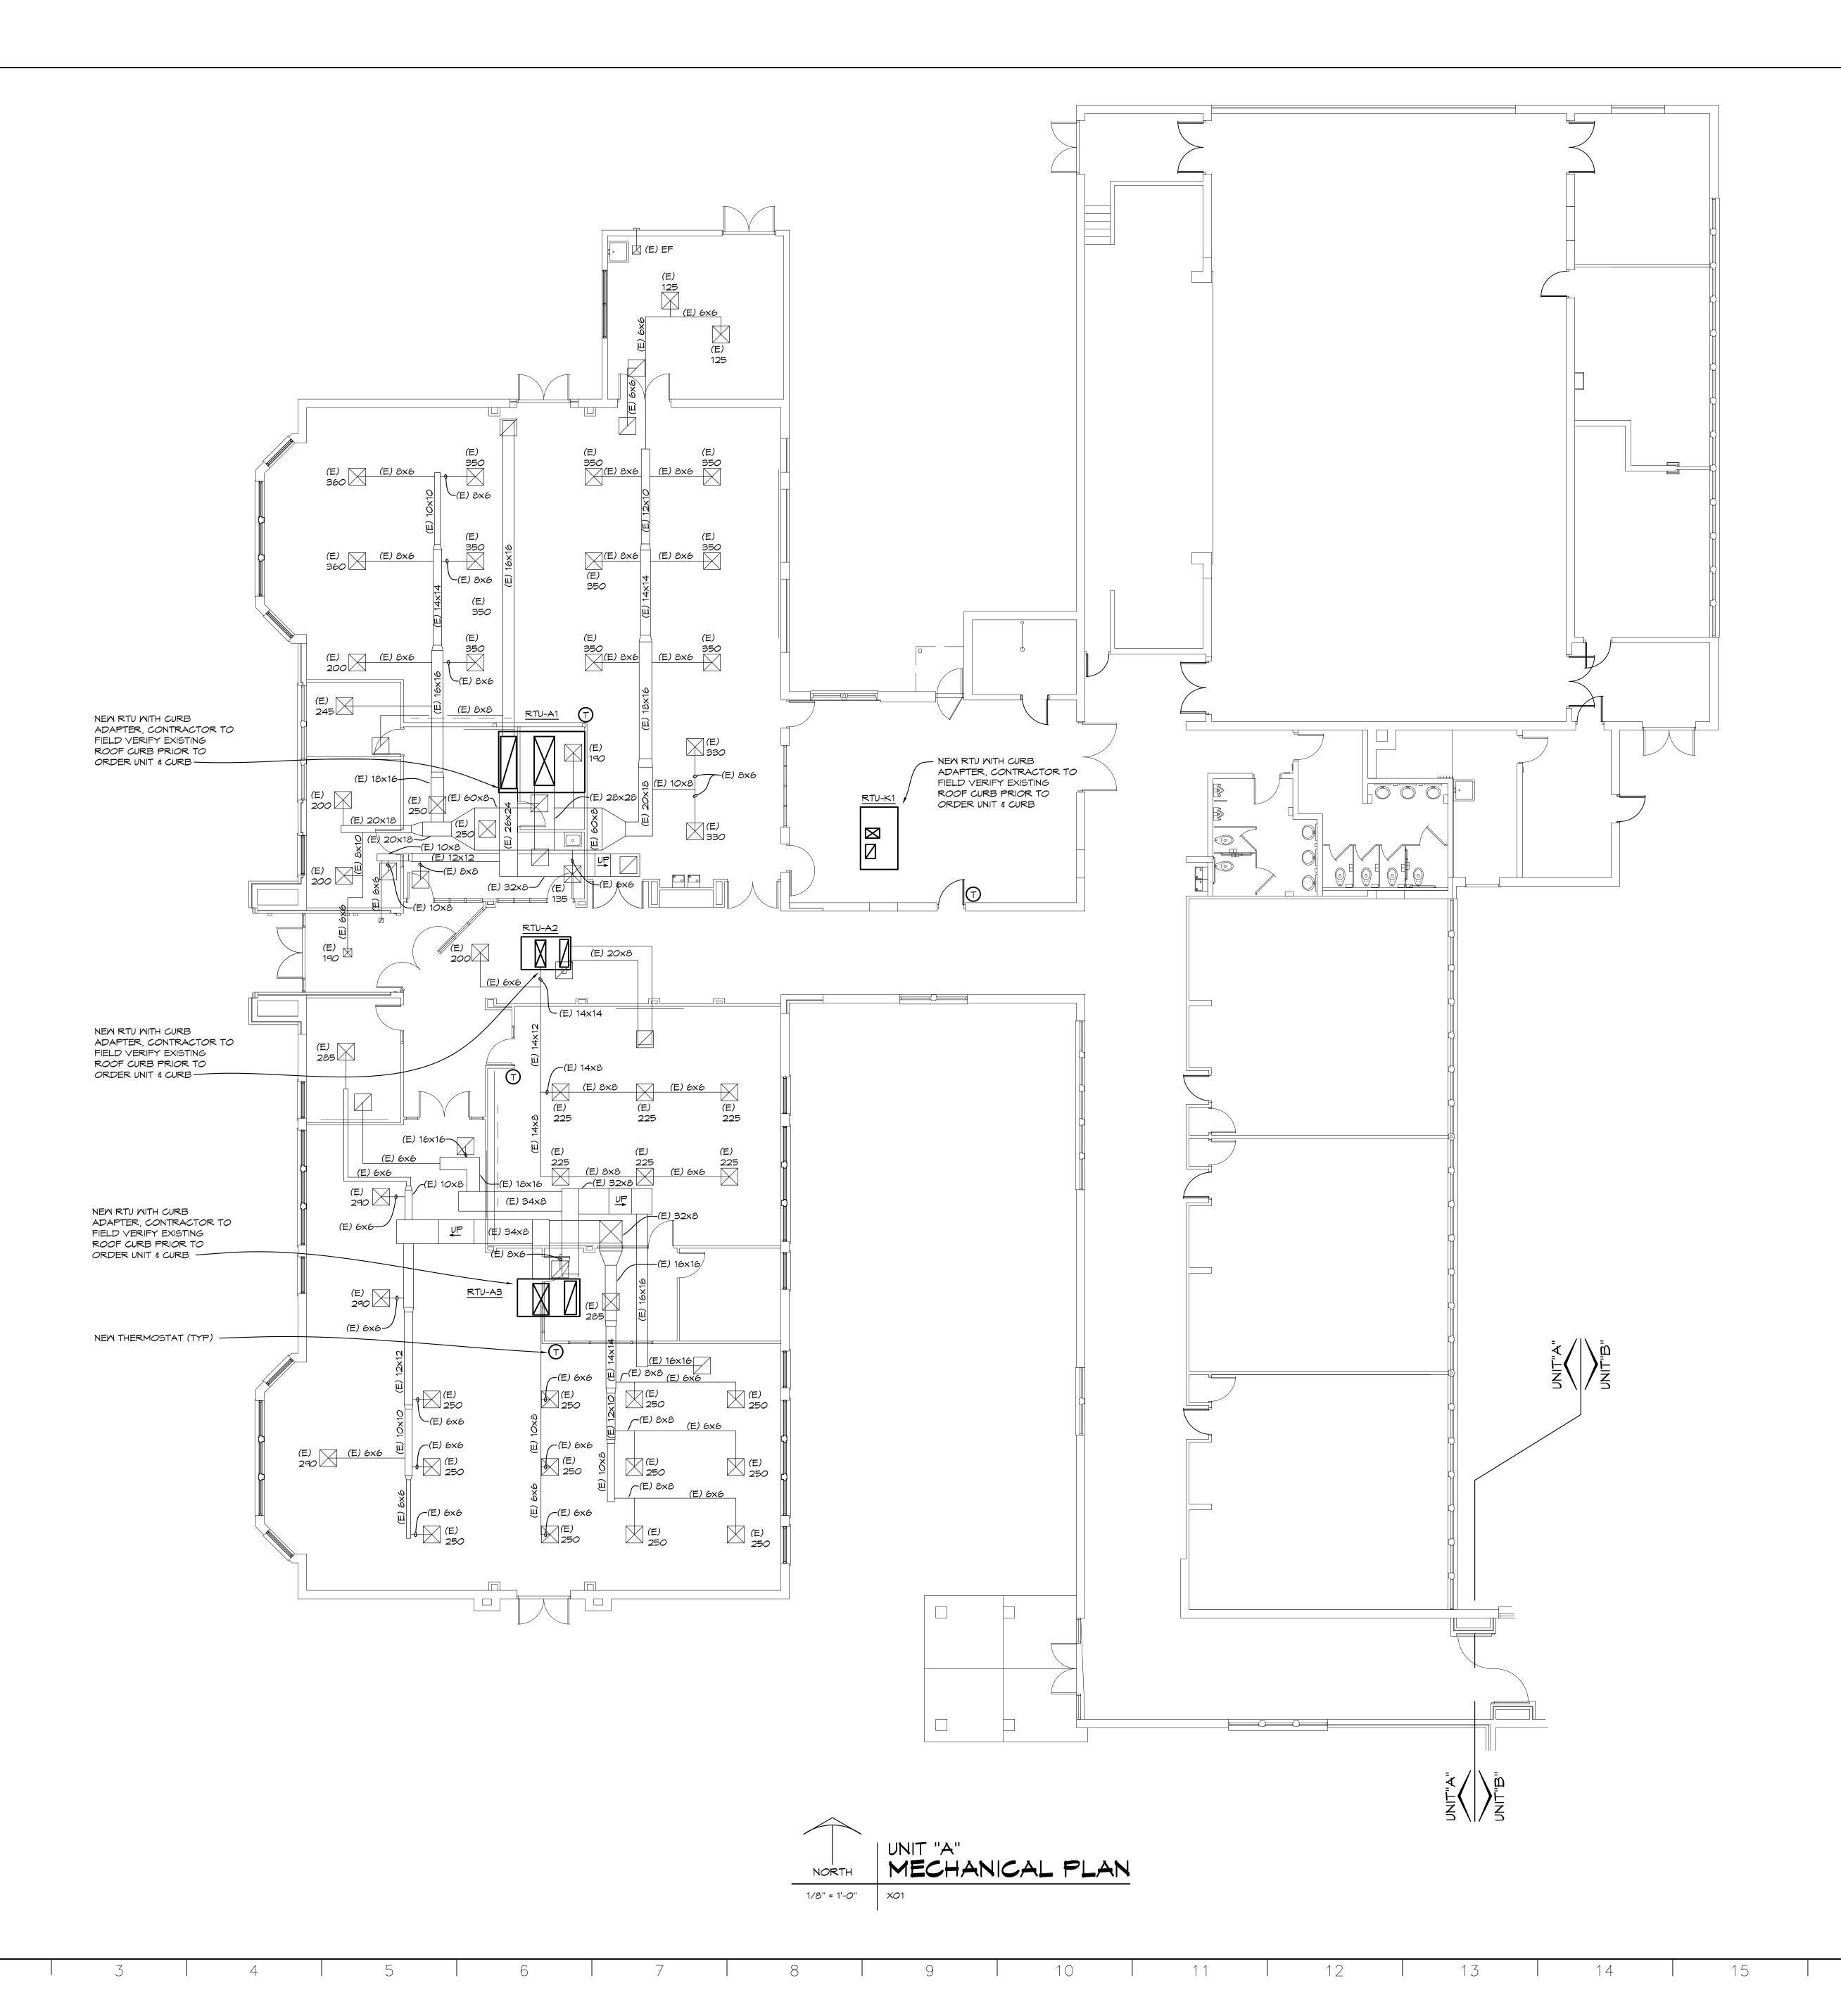
MECHANICAL SCHEDULES

DRAWN CJV/KLS	PROJECT NO. 24-120
CHECKED KLS	CAD FILE NO. C-MOO1
REVIEWED MLB	DRAWING NO.
DATE OCT 18, 2024	C-MOO'
SCALE AS NOTED	SHEET NO.

GENERAL

1/16" = 1'-0"



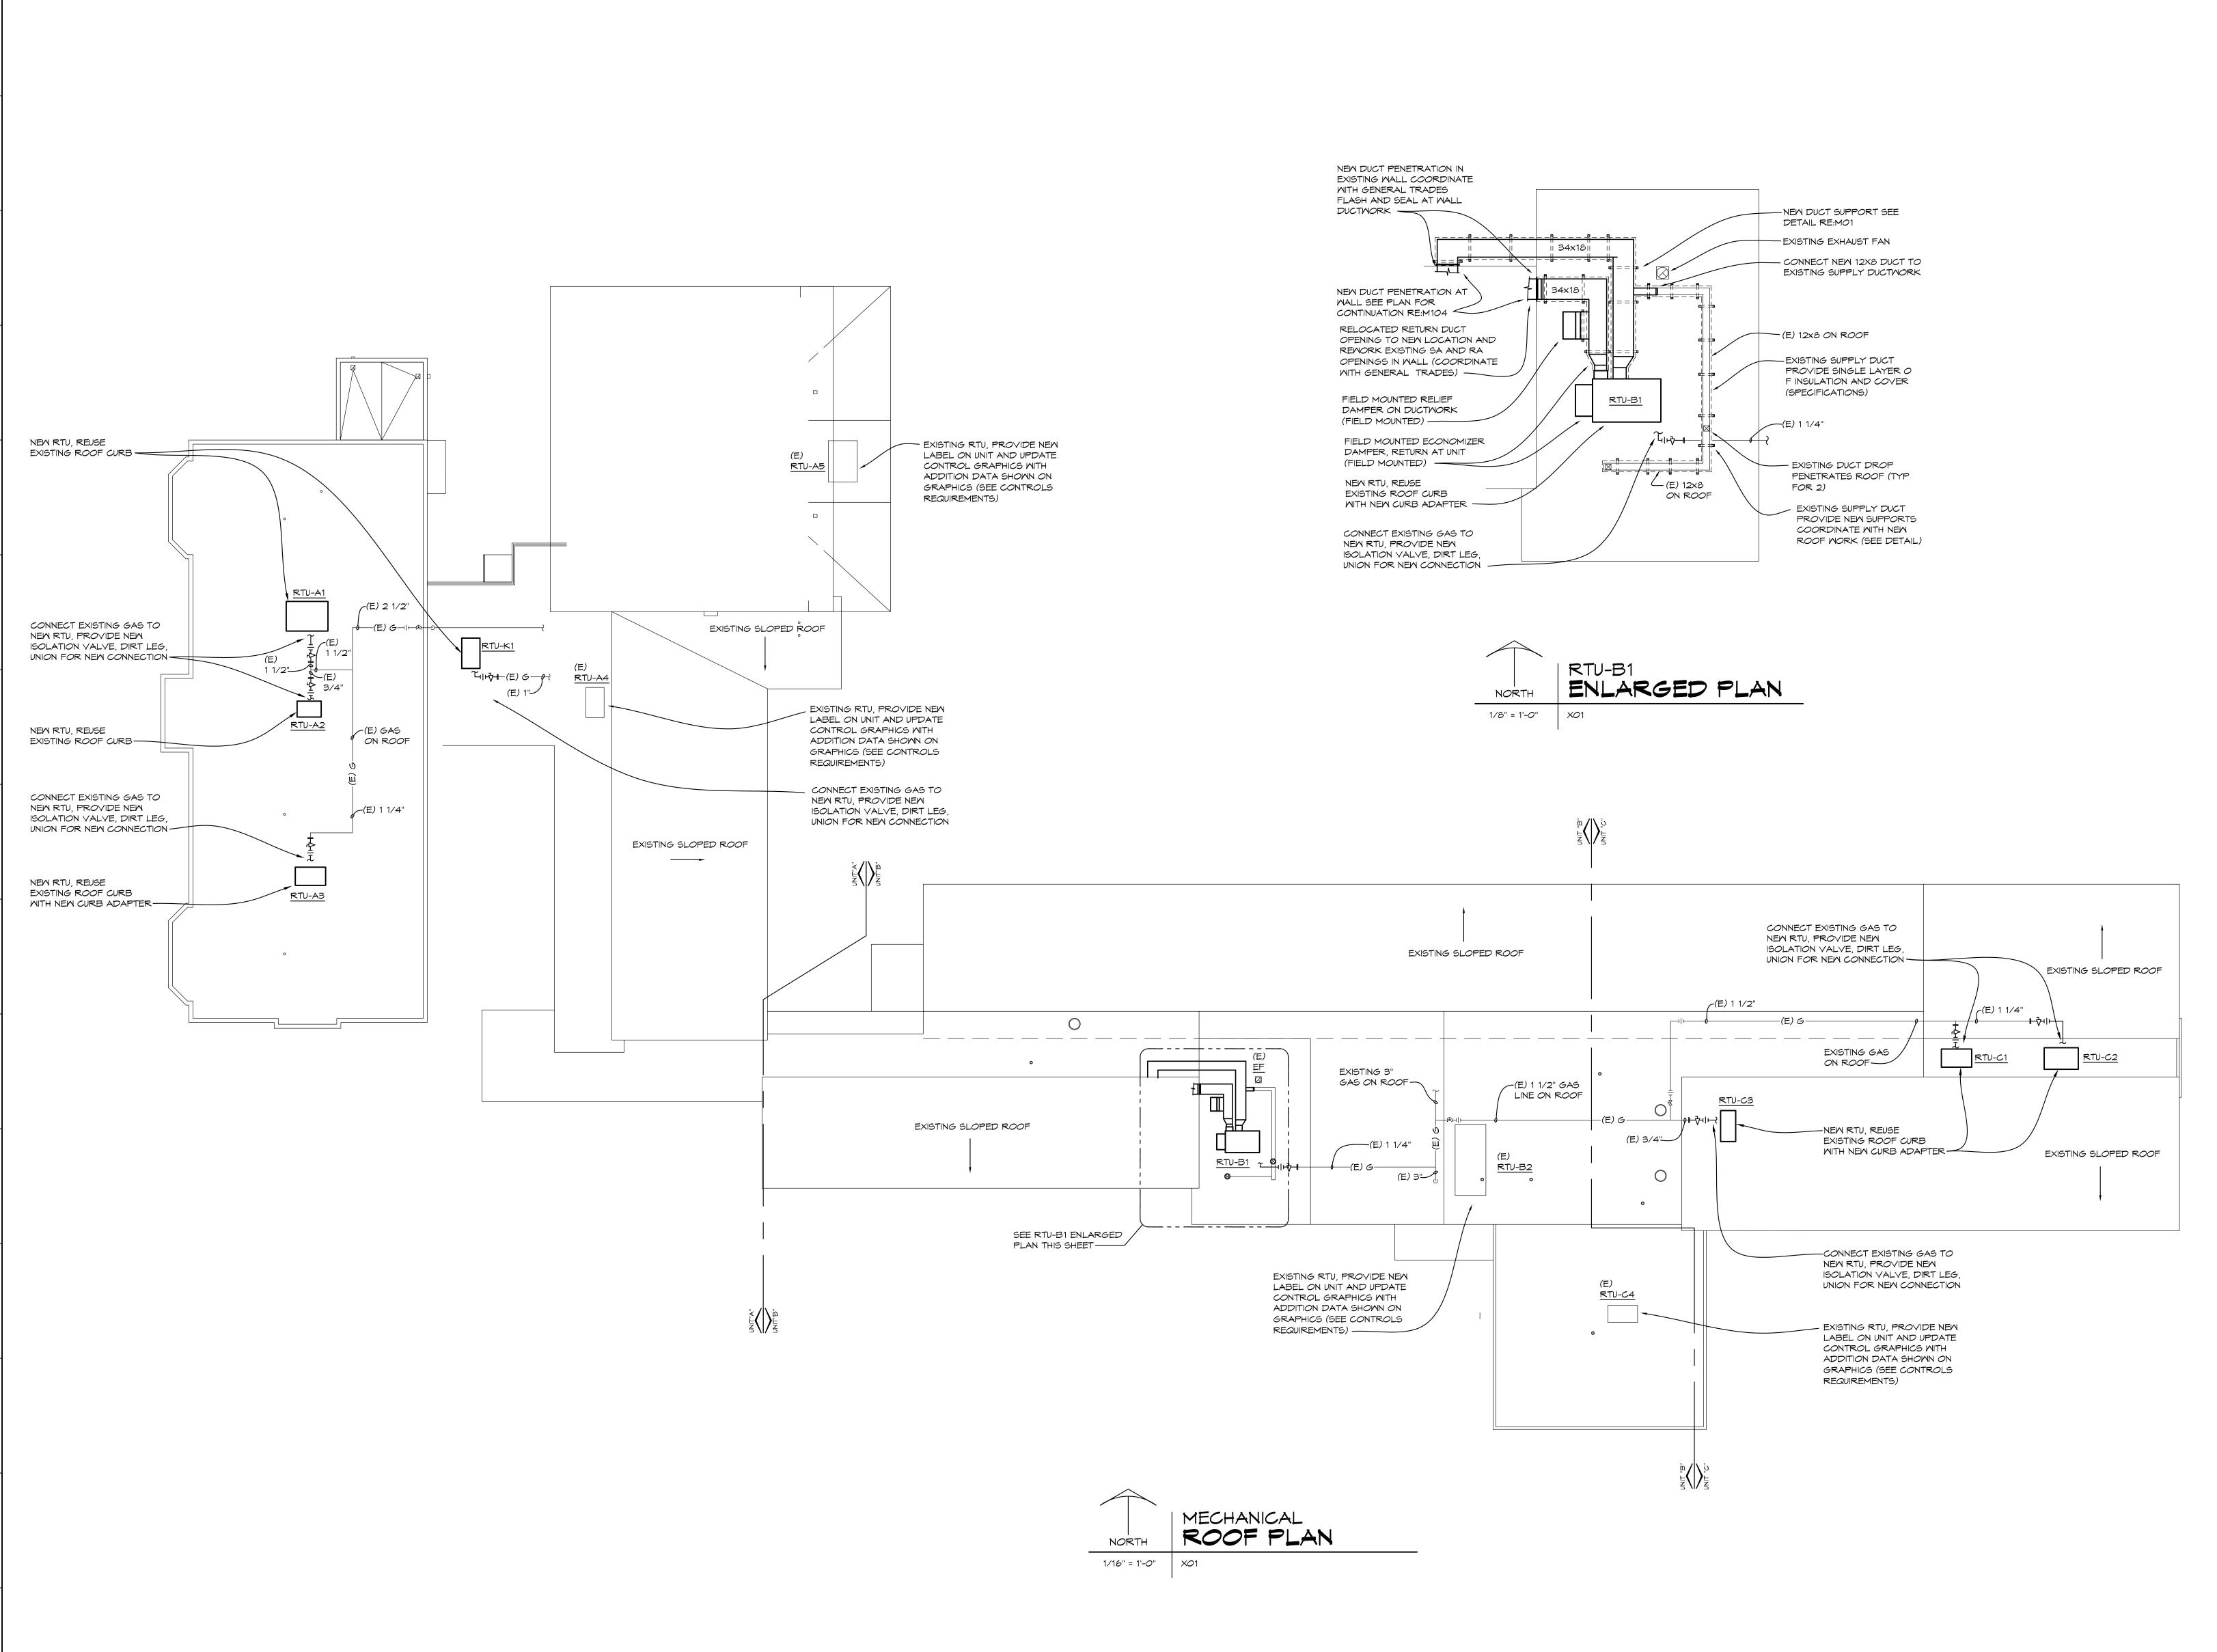

SEAL	DRAWN CJV/KLS	PROJECT NO. 24-12 <i>0</i>					
	CHECKED KLS	CAD FILE NO. C-M103					
	REVIEWED MLB	DRAWING NO.					
	DATE OCT 18, 2024	C-M103					
	SCALE 1/8" = 1'-0"	16 OF 21					

GENERAL





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PROJECT 'C' RENOVATIONS FOR:
BULLOCK CREEK
ELEMENTARY SCHOOL


1037 S. POSEYVILLE RD MIDLAND, MI


DRAWING TITLE


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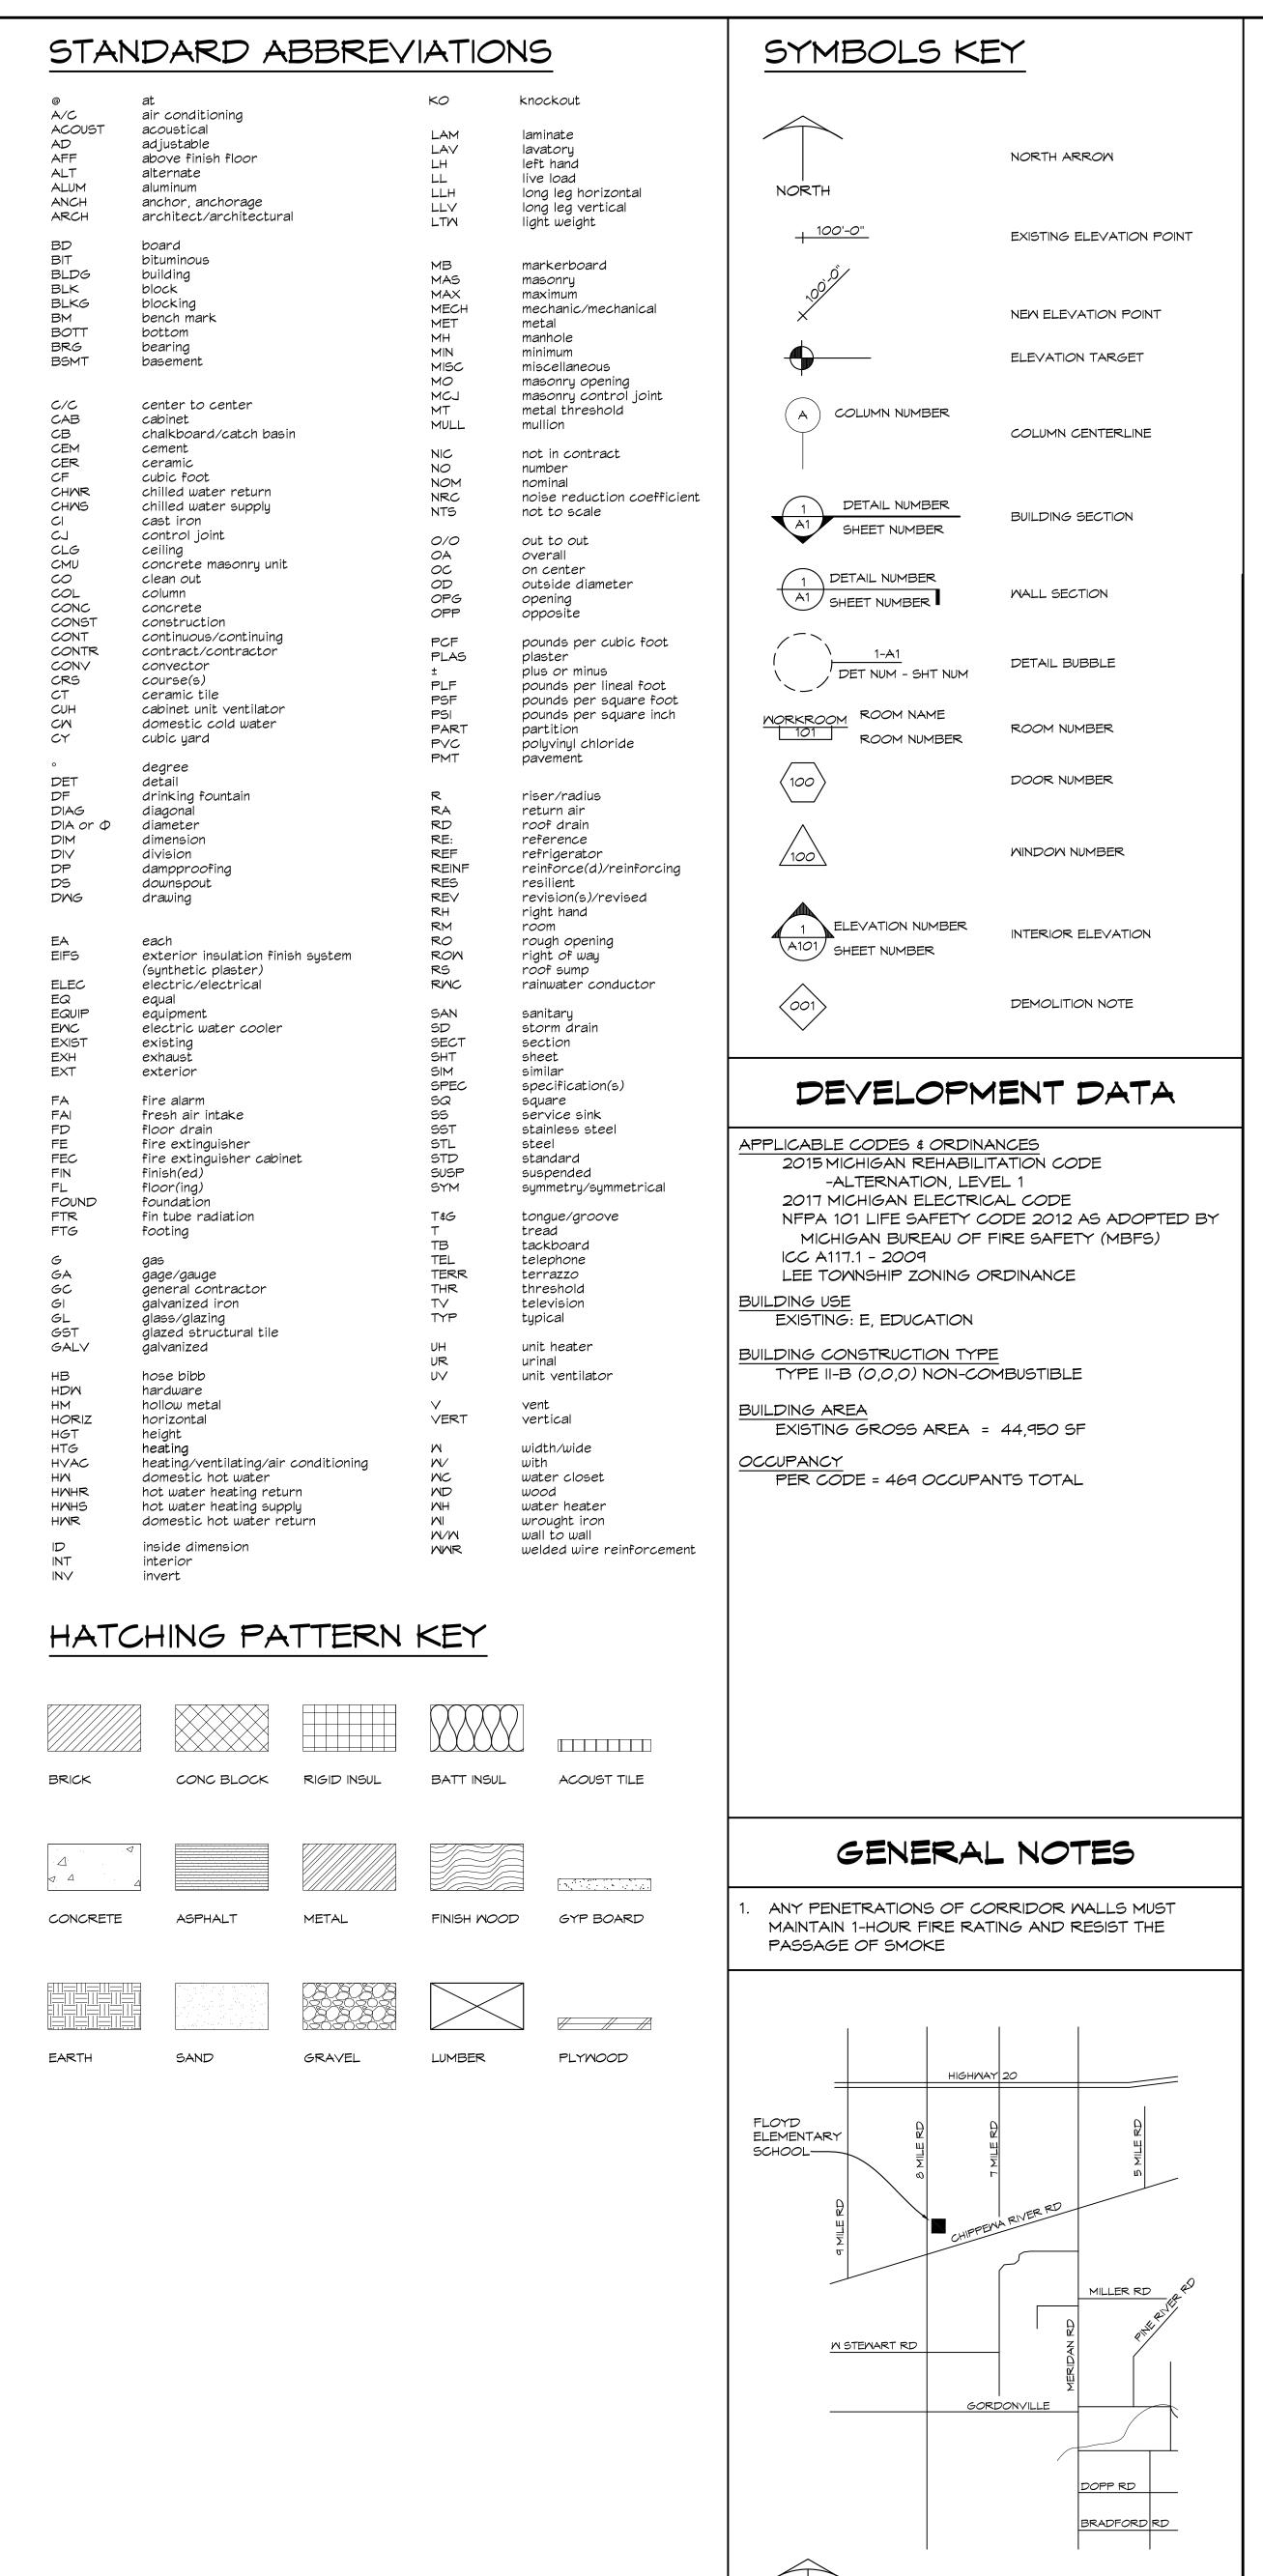
ELECTRICAL COVER SHEET

EAL	DRAWN TJA	PROJECT NO. 24-120
	CHECKED RCH	CAD FILE NO. A-E000
	REVIEWED RCH	DRAWING NO.
	DATE OCT 18, 2024	C-EOO(
	SCALE AS NOTED	SHEET NO. _ <u>18_</u> of <u>21</u> _



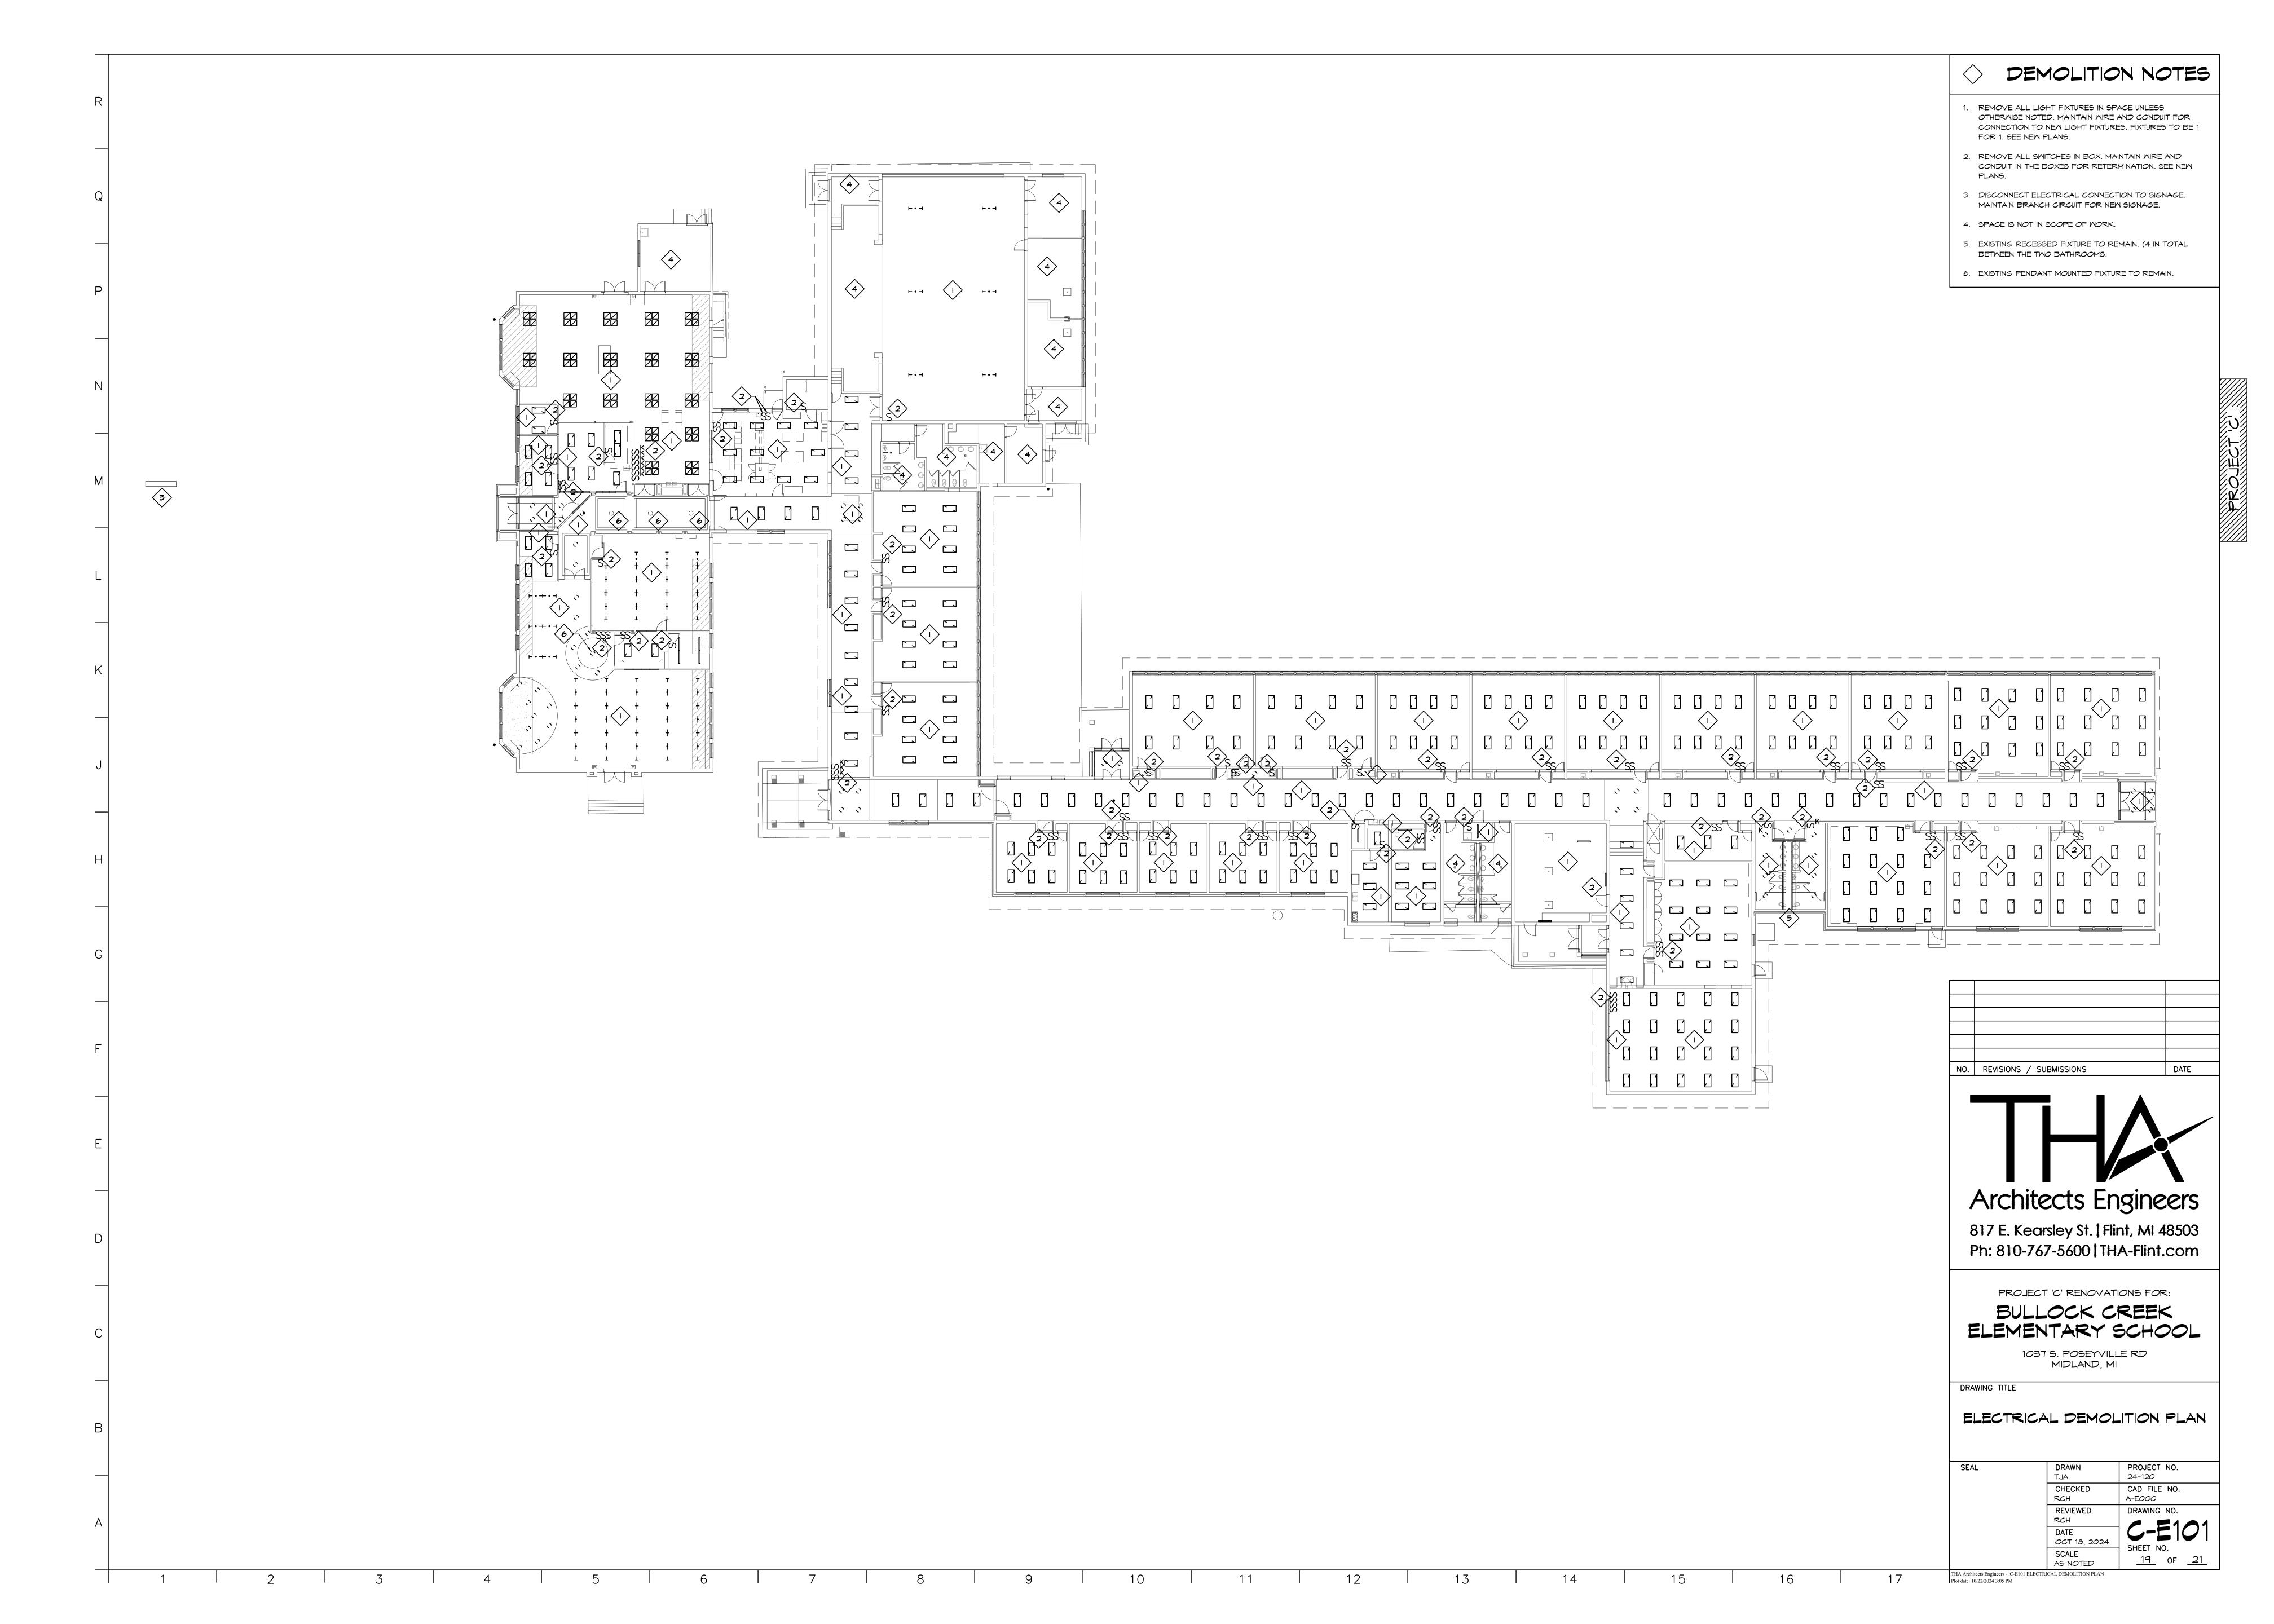

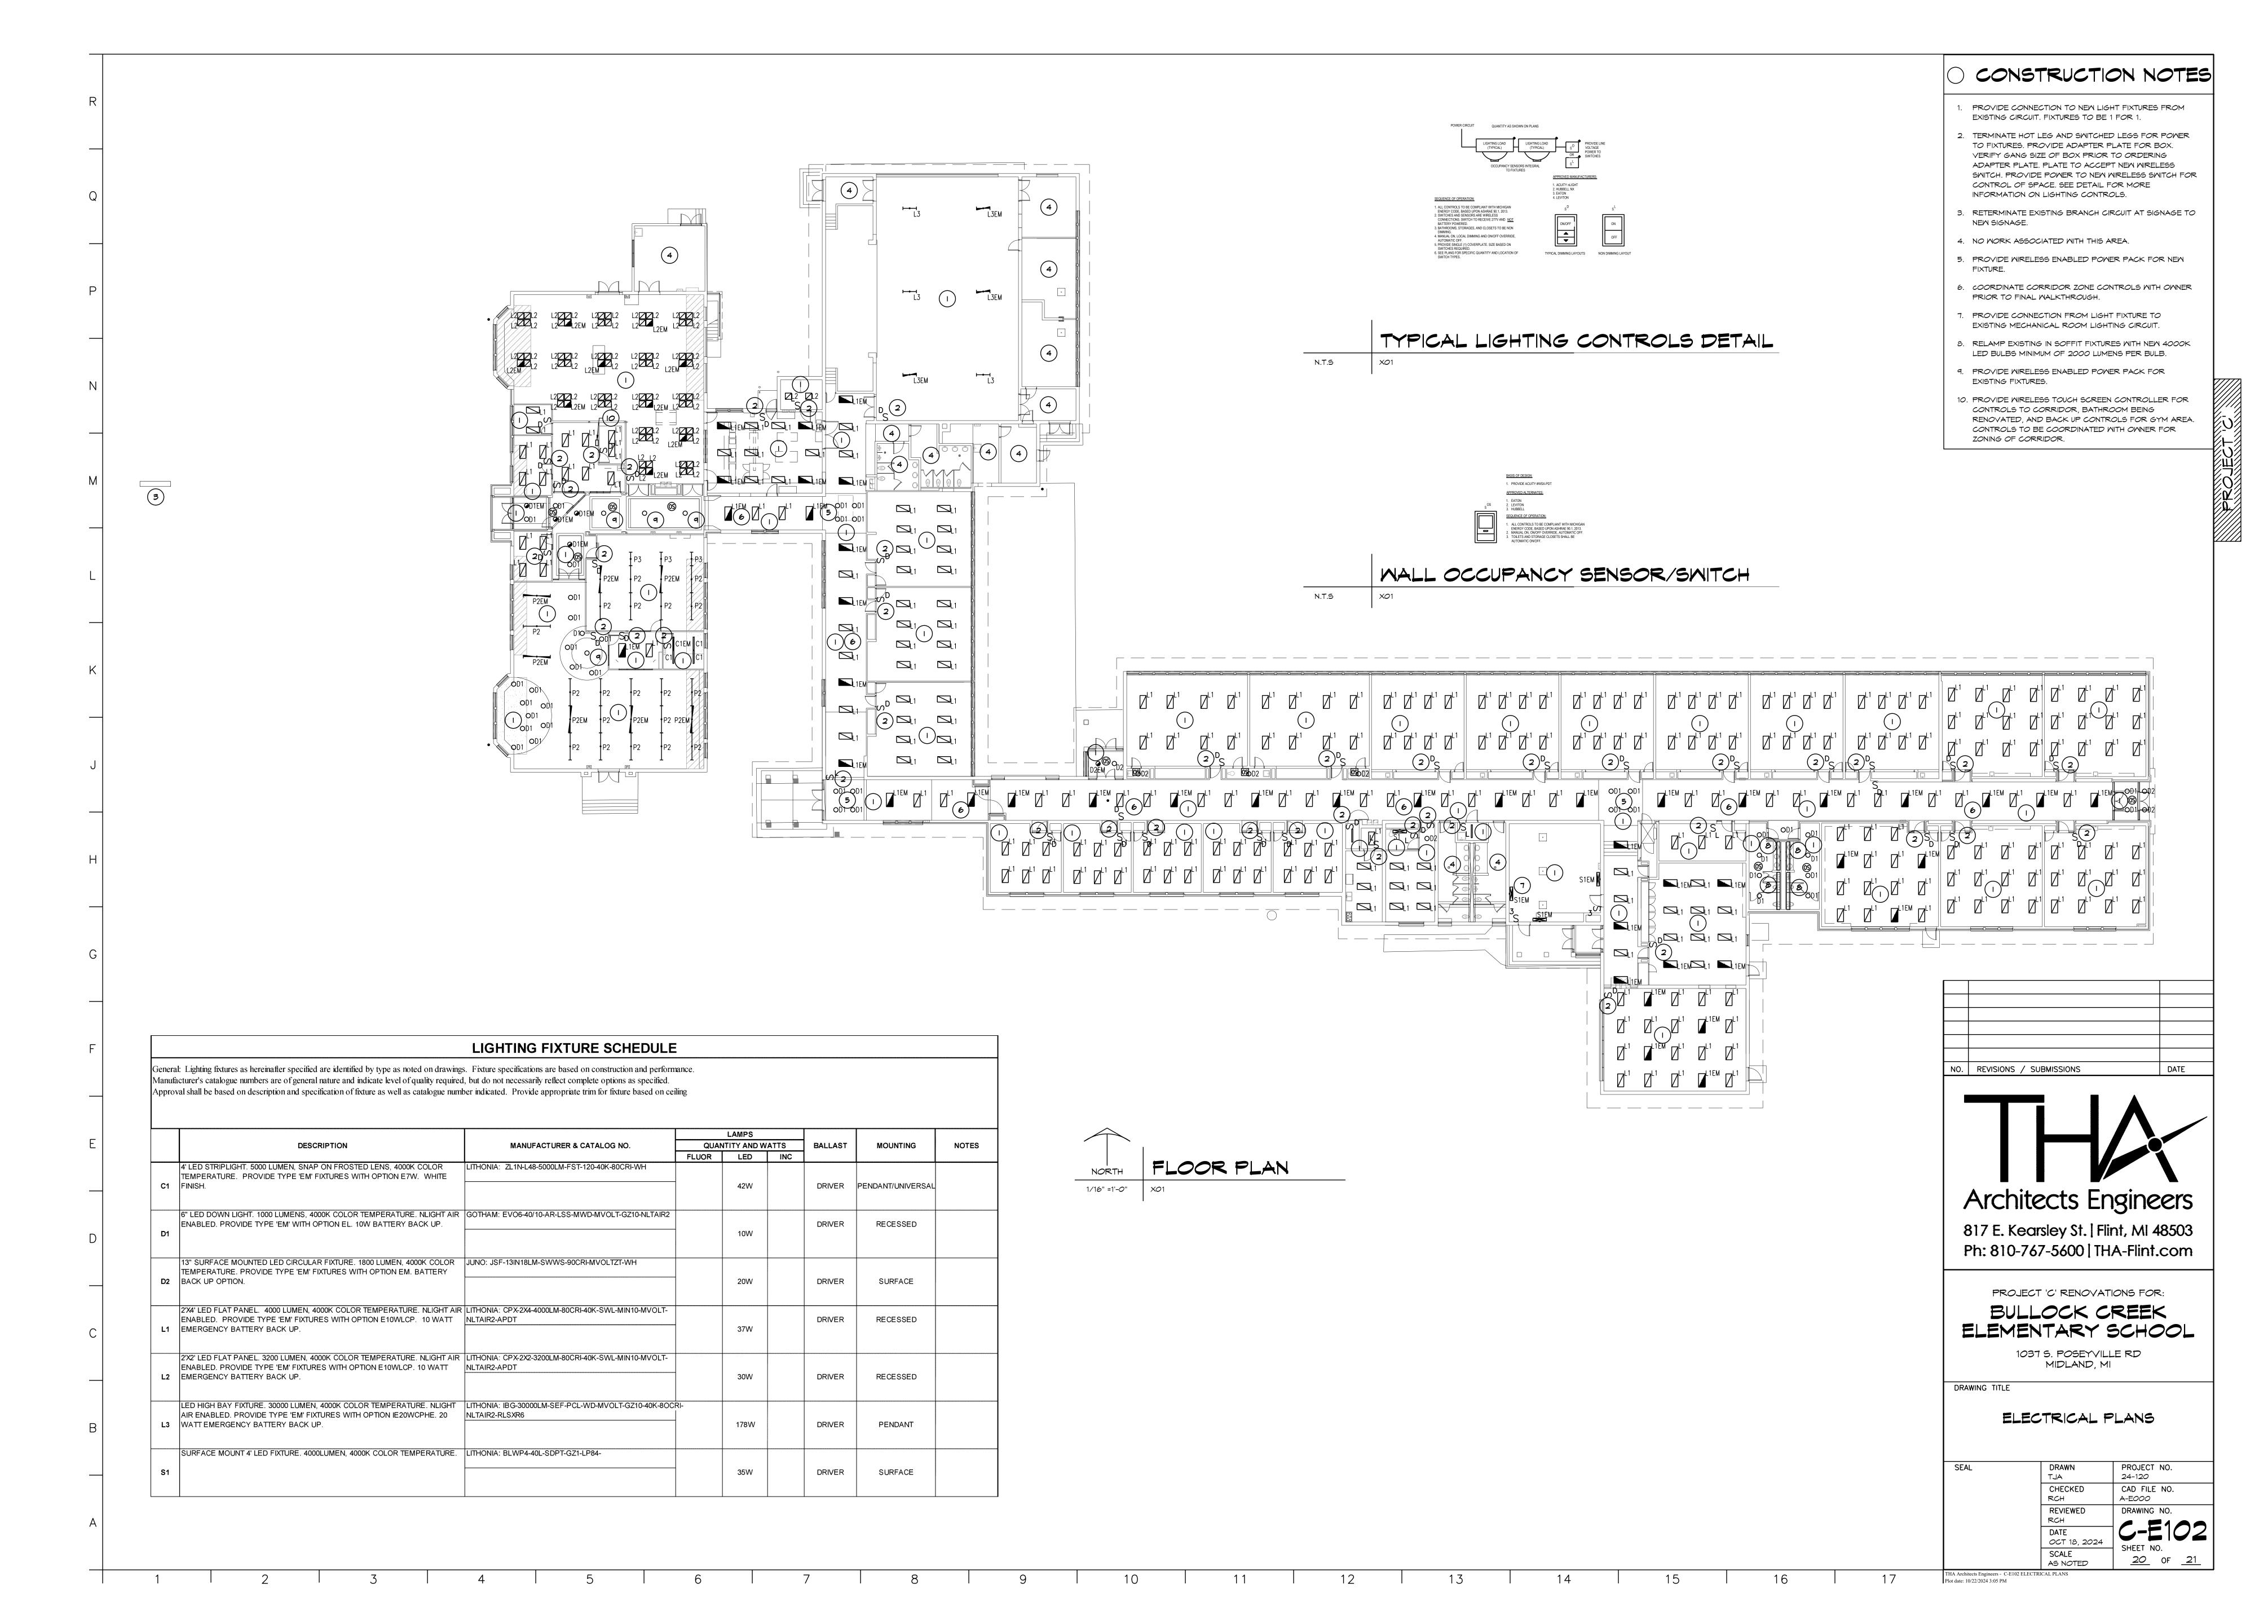

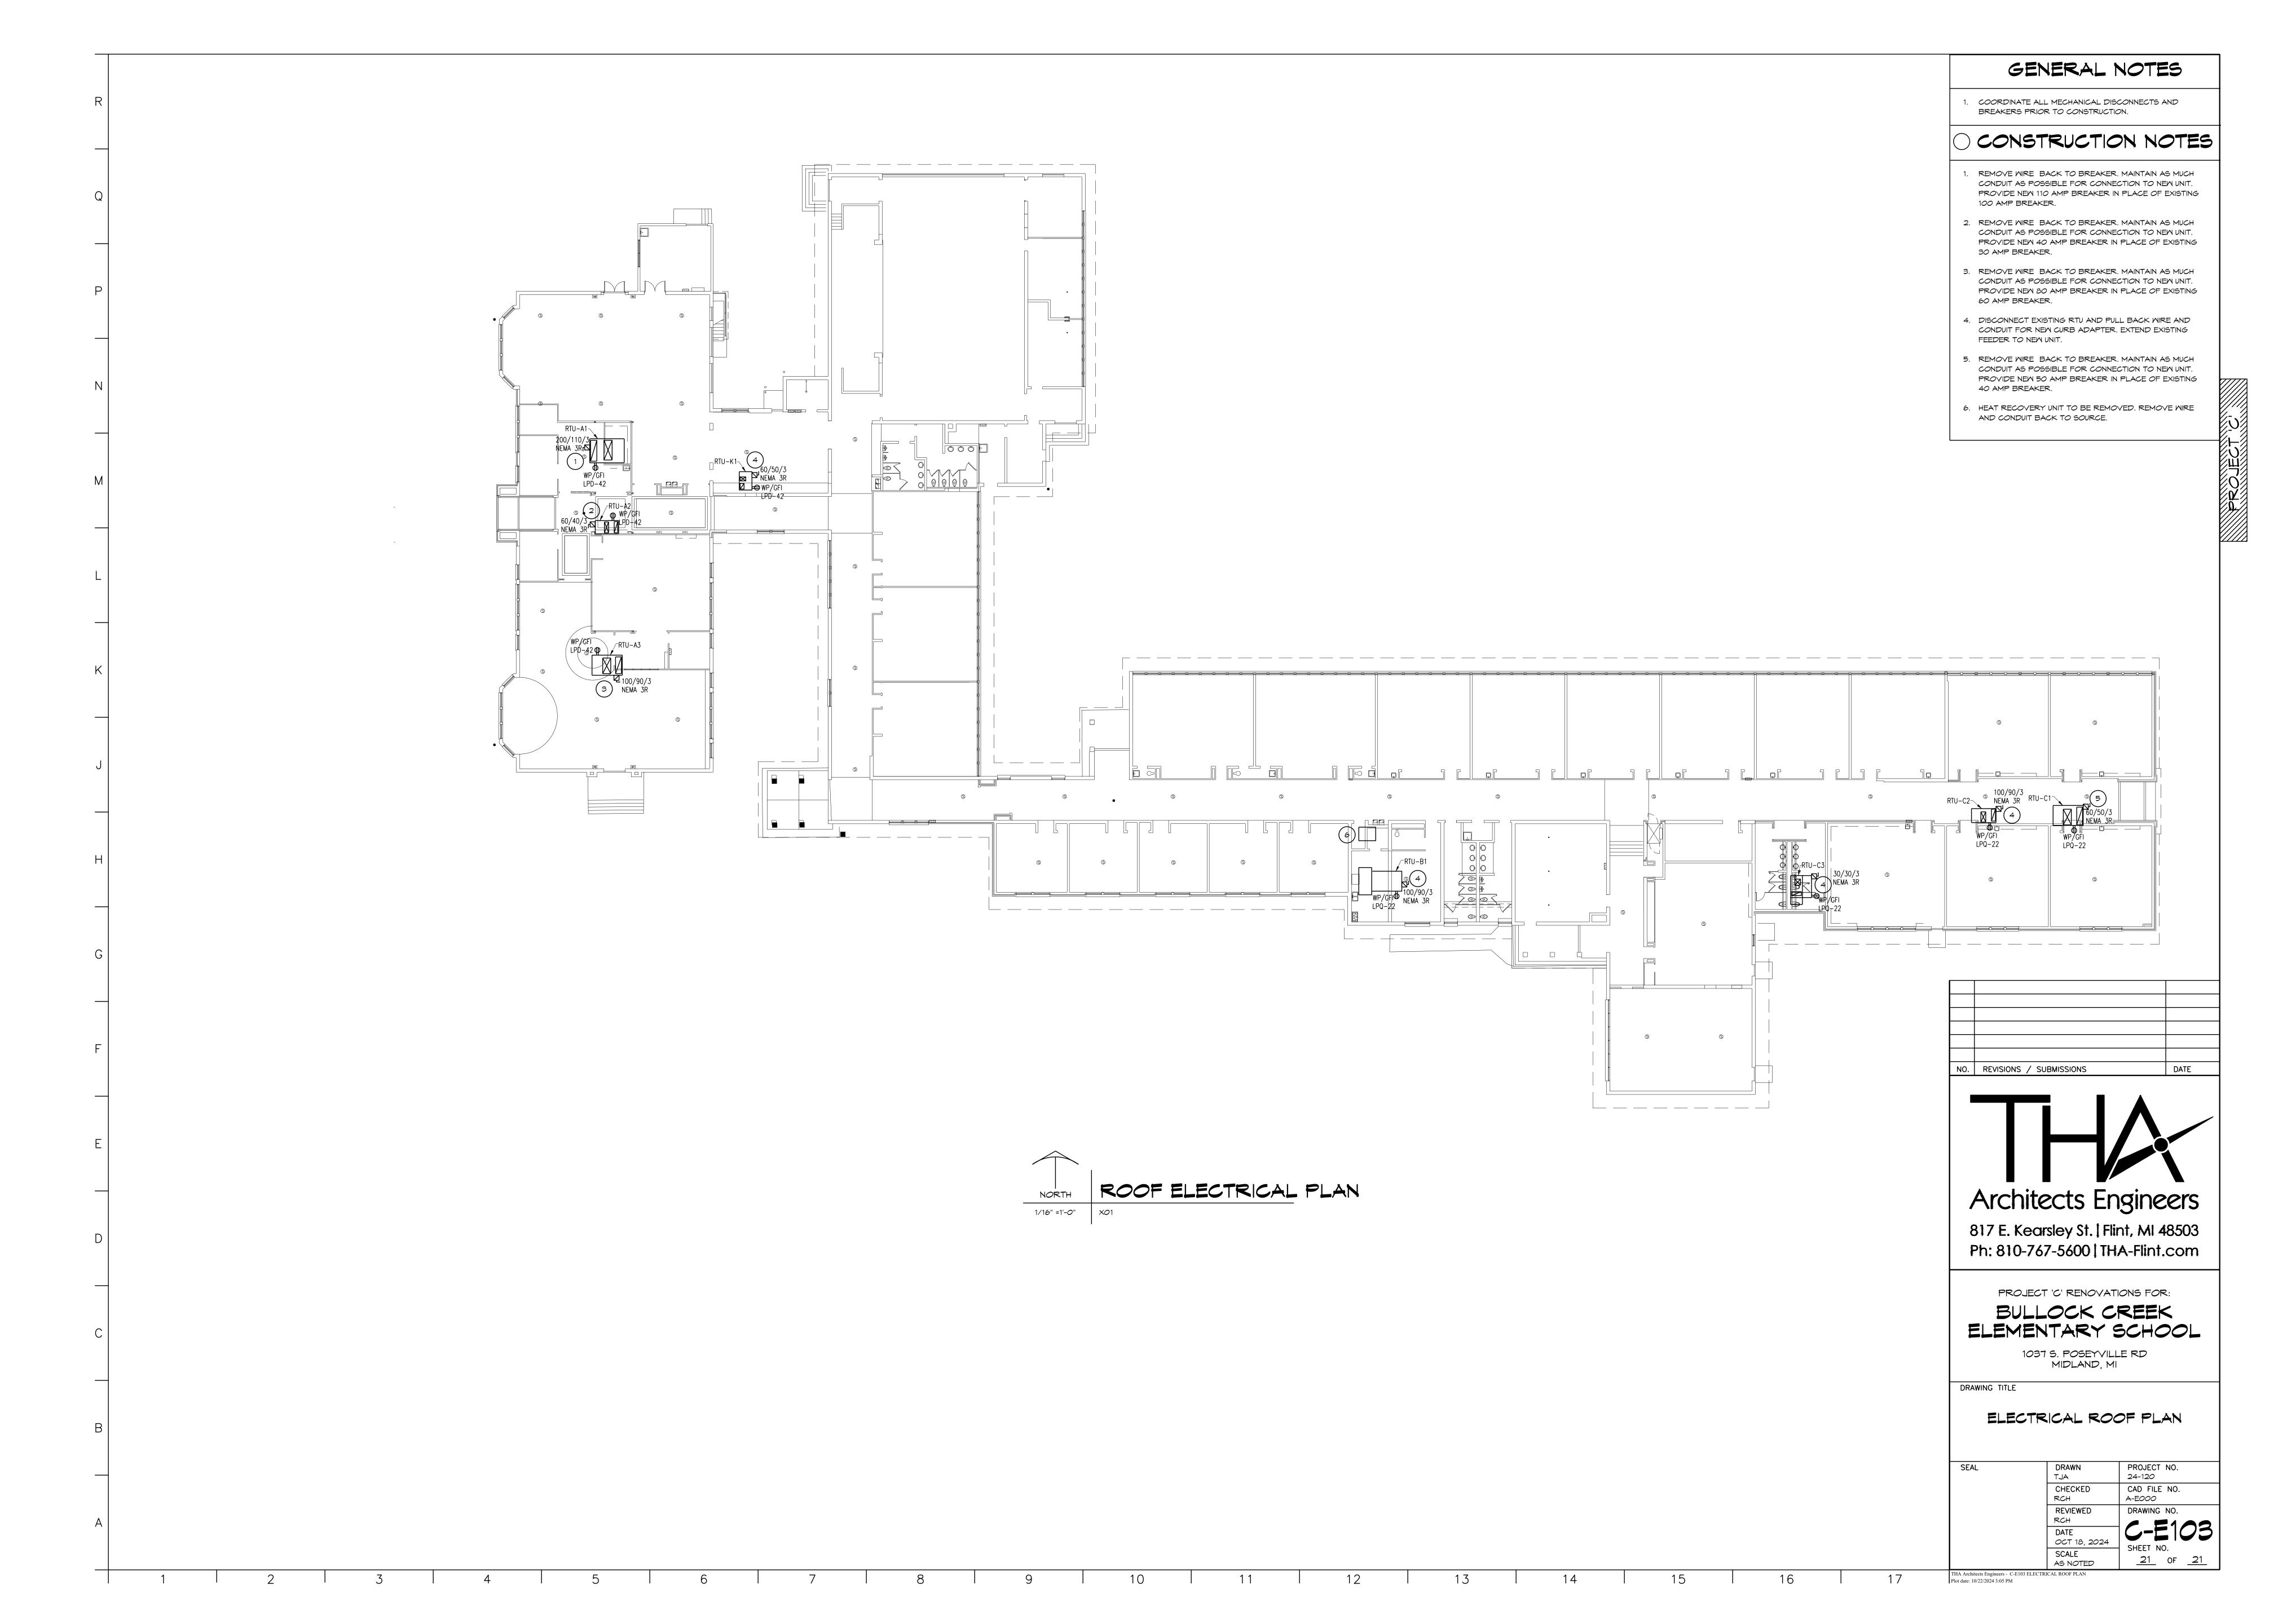

BULLOCK CREEK SCHOOL DISTRICT 2023 BOND- SERIES 1 2025 IMPROVEMENTS THA PROJECT #24-120

1420 SOUTH BADOUR ROAD MIDLAND, MI 48640

PROJECT 'D' RENOVATIONS TO: FLOYD ELEMENTARY SCHOOL

725 SOUTH EIGHT MILE ROAD MIDLAND, MI 48640


INDEX OF DRAWINGS

D-GOO1 TITLE SHEET


D-C101 SIGNAGE PLAN WITH ELECTRICAL AND ELEVATIONS

D-A101 ROOF DEMOLITION PLAN AND DETAILS

D-A102 ROOF PLAN AND DETAILS

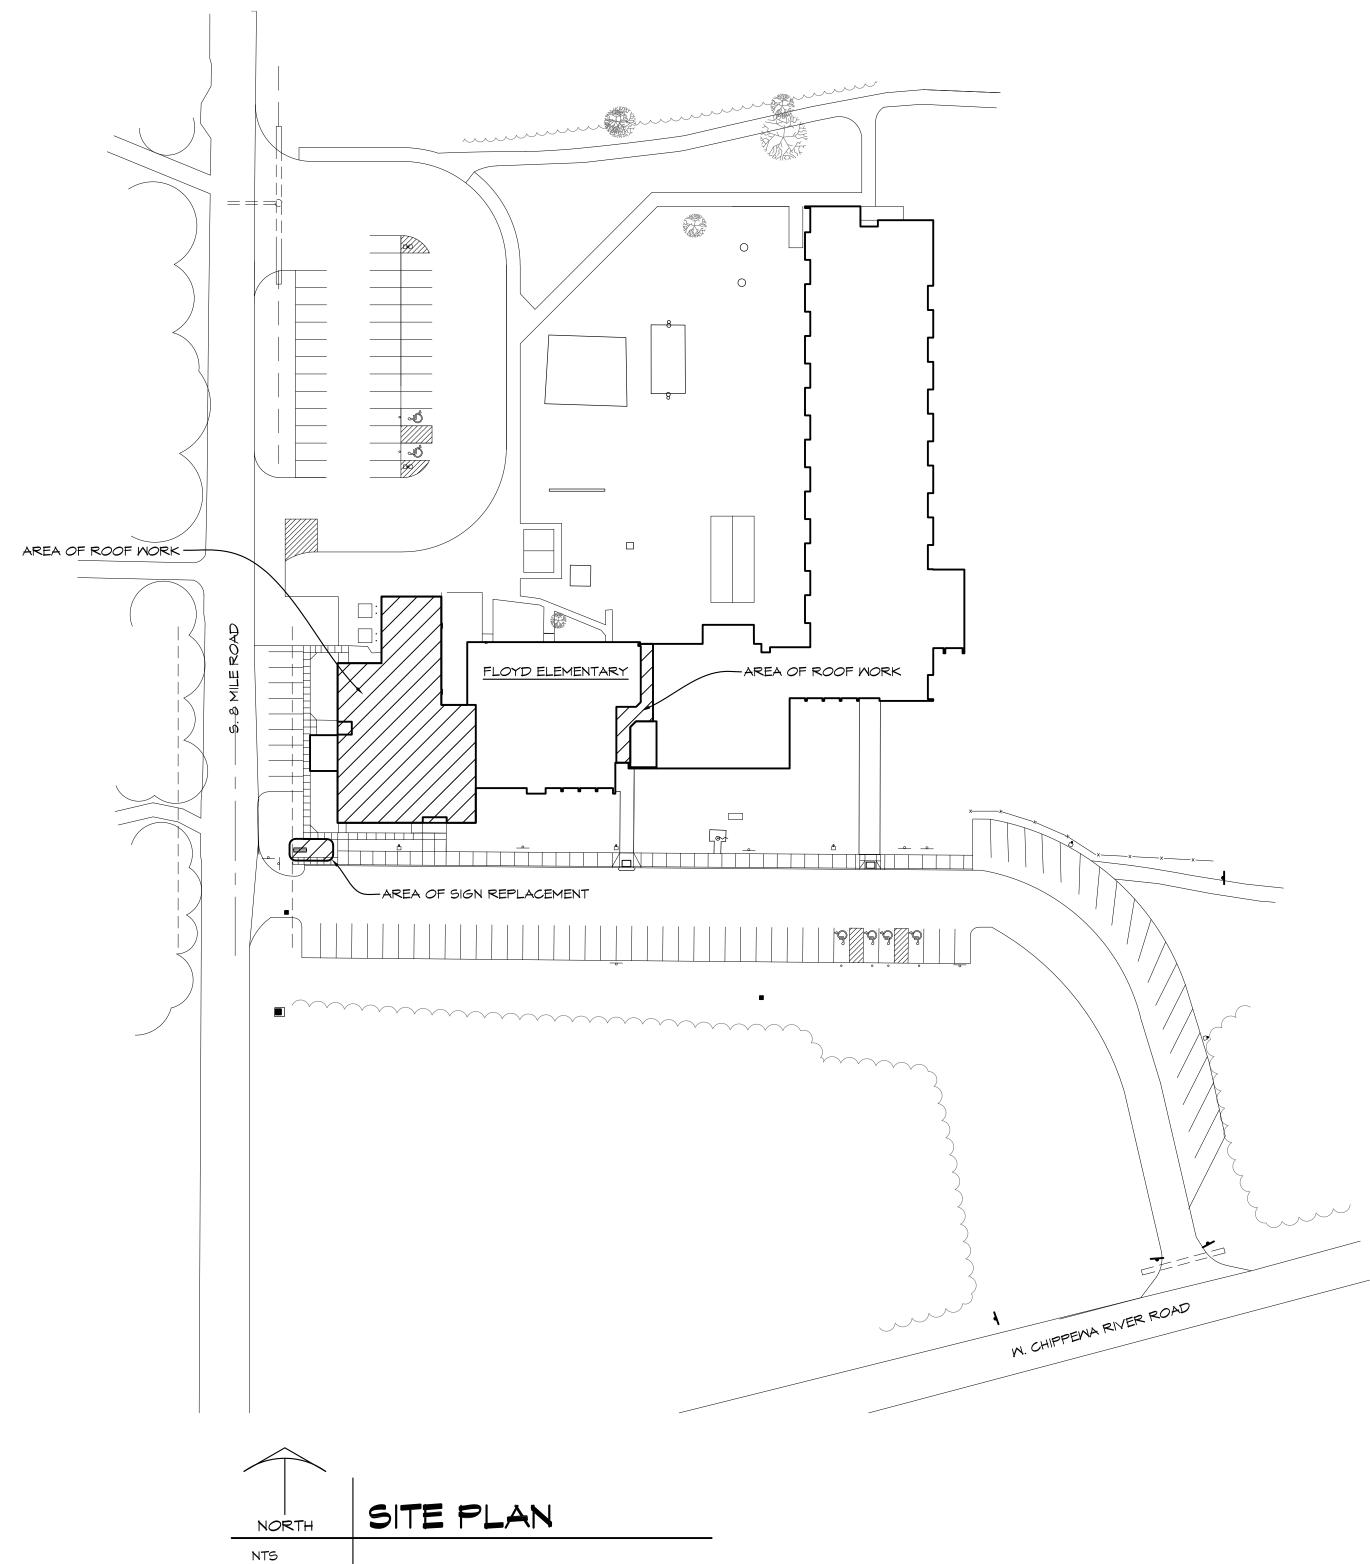



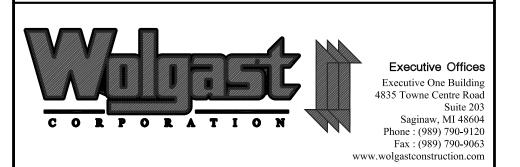

ROJECT 'D' ENOVATIONS TO: SOYD ELEMENTARY SCH

NO. REVISIONS / SUBMISSIONS

DRAWN
KRS

CHECKED
JESS

CHECKED
JESS

DATE

DRAWING NO.


REVIEWED
MLB

DATE
OCT 18, 2024
SCALE

SCALE

SCALE

Plot date: 10/23/2024 9:49 AM

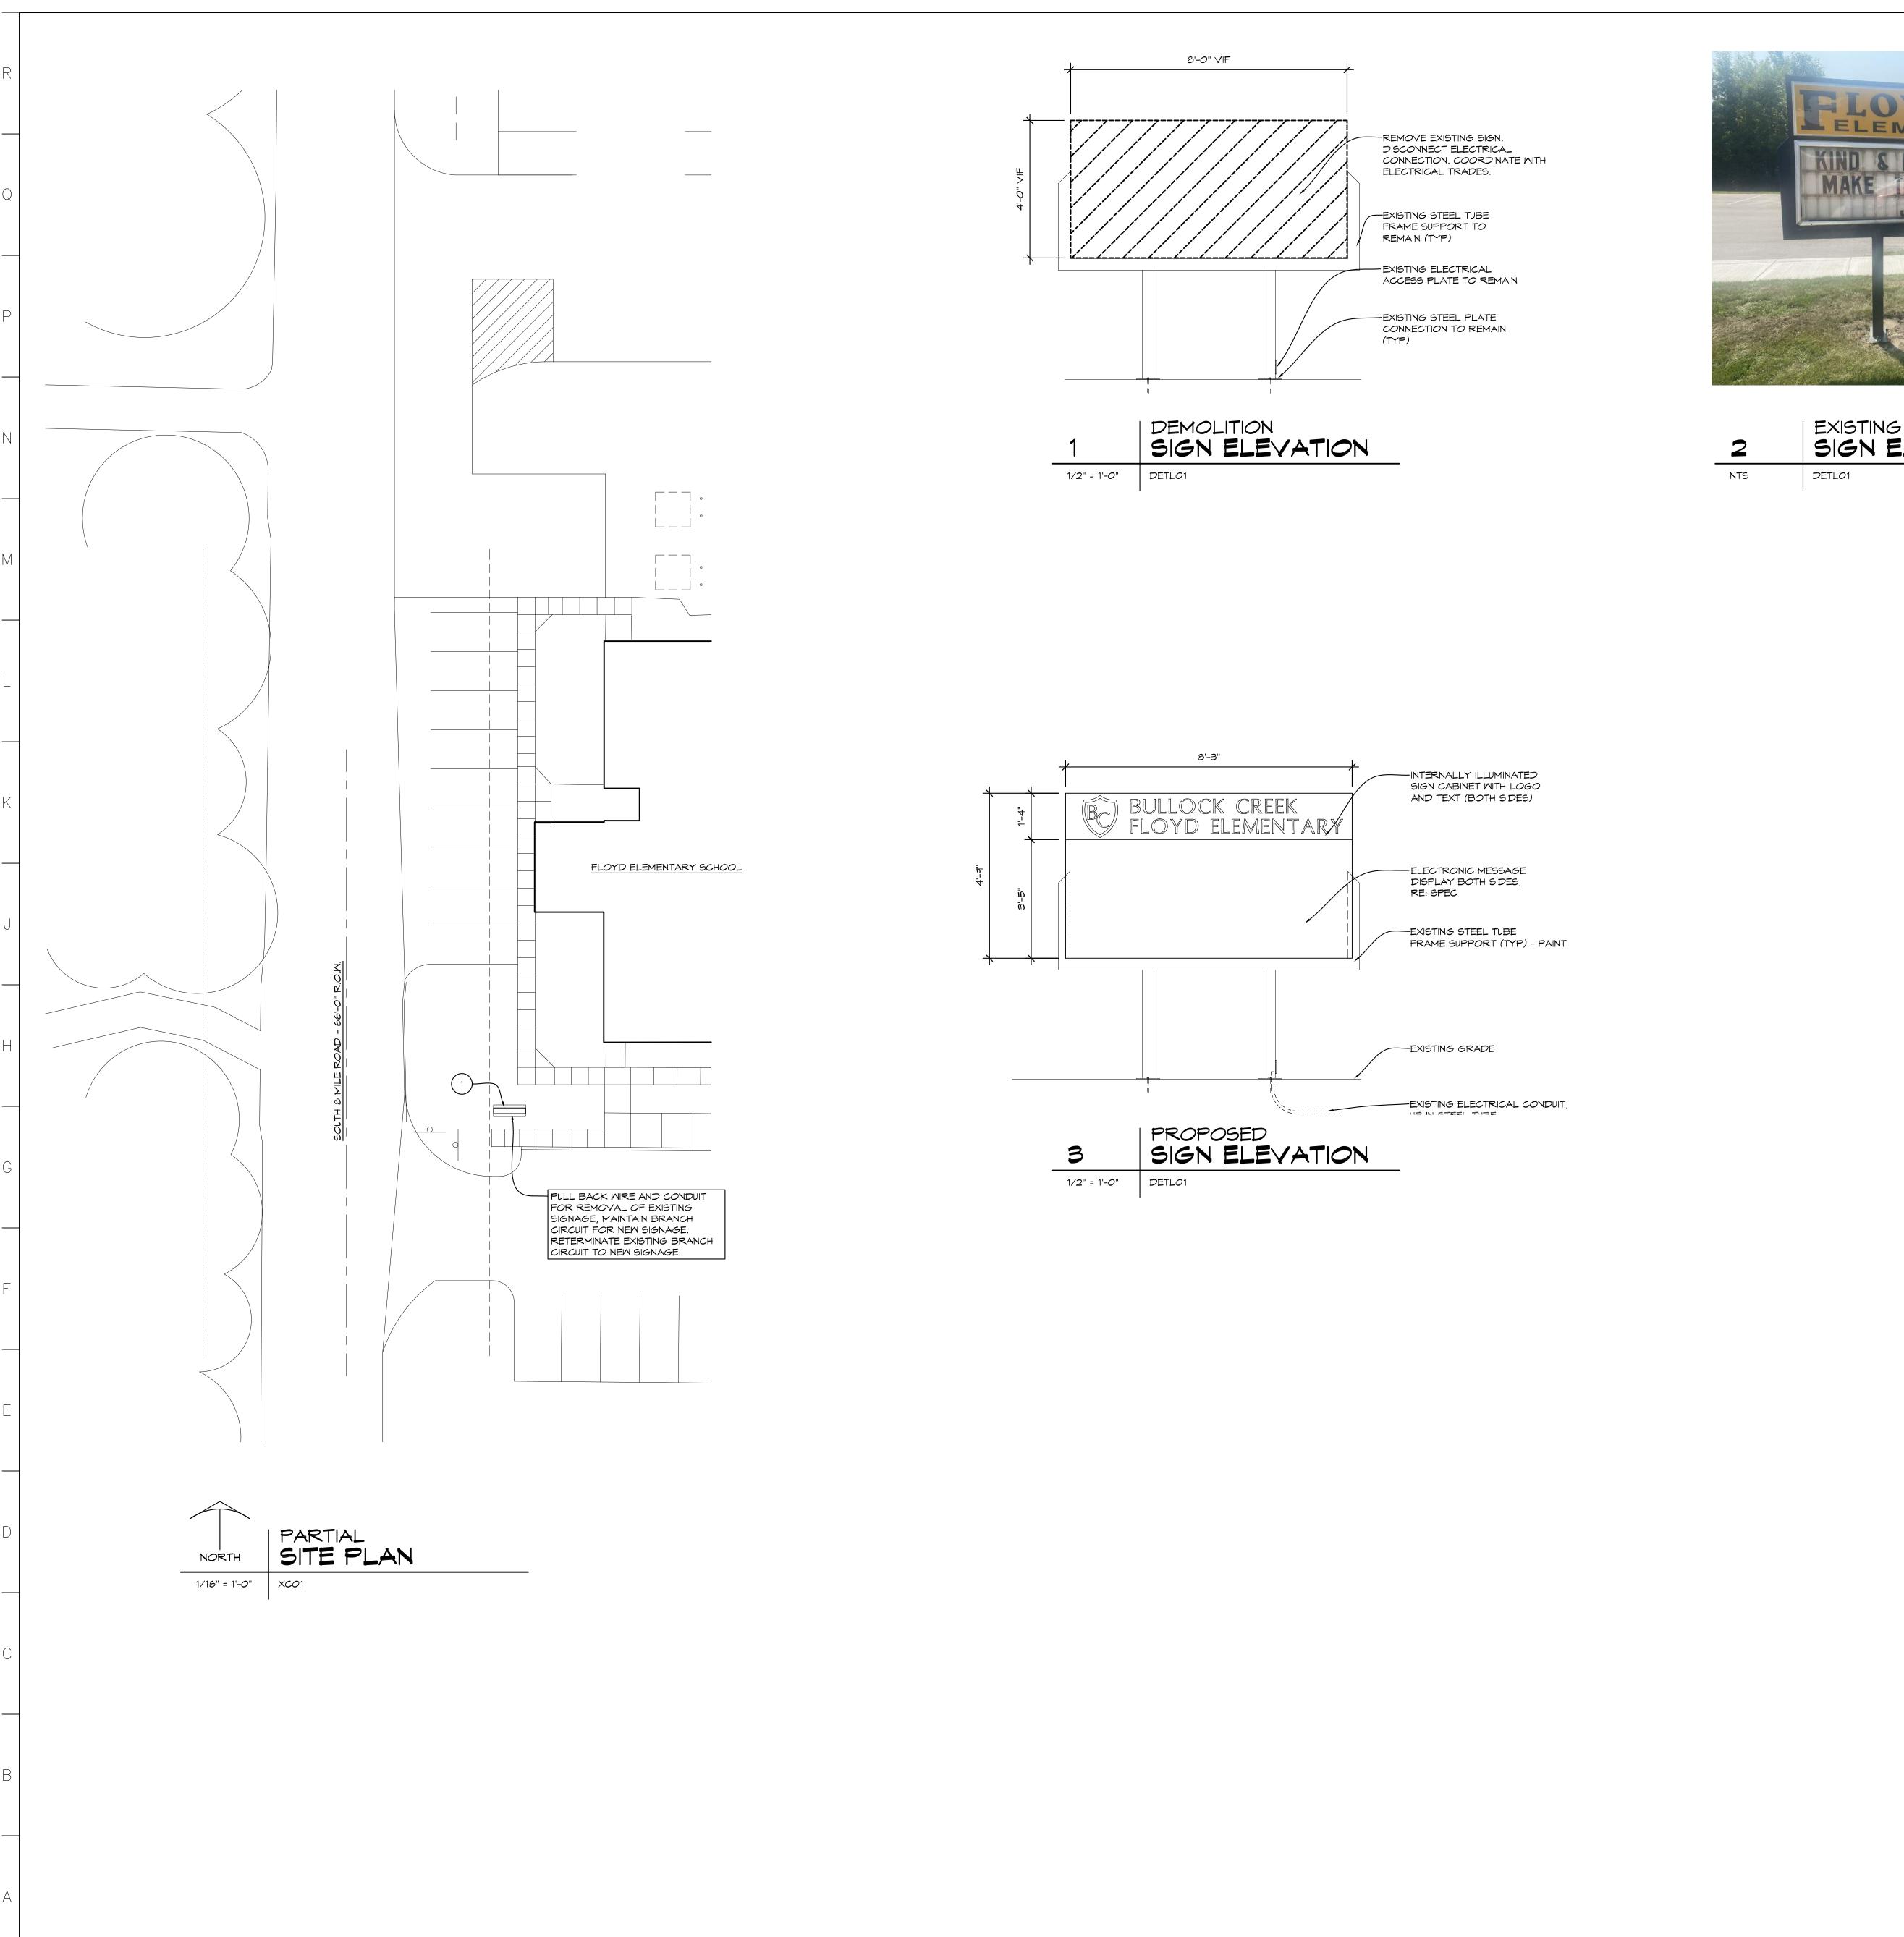



EXISTING SIGN ELEVATION

GENERAL DEMOLITION NOTES

- FIELD VERIFY ALL EXISTING CONDITIONS AND DIMENSIONS. NOTIFY DESIGN PROFESSIONAL OF ANY DISCREPANCIES PRIOR TO BEGINNING WORK. COORDINATE DEMOLITION WORK WITH NEW WORK SHOWN
- ON DRAWINGS. 2. OWNER HAS FIRST RIGHT OF REFUSAL ON ALL MATERIAL AND EQUIPMENT BEING REMOVED
- 3. COORDINATE ALL WORK WITH MECHANICAL AND ELECTRICAL TRADES. VERIFY EXACT SIZE AND LOCATION OF ALL WALL, FLOOR AND ROOF OPENINGS REQUIRED OF THESE AND OTHER TRADES. 4. REPAIR ALL WALLS, FLOORS AND CEILINGS AT ALL
- AREAS DISTURBED BY DEMOLITION TO MATCH EXISTING FINISHES, UNLESS NOTED OTHERWISE. COORDINATE WITH MECHANICAL AND ELECTRICAL TRADES. 5. AT AREAS OF DEMOLITION, CONTRACTOR IS
- RESPONSIBLE FOR REMOVING, CAPPING AND DISCONNECTING ALL INCIDENTAL ITEMS. 6. CONTRACTOR SHALL BE RESPONSIBLE FOR PROVIDING ALL NECESSARY TEMPORARY BRACING AND/OR
- SHORING REQUIRED TO MAINTAIN THE INTEGRITY AND STRUCTURAL STABILITY OF THE BUILDING AND IT'S ELEMENTS.
- 1. CONTRACTOR SHALL PROVIDE TEMPORARY PROTECTION FOR ALL COMPONENTS OF THE BUILDING DURING CONSTRUCTION TO PREVENT DAMAGE, INCLUDING WEATHERPROOFING AT ALL OPENINGS.
- 8. NOTATIONS ARE MADE IN VARIOUS PLACES ON THE DRAWING TO CALL ATTENTION TO DEMOLITION WHICH IS REQUIRED, HOWEVER, THESE DRAWINGS ARE NOT INTENDED TO SHOW EACH AND EVERY ITEM TO BE REMOVED. THE CONTRACTOR AND THE SUBCONTRACTORS FOR THE VARIOUS TRADES SHALL REMOVE THE MATERIALS RELATED TO THEIR RESPECTIVE TRADES ASA REQUIRED TO PERMIT THE CONSTRUCTION OF THE NEW MORK AS SHOWN.

9. SEE MECHANICAL AND ELECTRICAL DRAWINGS FOR

ADDITIONAL DEMOLITION WORK.

CONSTRUCTION NOTES

REMOVE PORTION OF EXISTING BUILDING SIGN. EXISTING POST STRUCTURE AND FOUNDATION TO REMAIN. INSTALL NEW BUILDING SIGN ON EXISTING STRUCTURE. REFER TO ELEVATIONS ON THIS SHEET.

NO. REVISIONS / SUBMISSIONS

Architects Engineers

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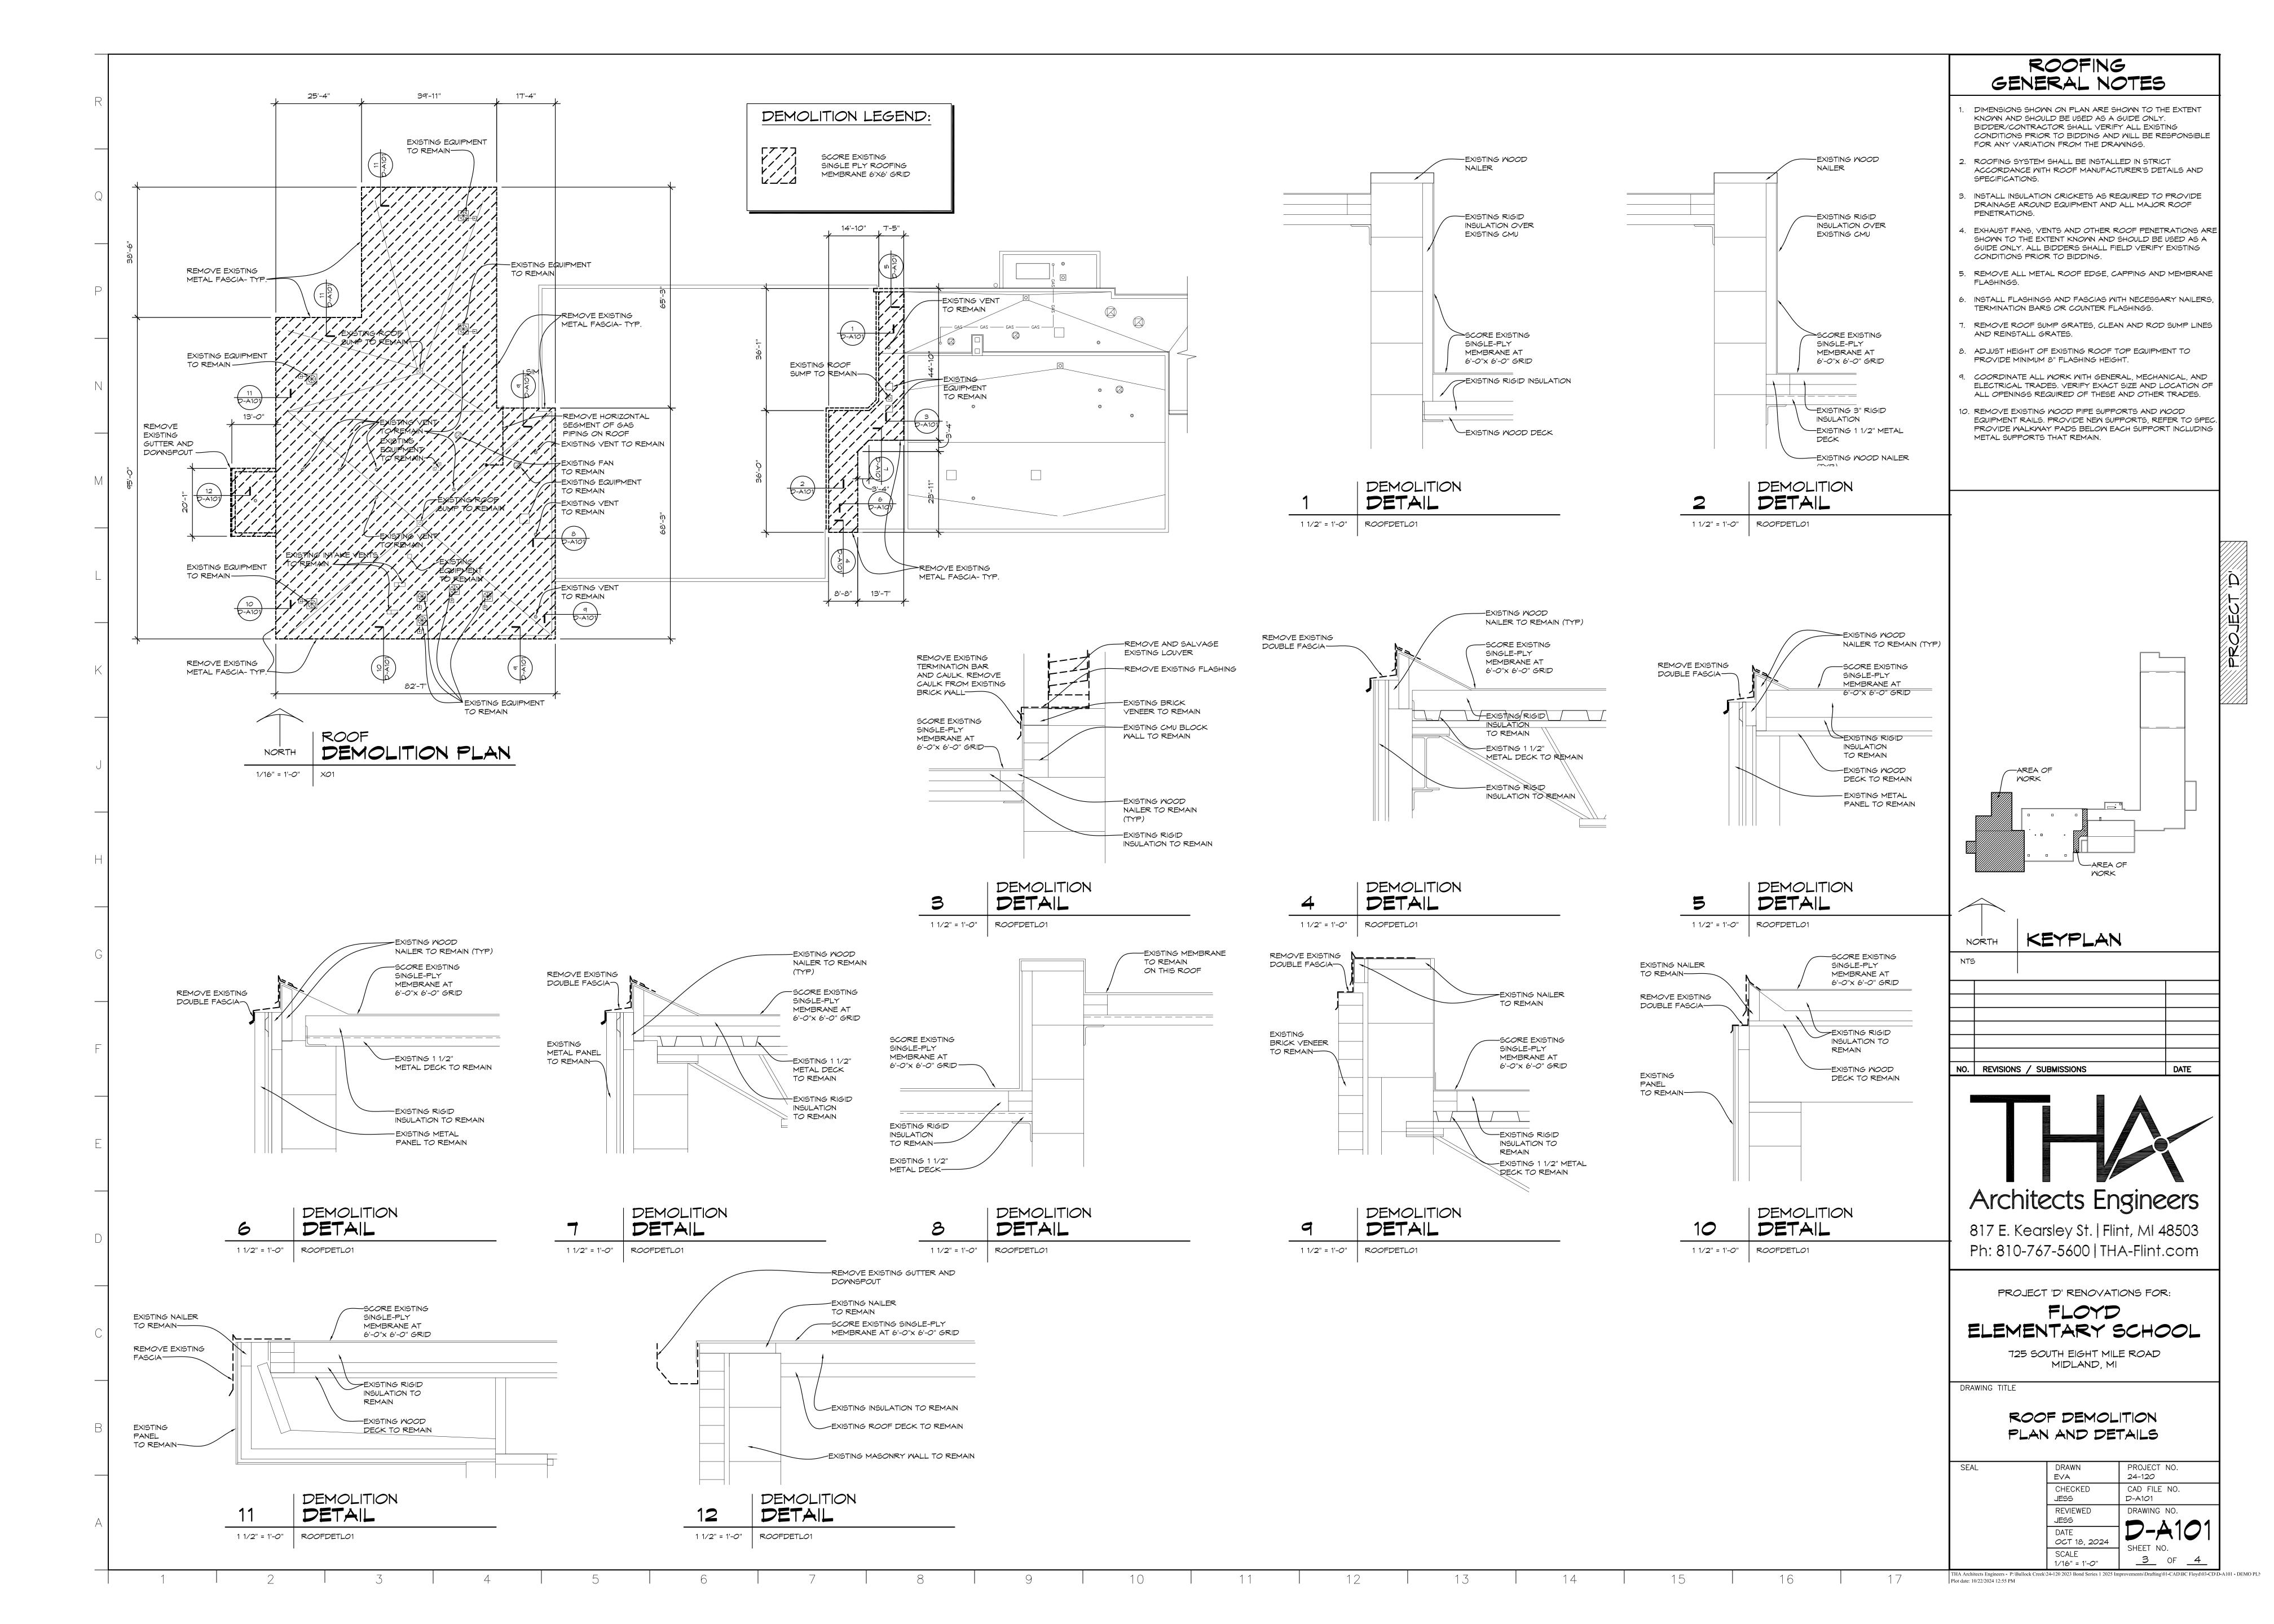
PROJECT 'D' RENOVATIONS FOR:


FLOYD ELEMENTARY SCHOOL

725 SOUTH EIGHT MILE ROAD MIDLAND, MI

SIGNAGE PLAN WITH ELECTRICAL AND ELEVATIONS

PROJECT NO. 24-120 EVA CHECKED CAD FILE NO. REVIEWED DATE OCT 18, 2024 SCALE AS NOTED



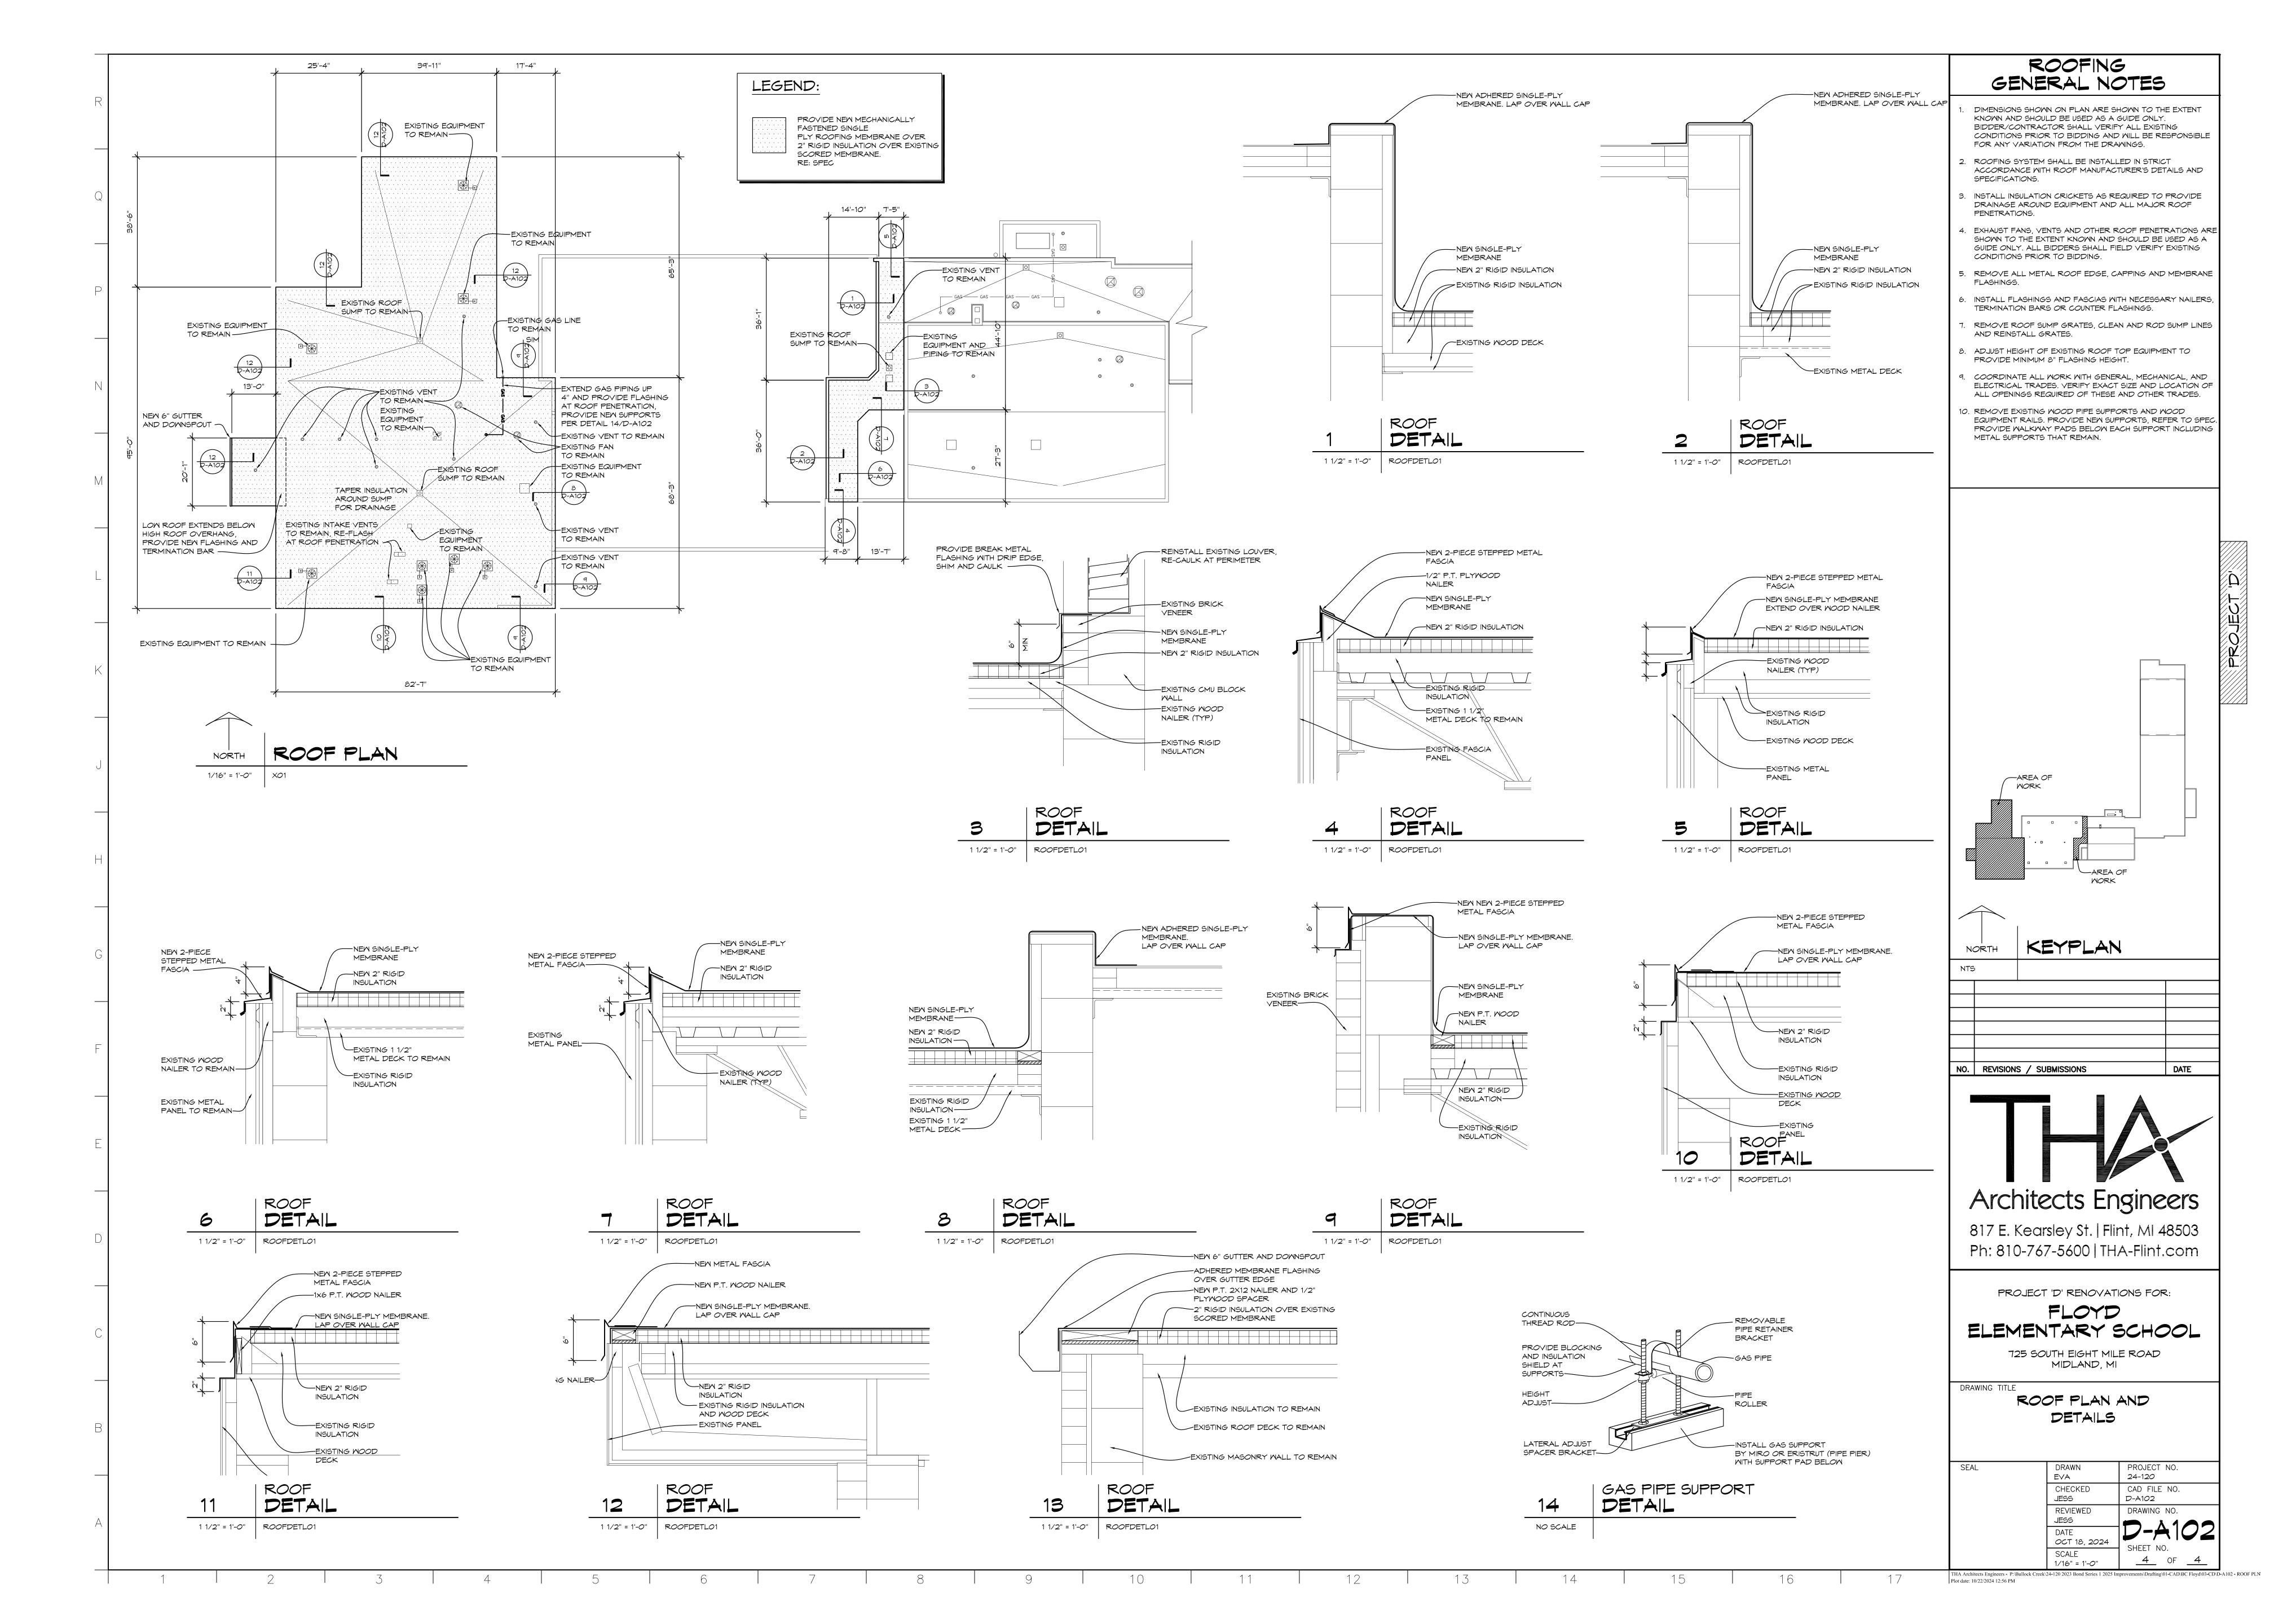


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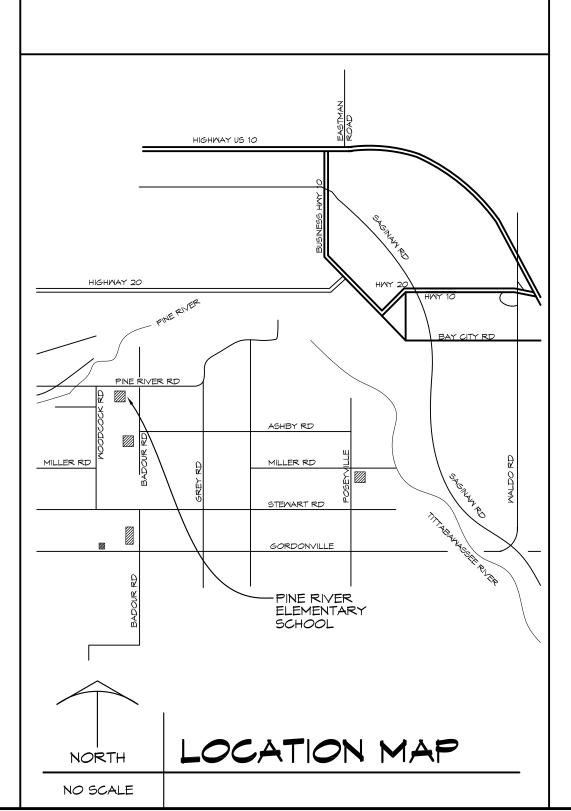



NO. | REVISIONS / SUBMISSIONS




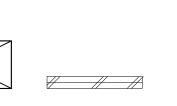



ANY PENETRATIONS OF CORRIDOR WALLS MUST MAINTAIN 1-HOUR FIRE RATING AND RESIST THE PASSAGE OF SMOKE



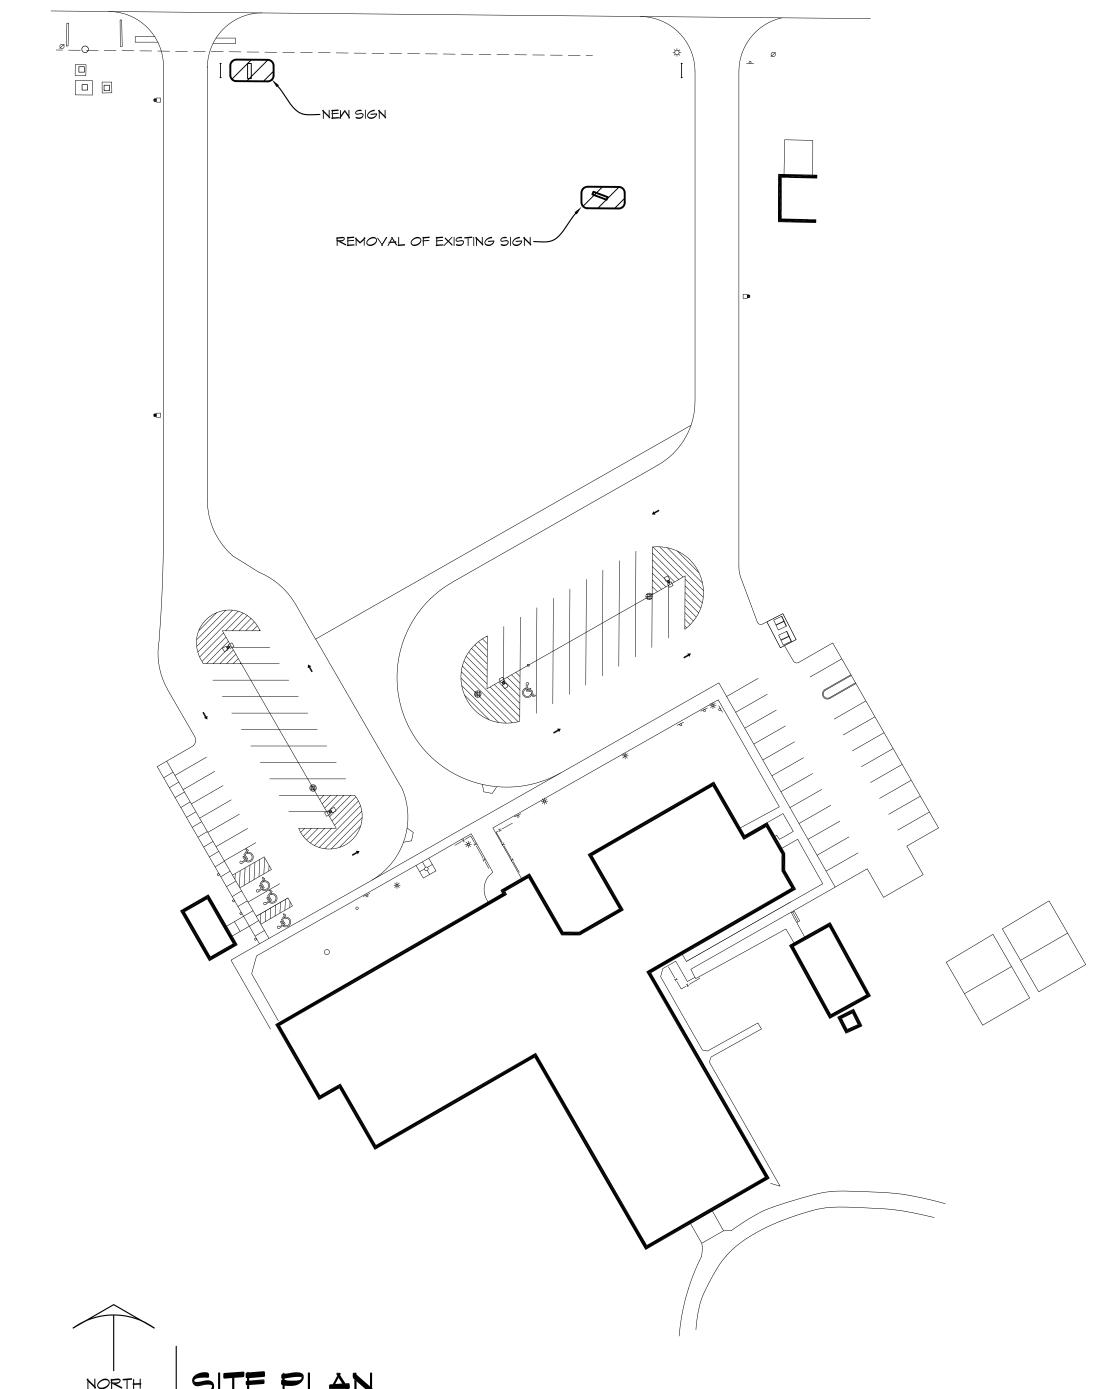

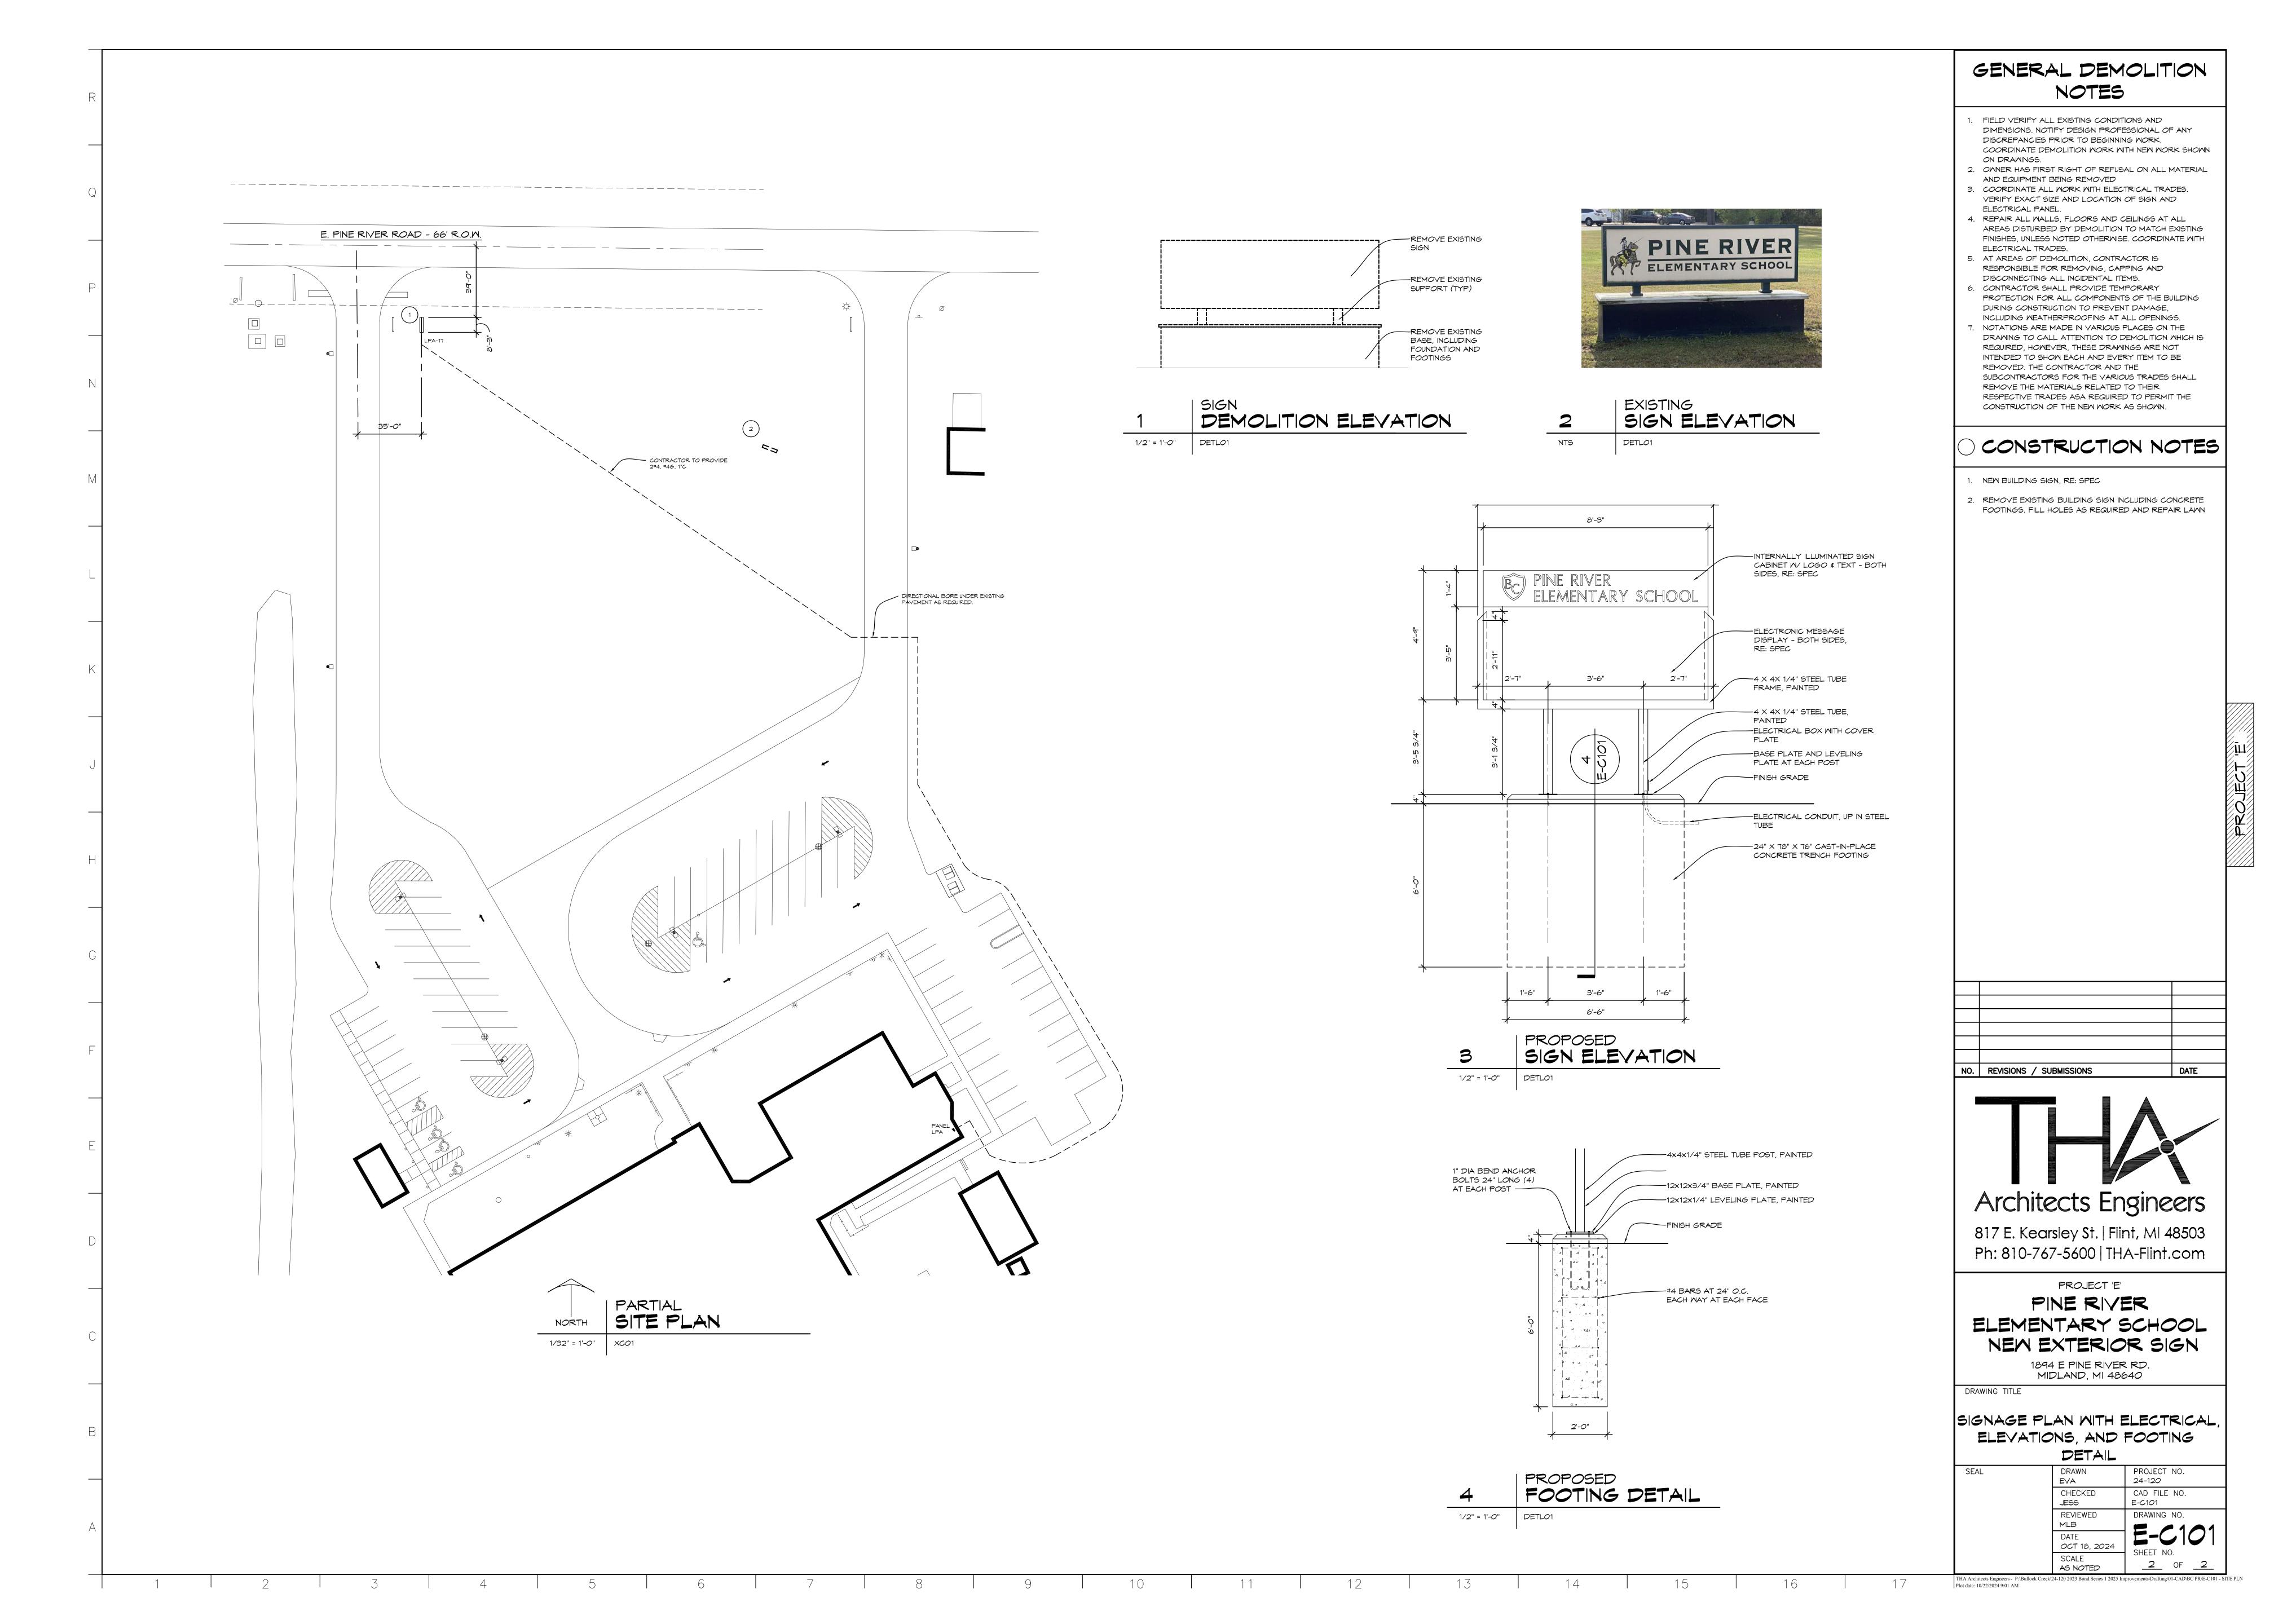

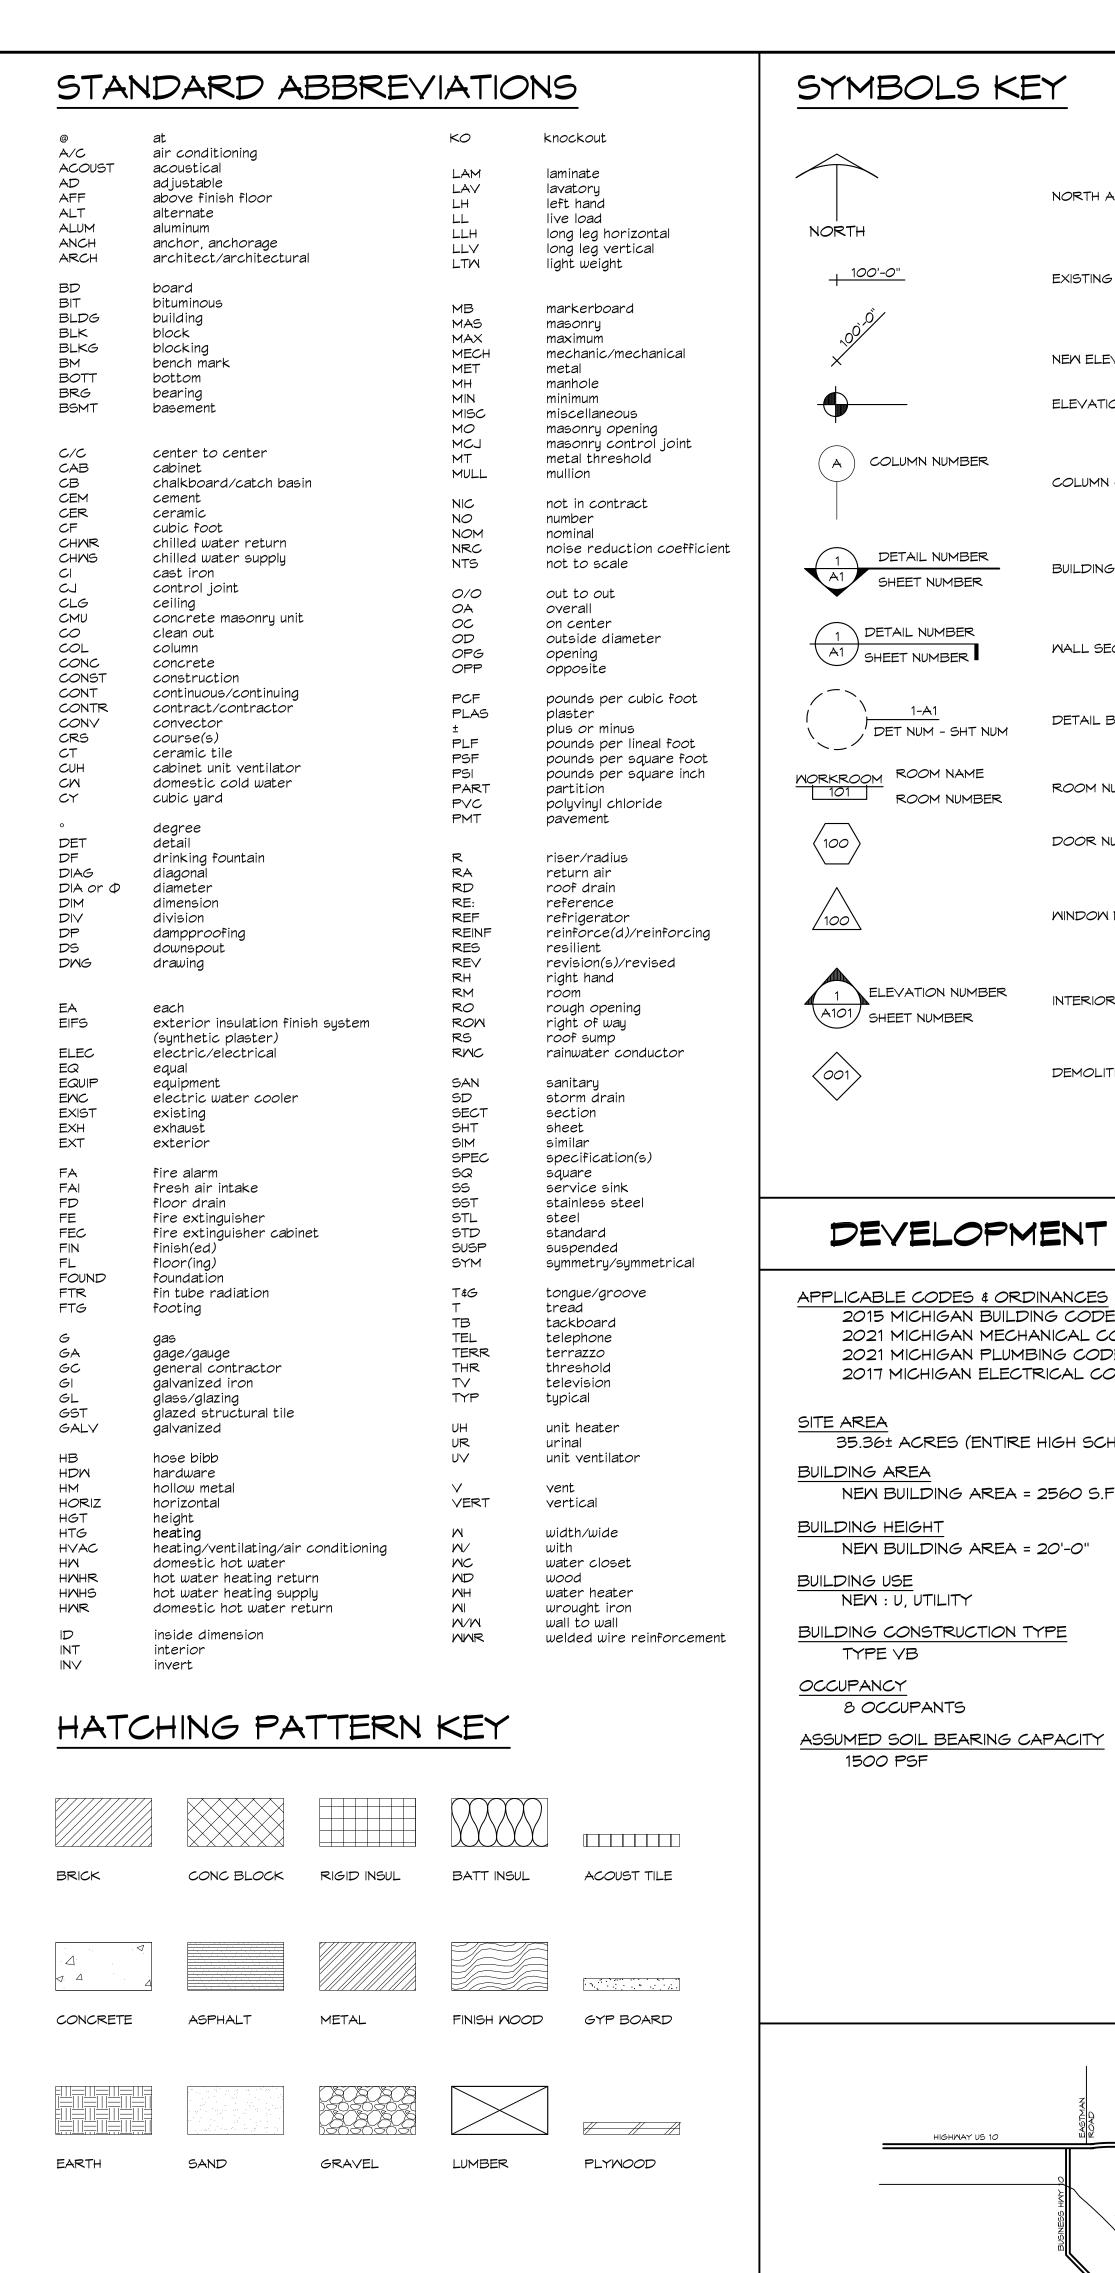

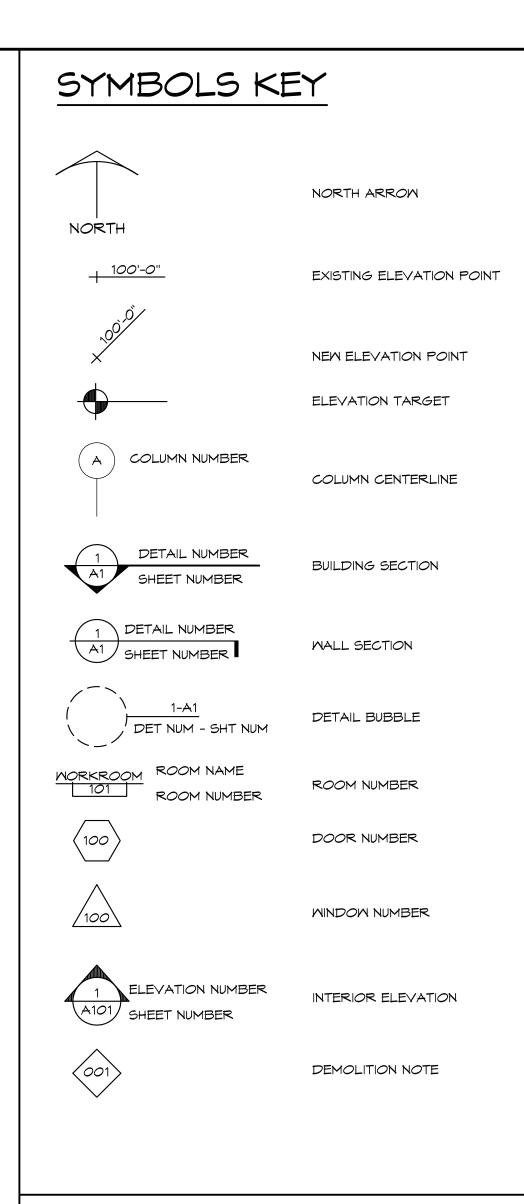



DEVELOPMENT DATA

2021 MICHIGAN MECHANICAL CODE 2021 MICHIGAN PLUMBING CODE 2017 MICHIGAN ELECTRICAL CODE

35.36± ACRES (ENTIRE HIGH SCHOOL SITE) NEW BUILDING AREA = 2560 S.F.

NEW BUILDING AREA = 20'-0"

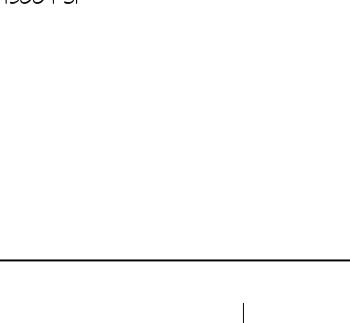

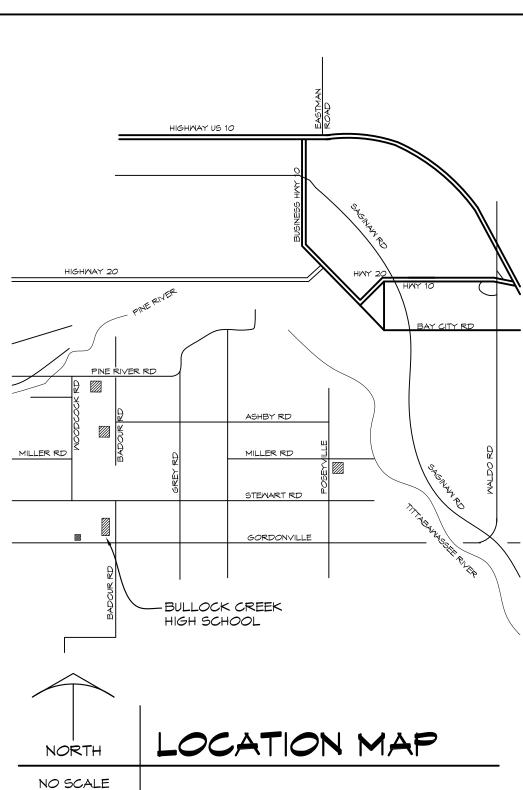

BULLOCK CREEK SCHOOL DISTRICT 2023 BOND- SERIES 1 2025 IMPROVEMENTS THA PROJECT #24-120

1420 SOUTH BADOUR ROAD MIDLAND MI 48640

PROJECT 'F' SITE WORK AT MAINTENANCE BUILDING & NEW POLE BARN

1420 SOUTH BADOUR ROAD MIDLAND MI 48640

INDEX OF DRAWINGS

F-G001 TITLE SHEET

SITE DEMOLITION PLAN SITE DEVELOPMENT PLAN

MAINTENANCE BUILDING SITE DEVELOPMENT PLAN

F-C104 SESC PLANS

POLE BARN PLANS AND ELEVATIONS

F-A102 POLE BARN SECTIONS

F-A103 POLE BARN ENLARGED DETAILS

F-A104 MAINTENANCE BUILDING PARTIAL DEMOLITION PLAN,


PARTIAL FLOOR PLAN AND DETAIL

POLE BARN PLUMBING PLAN

F-E000 ELECTRICAL COVER SHEET

F-E101 SITE ELECTRICAL DEMOLITION PLAN

F-E102 SITE ELECTRICAL PLAN

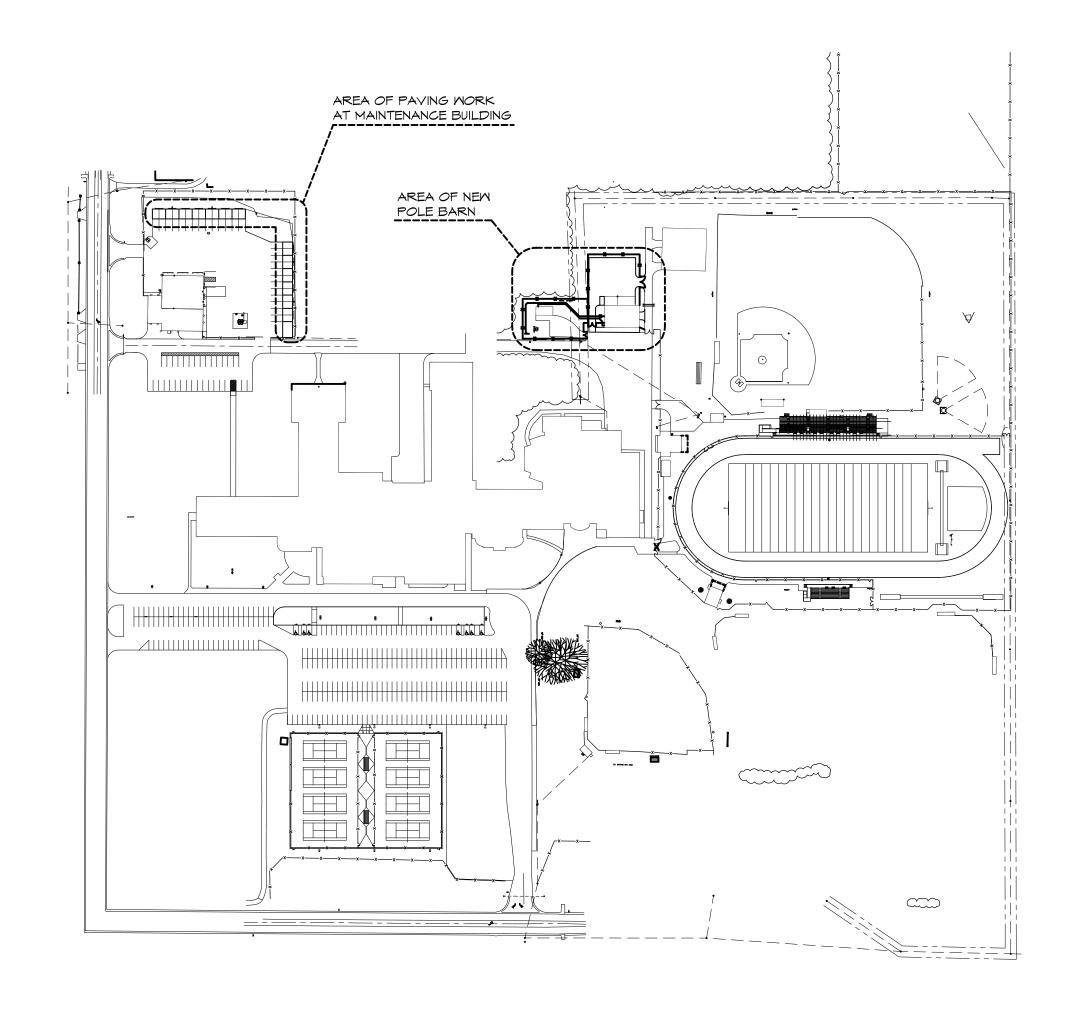









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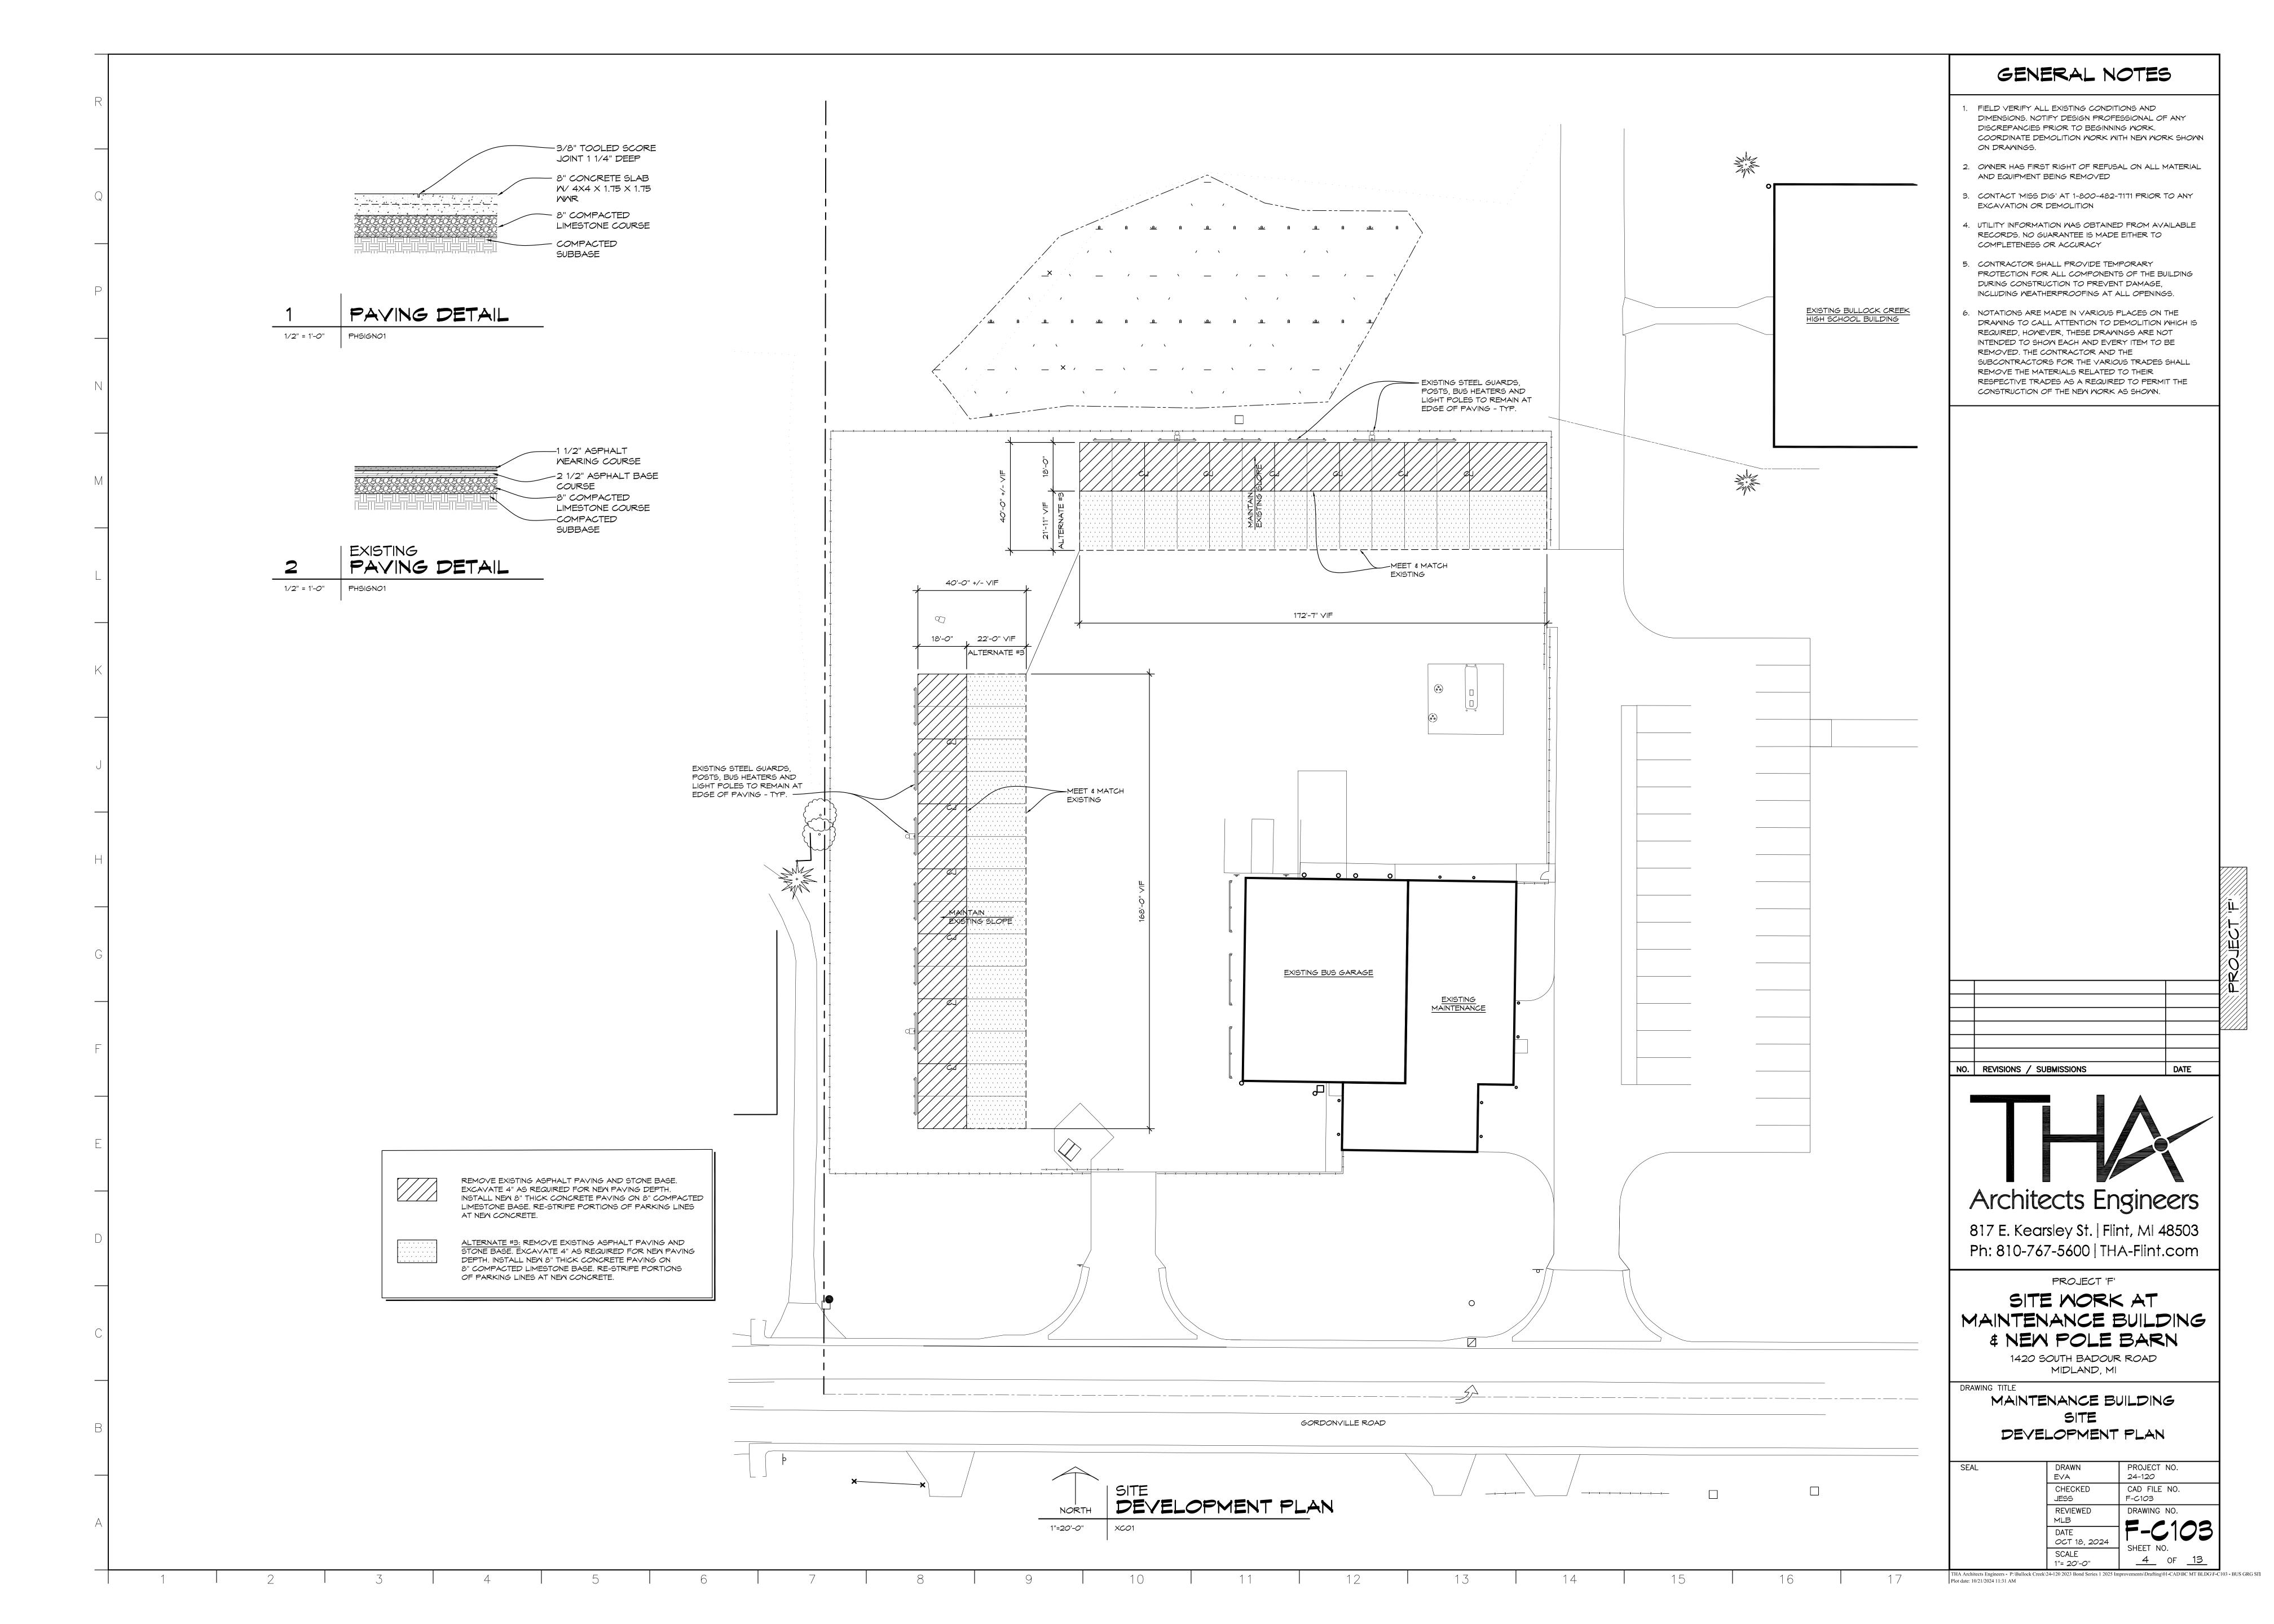
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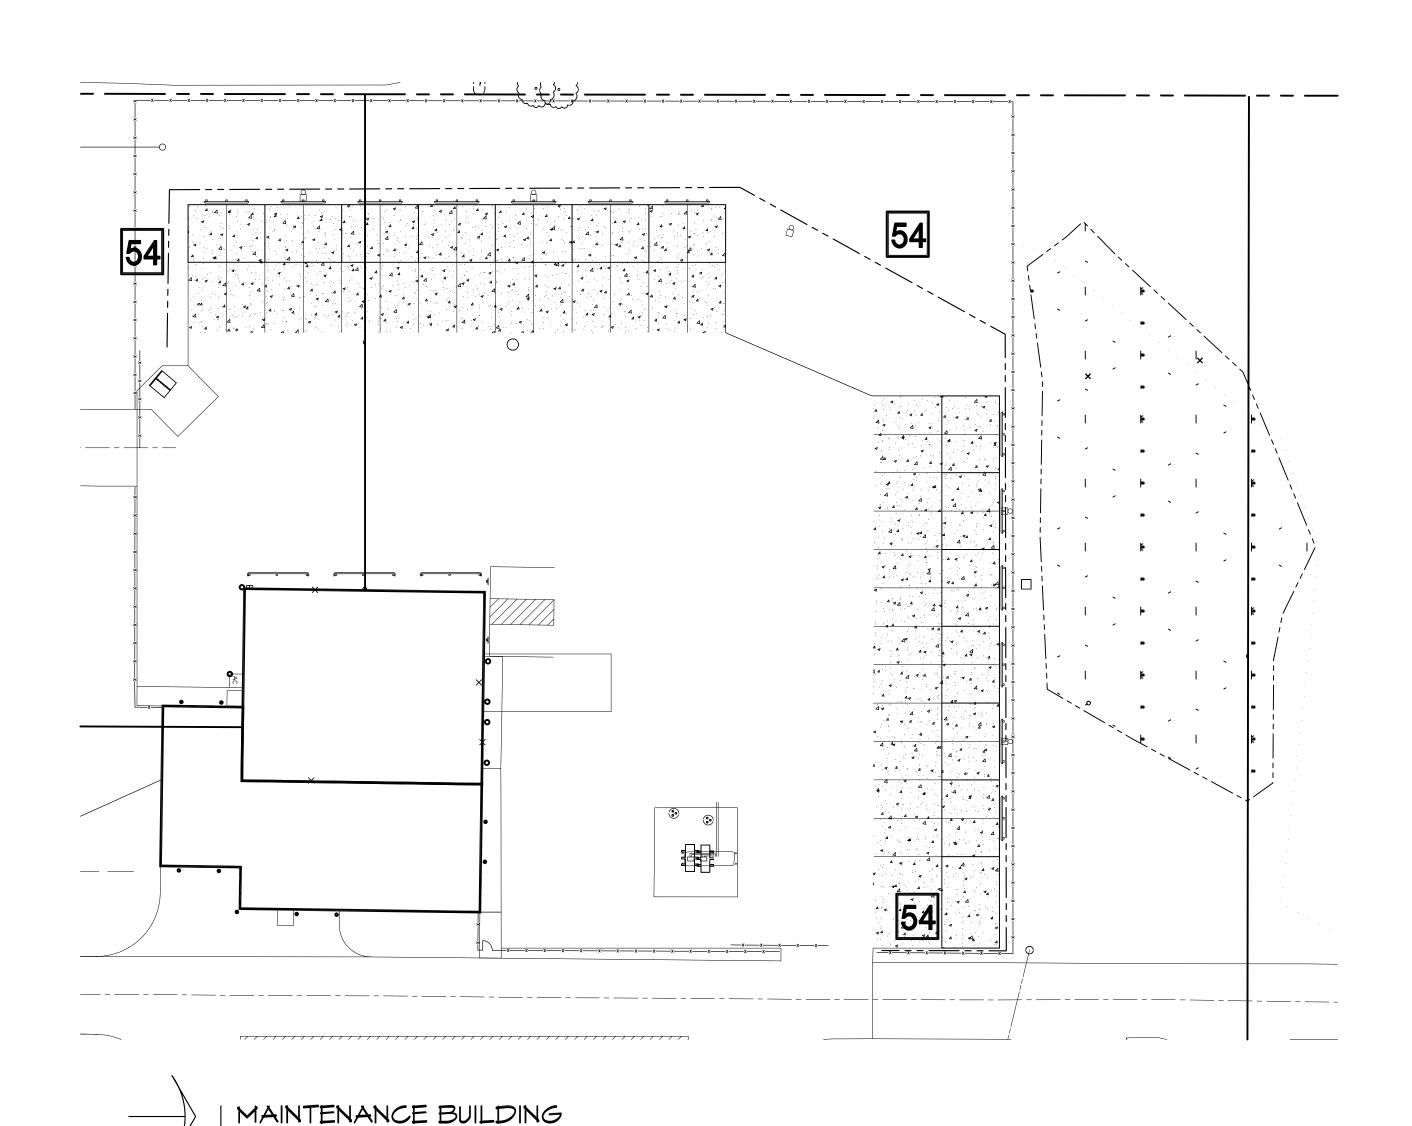
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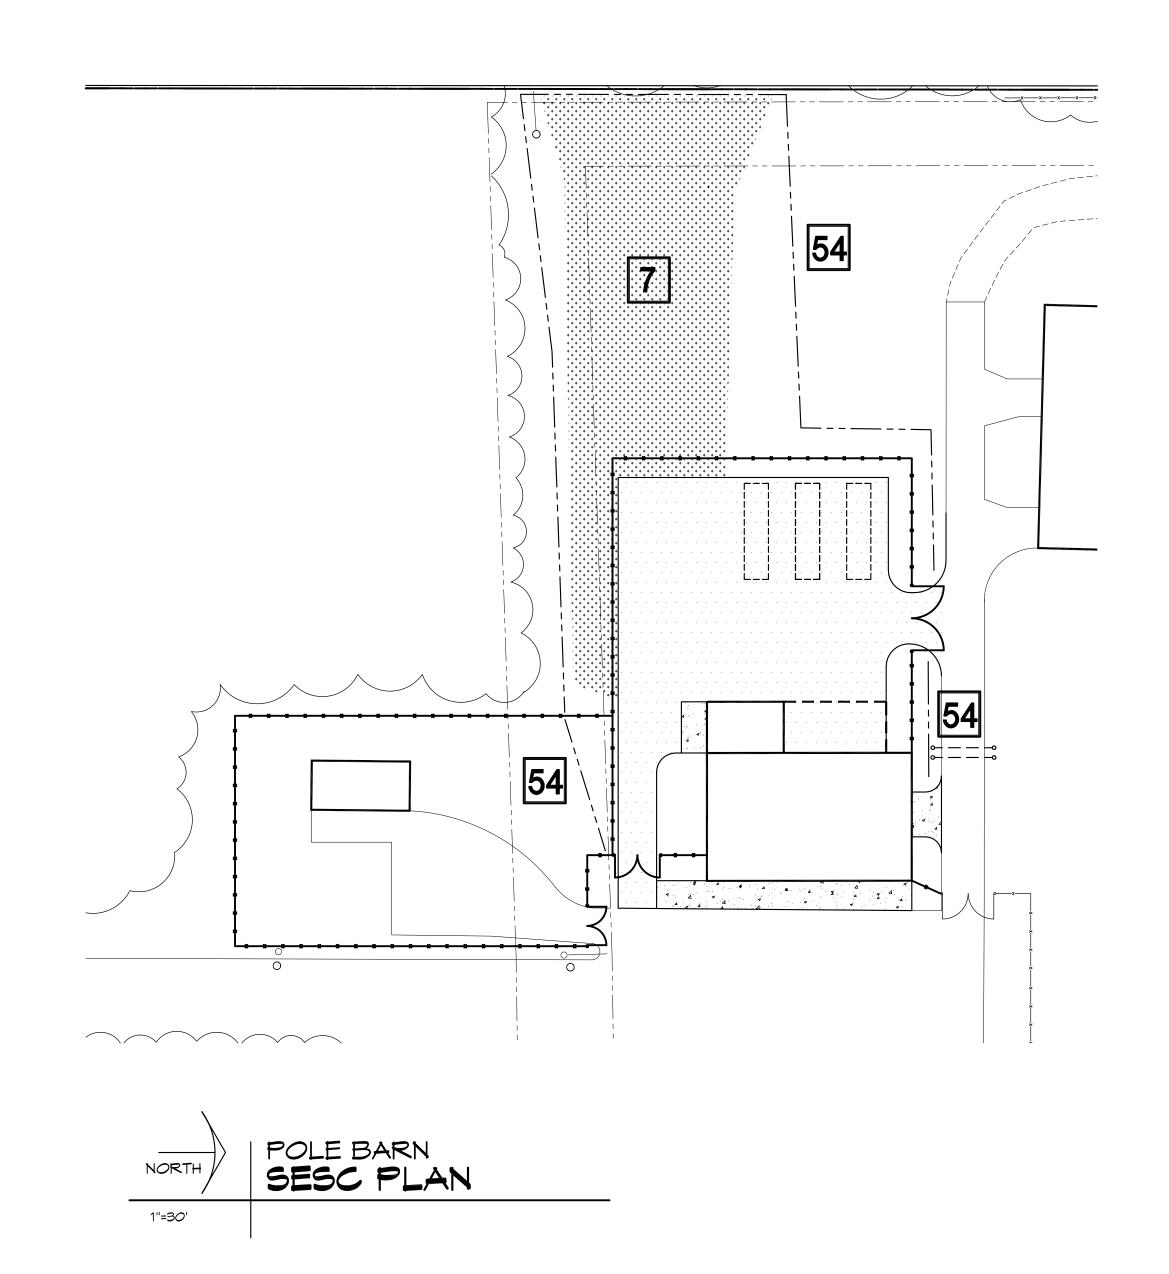
B S P S M S A







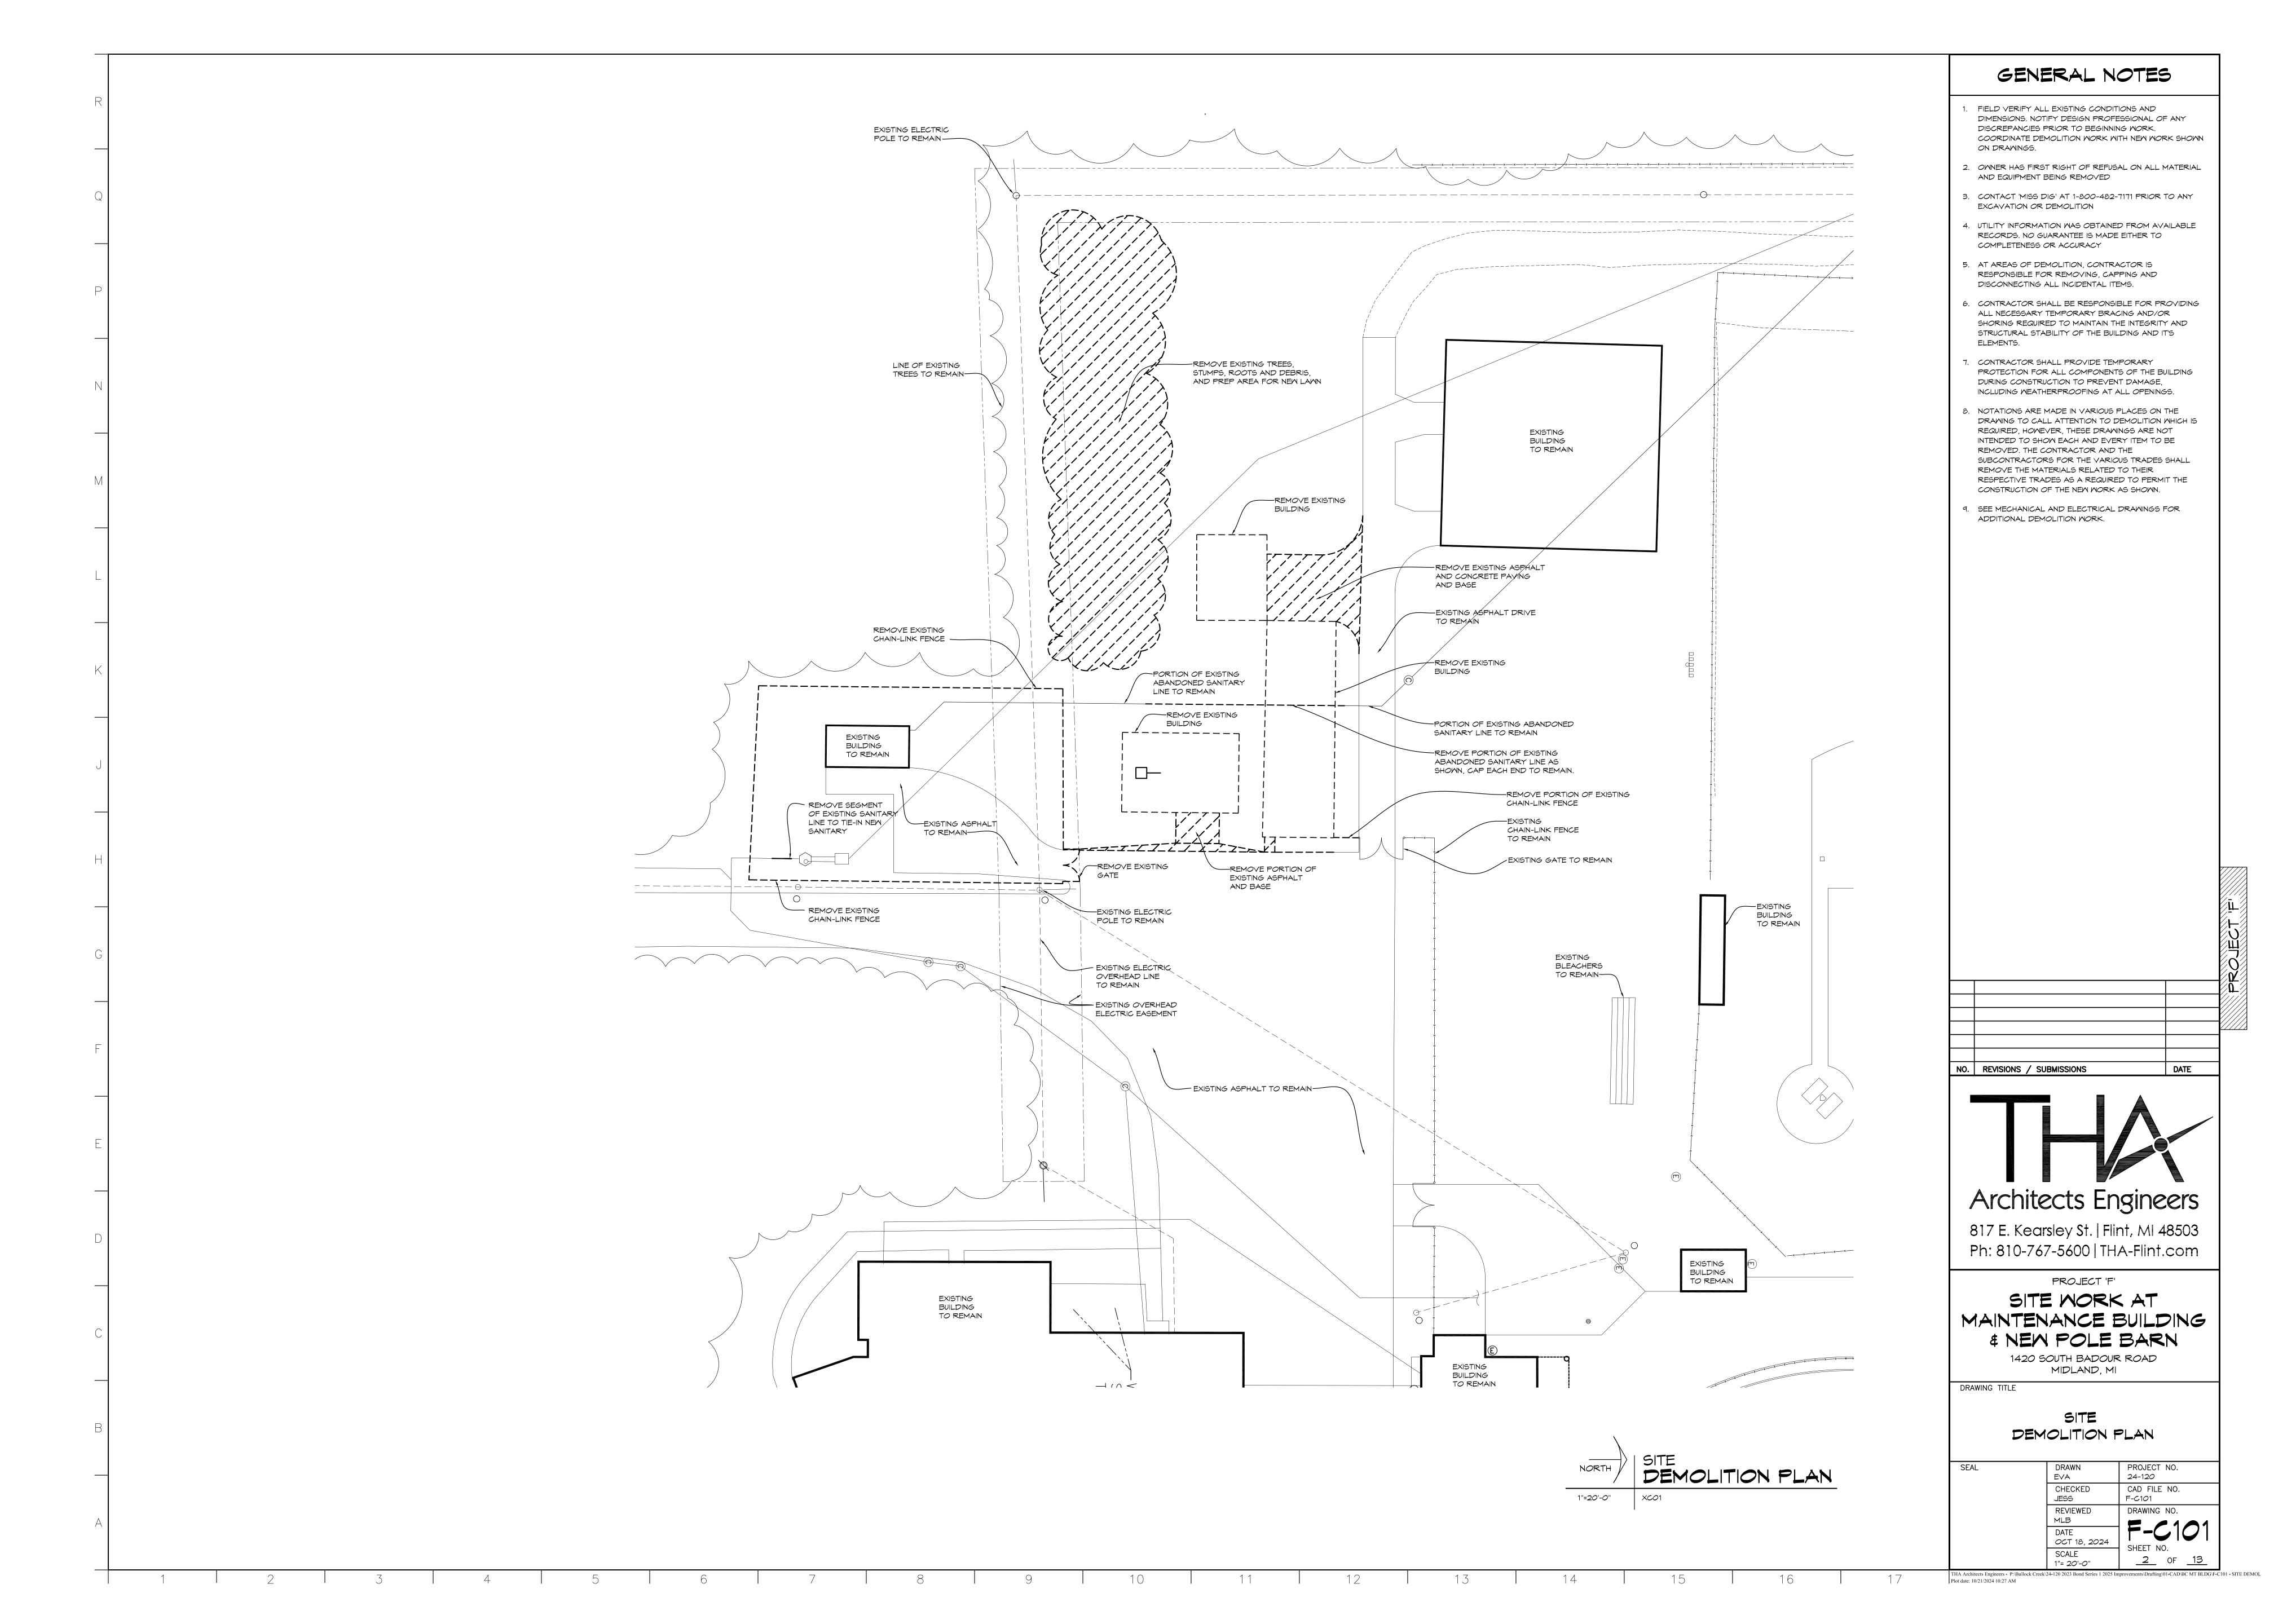

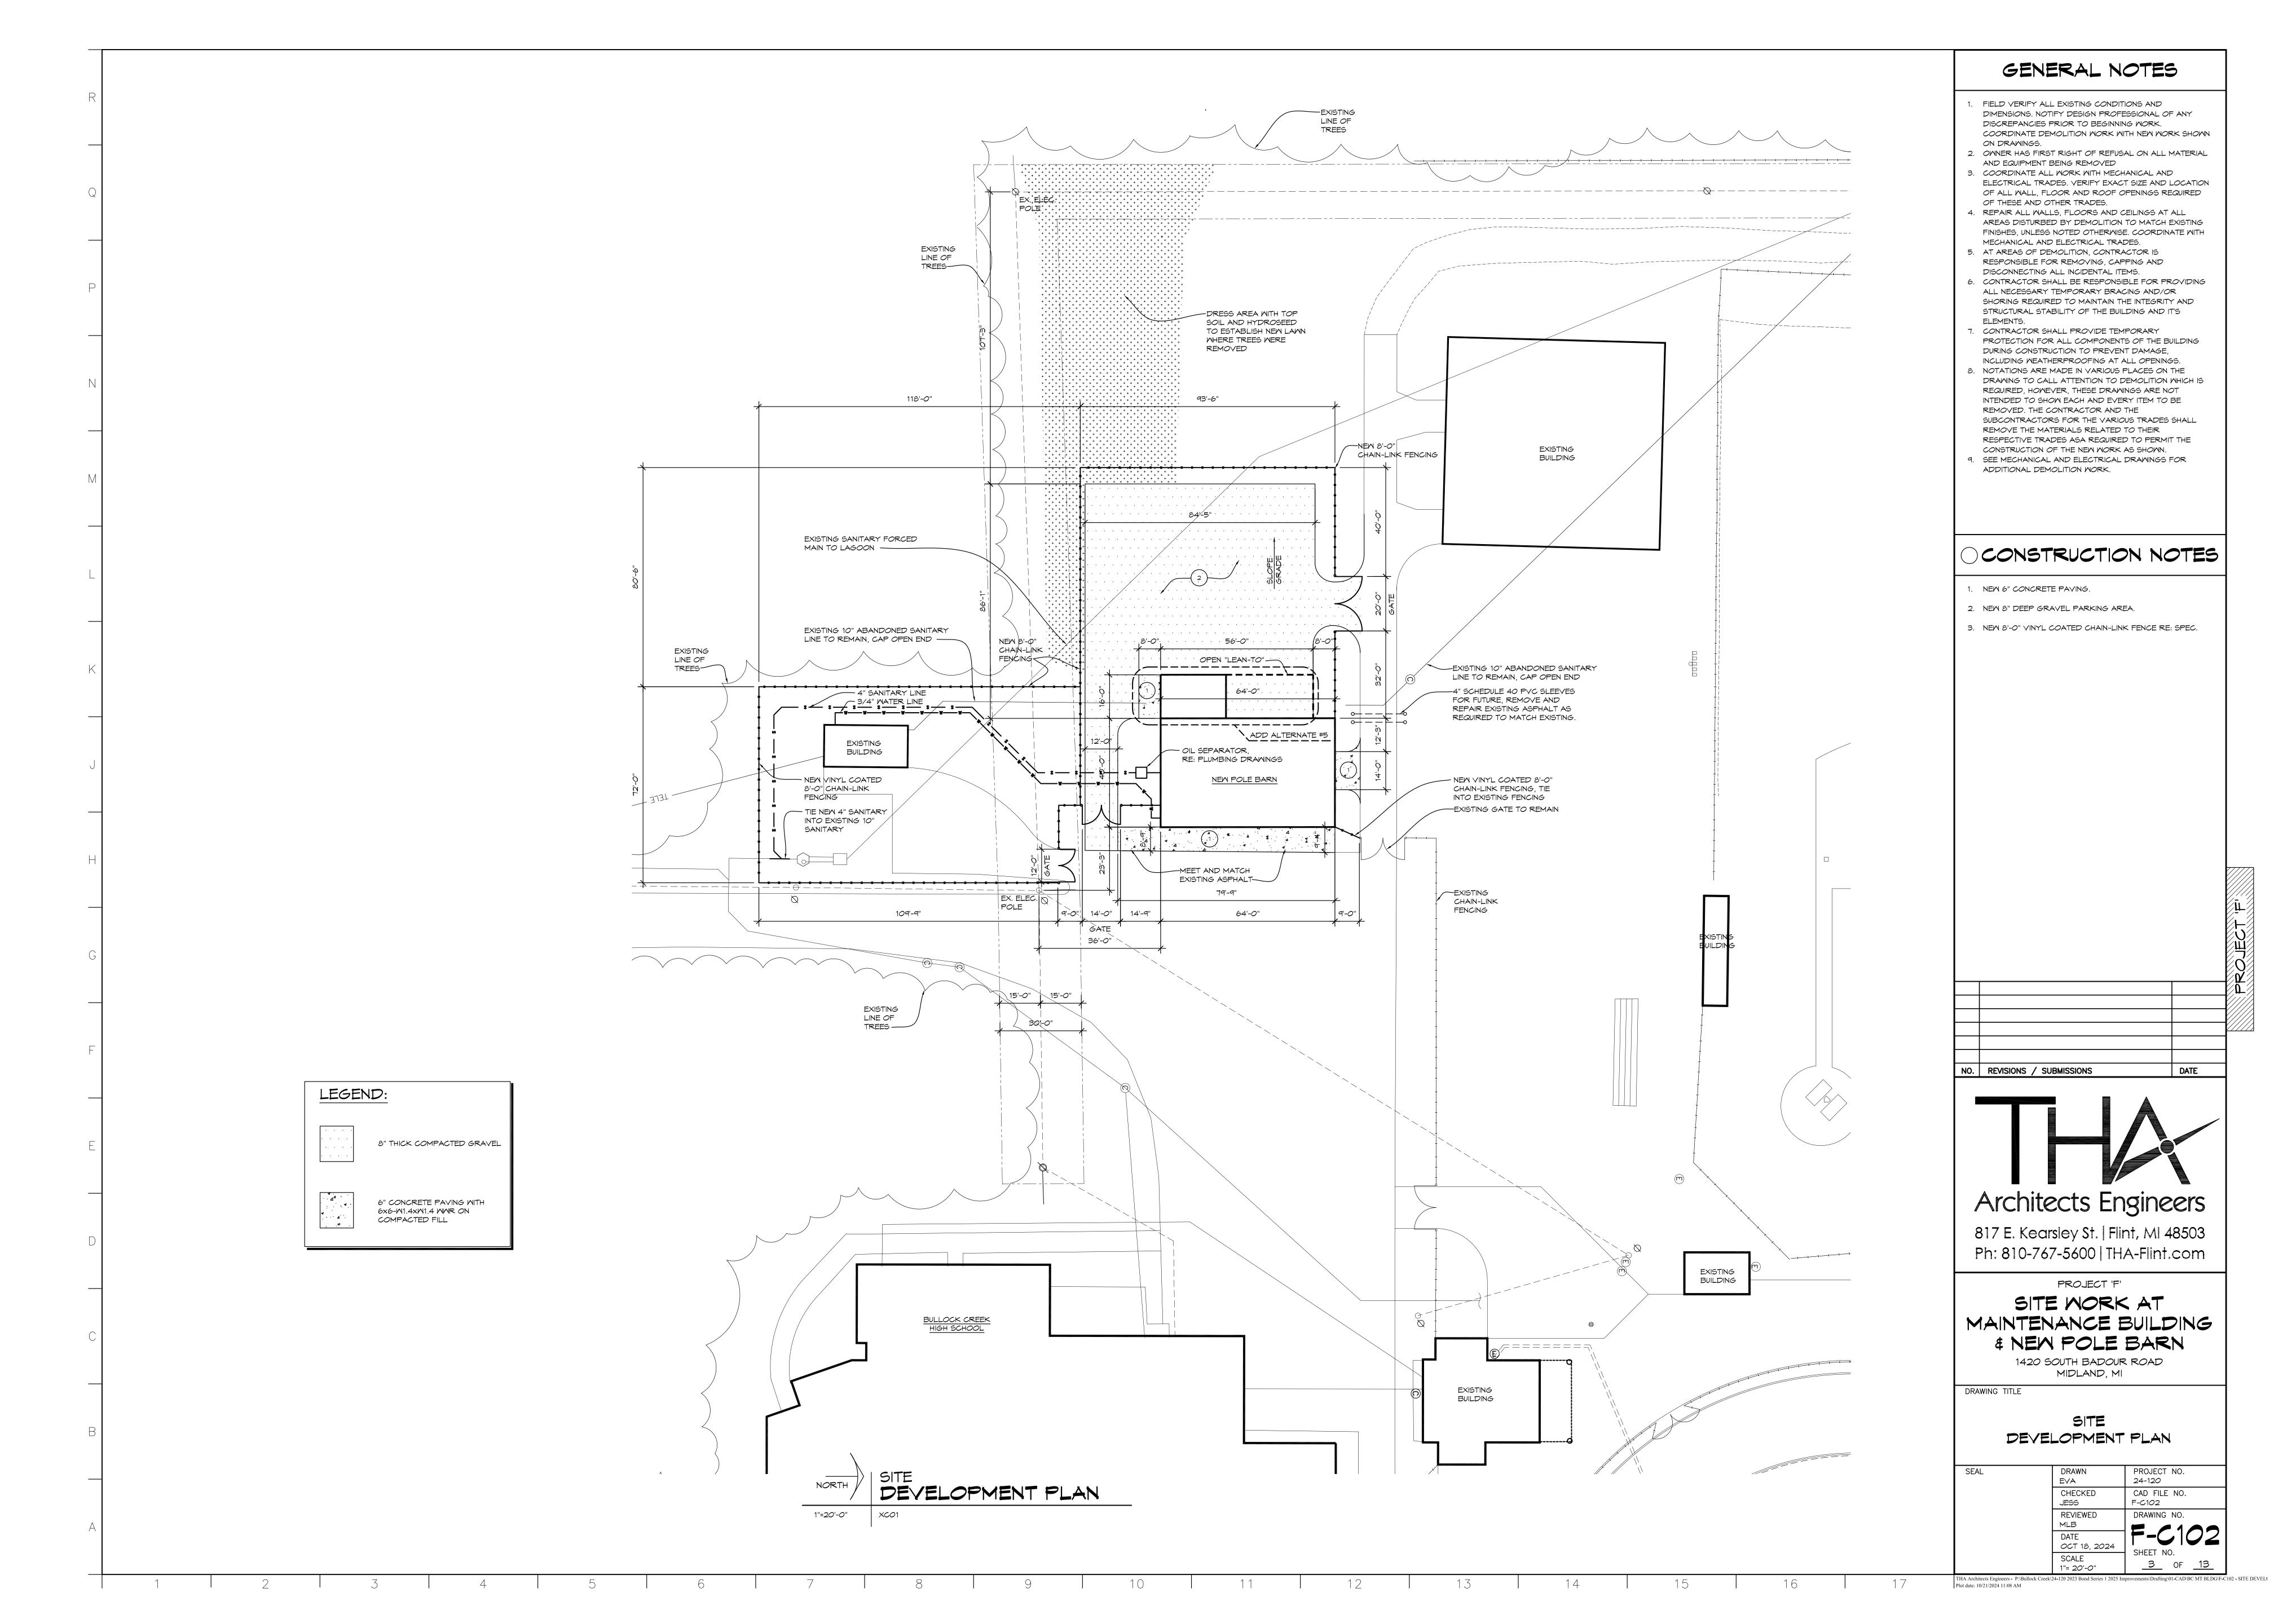

SOIL EROSION AND SEDIMENTATION CONTROL

NORTH

1"=3*0*'

SESC PLAN

 DEVELOPER / PROPERTY OWNER SHALL SUBMIT A DETAILED EROSION CONTROL PLAN AND OBTAIN A SOIL EROSION AND SEDIMENTATION CONTROL PERMIT PRIOR TO ANY EARTH CHANGES.

- CONSTRUCTION OPERATION SHALL BE SCHEDULED AND PERFORMED SO THAT PREVENTATIVE EROSION CONTROL MEASURES ARE IN PLACE PRIOR TO EXCAVATION AND TEMPORARY STABILIZATION MEASURES ARE IN PLACE IMMEDIATELY FOLLOWING BACKFILLING AND / OR GRADING OPERATIONS.
- 3. BORROW AND FILL DISPOSAL AREAS WILL BE SELECTED AND APPROVED AT TIME OF PLAN REVIEW.
- SPECIAL PRECAUTIONS WILL BE TAKEN IN THE USE OF CONSTRUCTION EQUIPMENT TO PREVENT SITUATIONS THAT PROMOTE EROSION.
- CLEANUP WILL BE DONE IN A MANNER TO INSURE THAT EROSION CONTROL MEASURES ARE NOT DISTURBED.
- 6. THE PROJECT WILL CONTINUALLY BE INSPECTED FOR SOIL EROSION AND SEDIMENT CONTROL COMPLIANCE. DEFICIENCIES WILL BE CORRECTED BY THE DEVELOPER WITHIN 24 HOURS.
- TEMPORARY EROSION CONTROL MEASURES SHALL BE COMPLETELY REMOVED BY THE DEVELOPER UPON EASTABLISHMENT OF PERMANENT CONTROL MEASURES.
- 8. ALL TEMPORARY SOIL EROSION CONTROL MEASURES MUST BE REMOVED FROM ROAD RIGHT-OF-WAY AREAS PRIOR TO ACCEPTANCE OF STREETS FOR ROUTINE MAINTENANCE.
- 9. VEGETATION MUST BE ACCEPTABLY ESTABLISHED PRIOR TO FINAL RELEASE OF THE CONSTRUCTION GUARANTEE BY THE ROAD COMMISSION.

MICHIGAN UNIFIED KEYING SYSTEM

KEY DETAIL	CHARACTERISTICS
7 HYDRO-SEEDING	EFFECTIVE ON LARGE AREAS MILCH TACKING AGENT USED TO PROVIDE IMMEDIATE PROTECTION UNTIL GRASS IS ROOTED SHOULD INCLUDE PREPARED TOPSOIL BED
54 SILT FENCE	USES GEOTEXTILE FABRIC AND POSTS OR POLES. EASY TO CONSTRUCT AND LOCATE AS NECESSARY.

CONSTRUCTION SEQUENCE

- EXCAVATION AND STOCKPILING OF SOIL.
- 2. IMPLEMENTATION OF TEMPORARY EROSION CONTROL MEASURES; SELECTIVE GRADING, DIVERSIONS AS REQUIRED IN FIELD, PROTECTION OF STORM SEWER FACILITIES.
- 3. PERIODIC MAINTENANCE OF AFFECTED EROSION CONTROL MEASURES.
- 4. PERMANENT MEASURES; FINAL GRADING, SEEDING AND MULCHING.

RATE OF APPLICATION (ALL ZONES)

PER/1000 SF	PER ACRE				
2 LB 1/2 LB	3 BU 20-25 LBS				
1 LB	30-40 LBS				
3 LBS 1/2 LB	2-3 BU 20-25 LBS				
3 LBS	2-3 BU				

SOIL EROSION / SEDIMENTATION CONTROL OPERATION TIME SCHEDULE


CONSTRUCTION SCHEDULE 2024 / 2025	SEPT	OCT	NOV	DEC	NAL	FEB	MAR	APR	MAY	JUNE	JULY	AUG	SEPT	007
TEMPORARY SESC MEASURES														
STRIP AND STOCKPILE SOIL														
ROUGH GRADING														
UNDERGROUND UTILITIES														
ROAD INSTALLATION														
BUILDING CONSTRUCTION (REMODEL)														
PERMANENT SESC MEASURES														
FINAL GRADE														
LANDSCAPING														


MAINTENANCE SCHEDULE 2024 / 2025	SEPT	OCT	NOV	DEC	NAL	FEB	MAR	APR	MAY	JUNE	JULY	AUG	SEPT	OCT
STREET SMEEPING														
SILT FENCING														
MAINTAIN BUFFER STRIPS														
INLET STRUCTURES														
SEEDING AND MULCH														
SEDIMENT BASINS														
RIP-RAP														
REMOVE TEMPORARY MEASURES														

COMPACTED GRAVEL

CONCRETE PAVING

SEEDED TOPSOIL

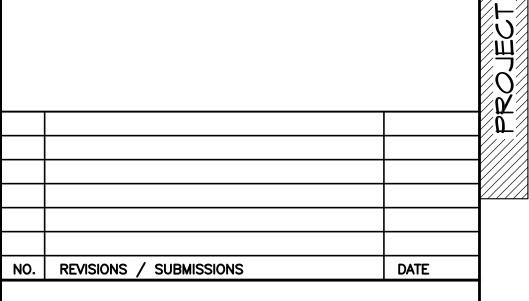

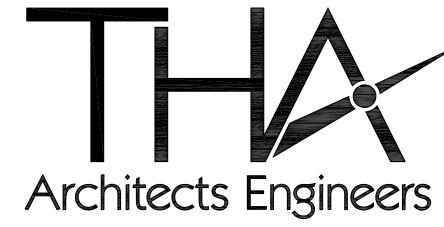

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PROJECT 'F'

SITE WORK AT
MAINTENANCE BUILDING
& NEW POLE BARN

1420 SOUTH BADOUR ROAD MIDLAND, MI

DRAWING TITLE

SESC PLANS


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	CHECKED JESS	CAD FILE NO. F-C104
	REVIEWED MLB	DRAWING NO.
	DATE	


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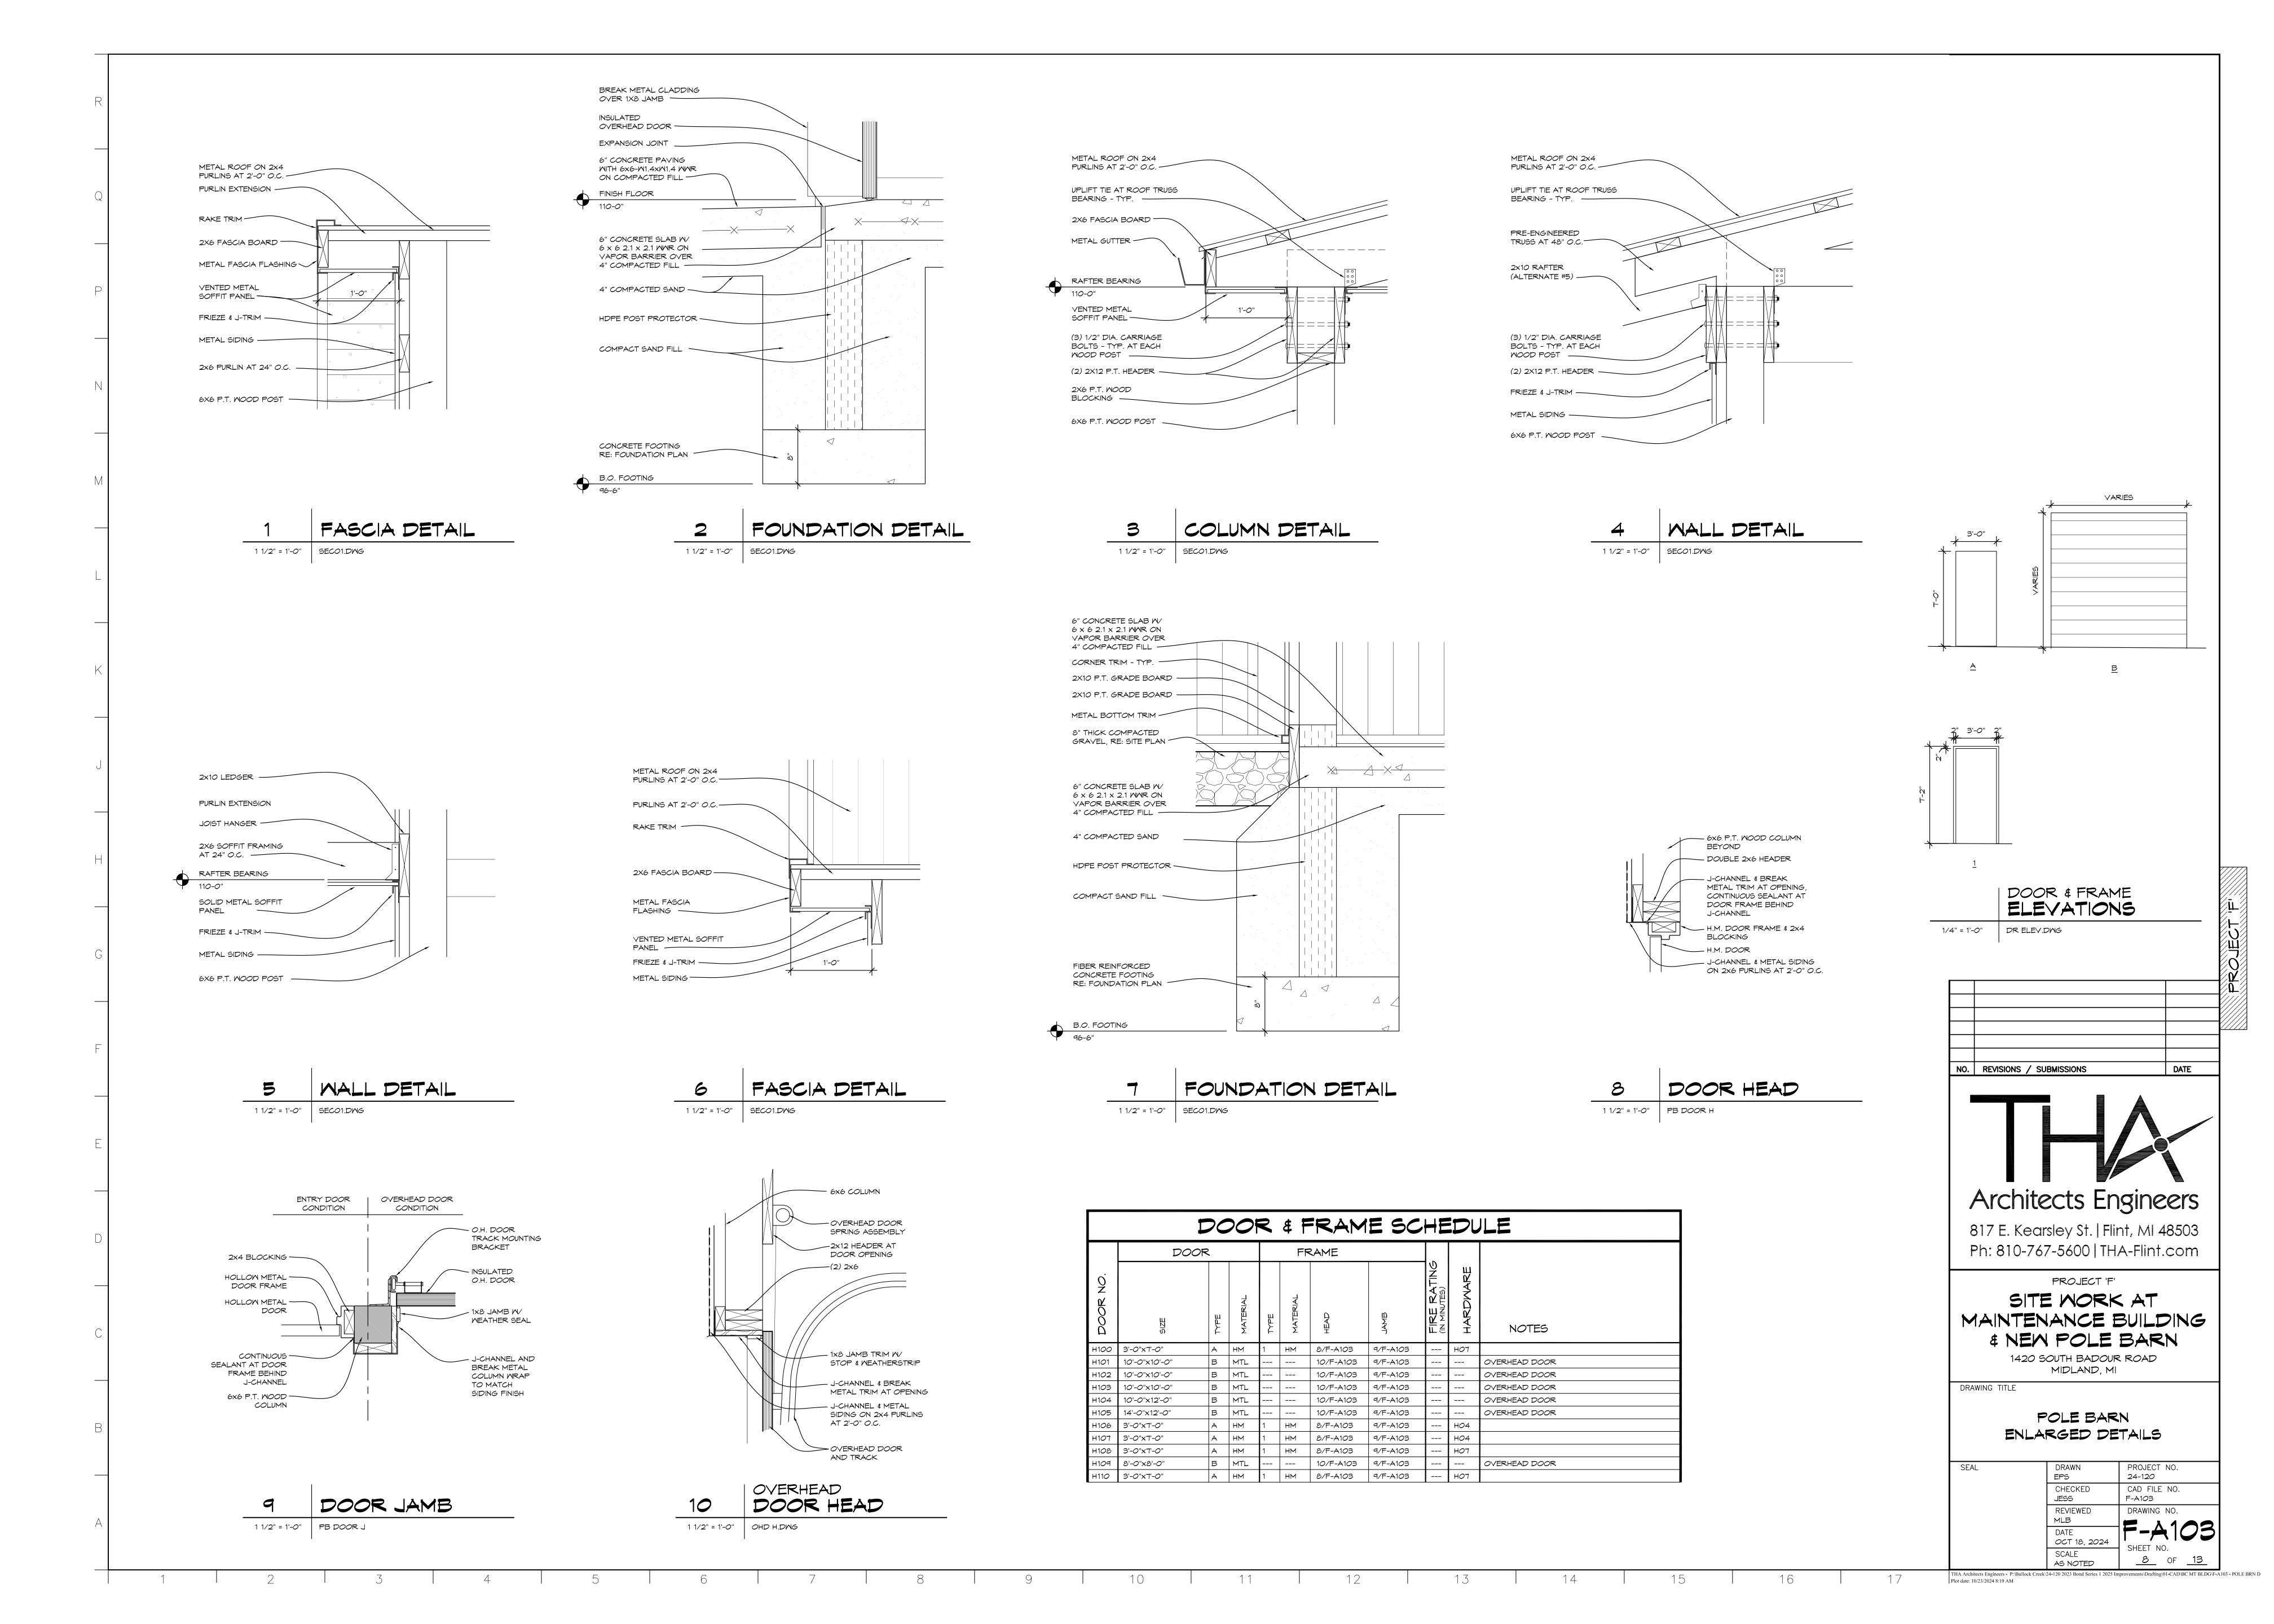
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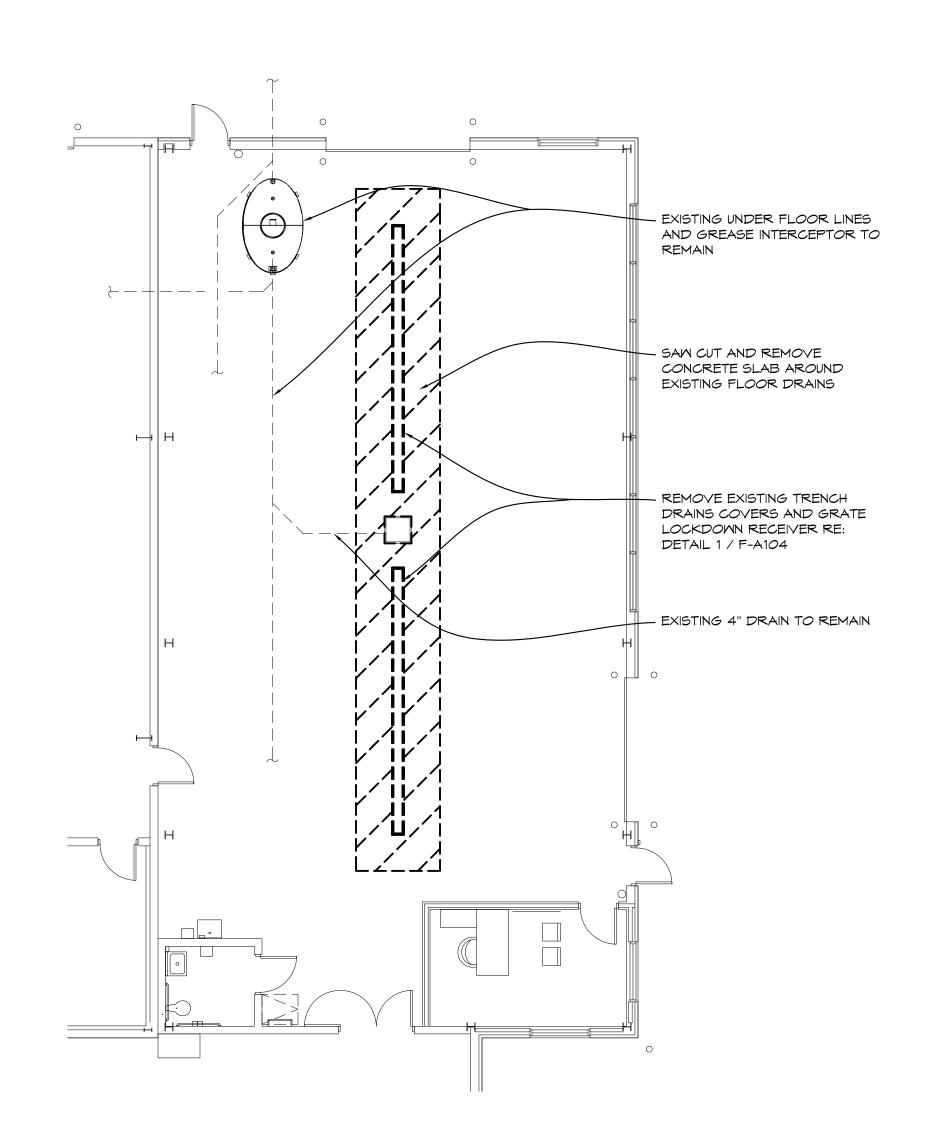
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5 OF 13









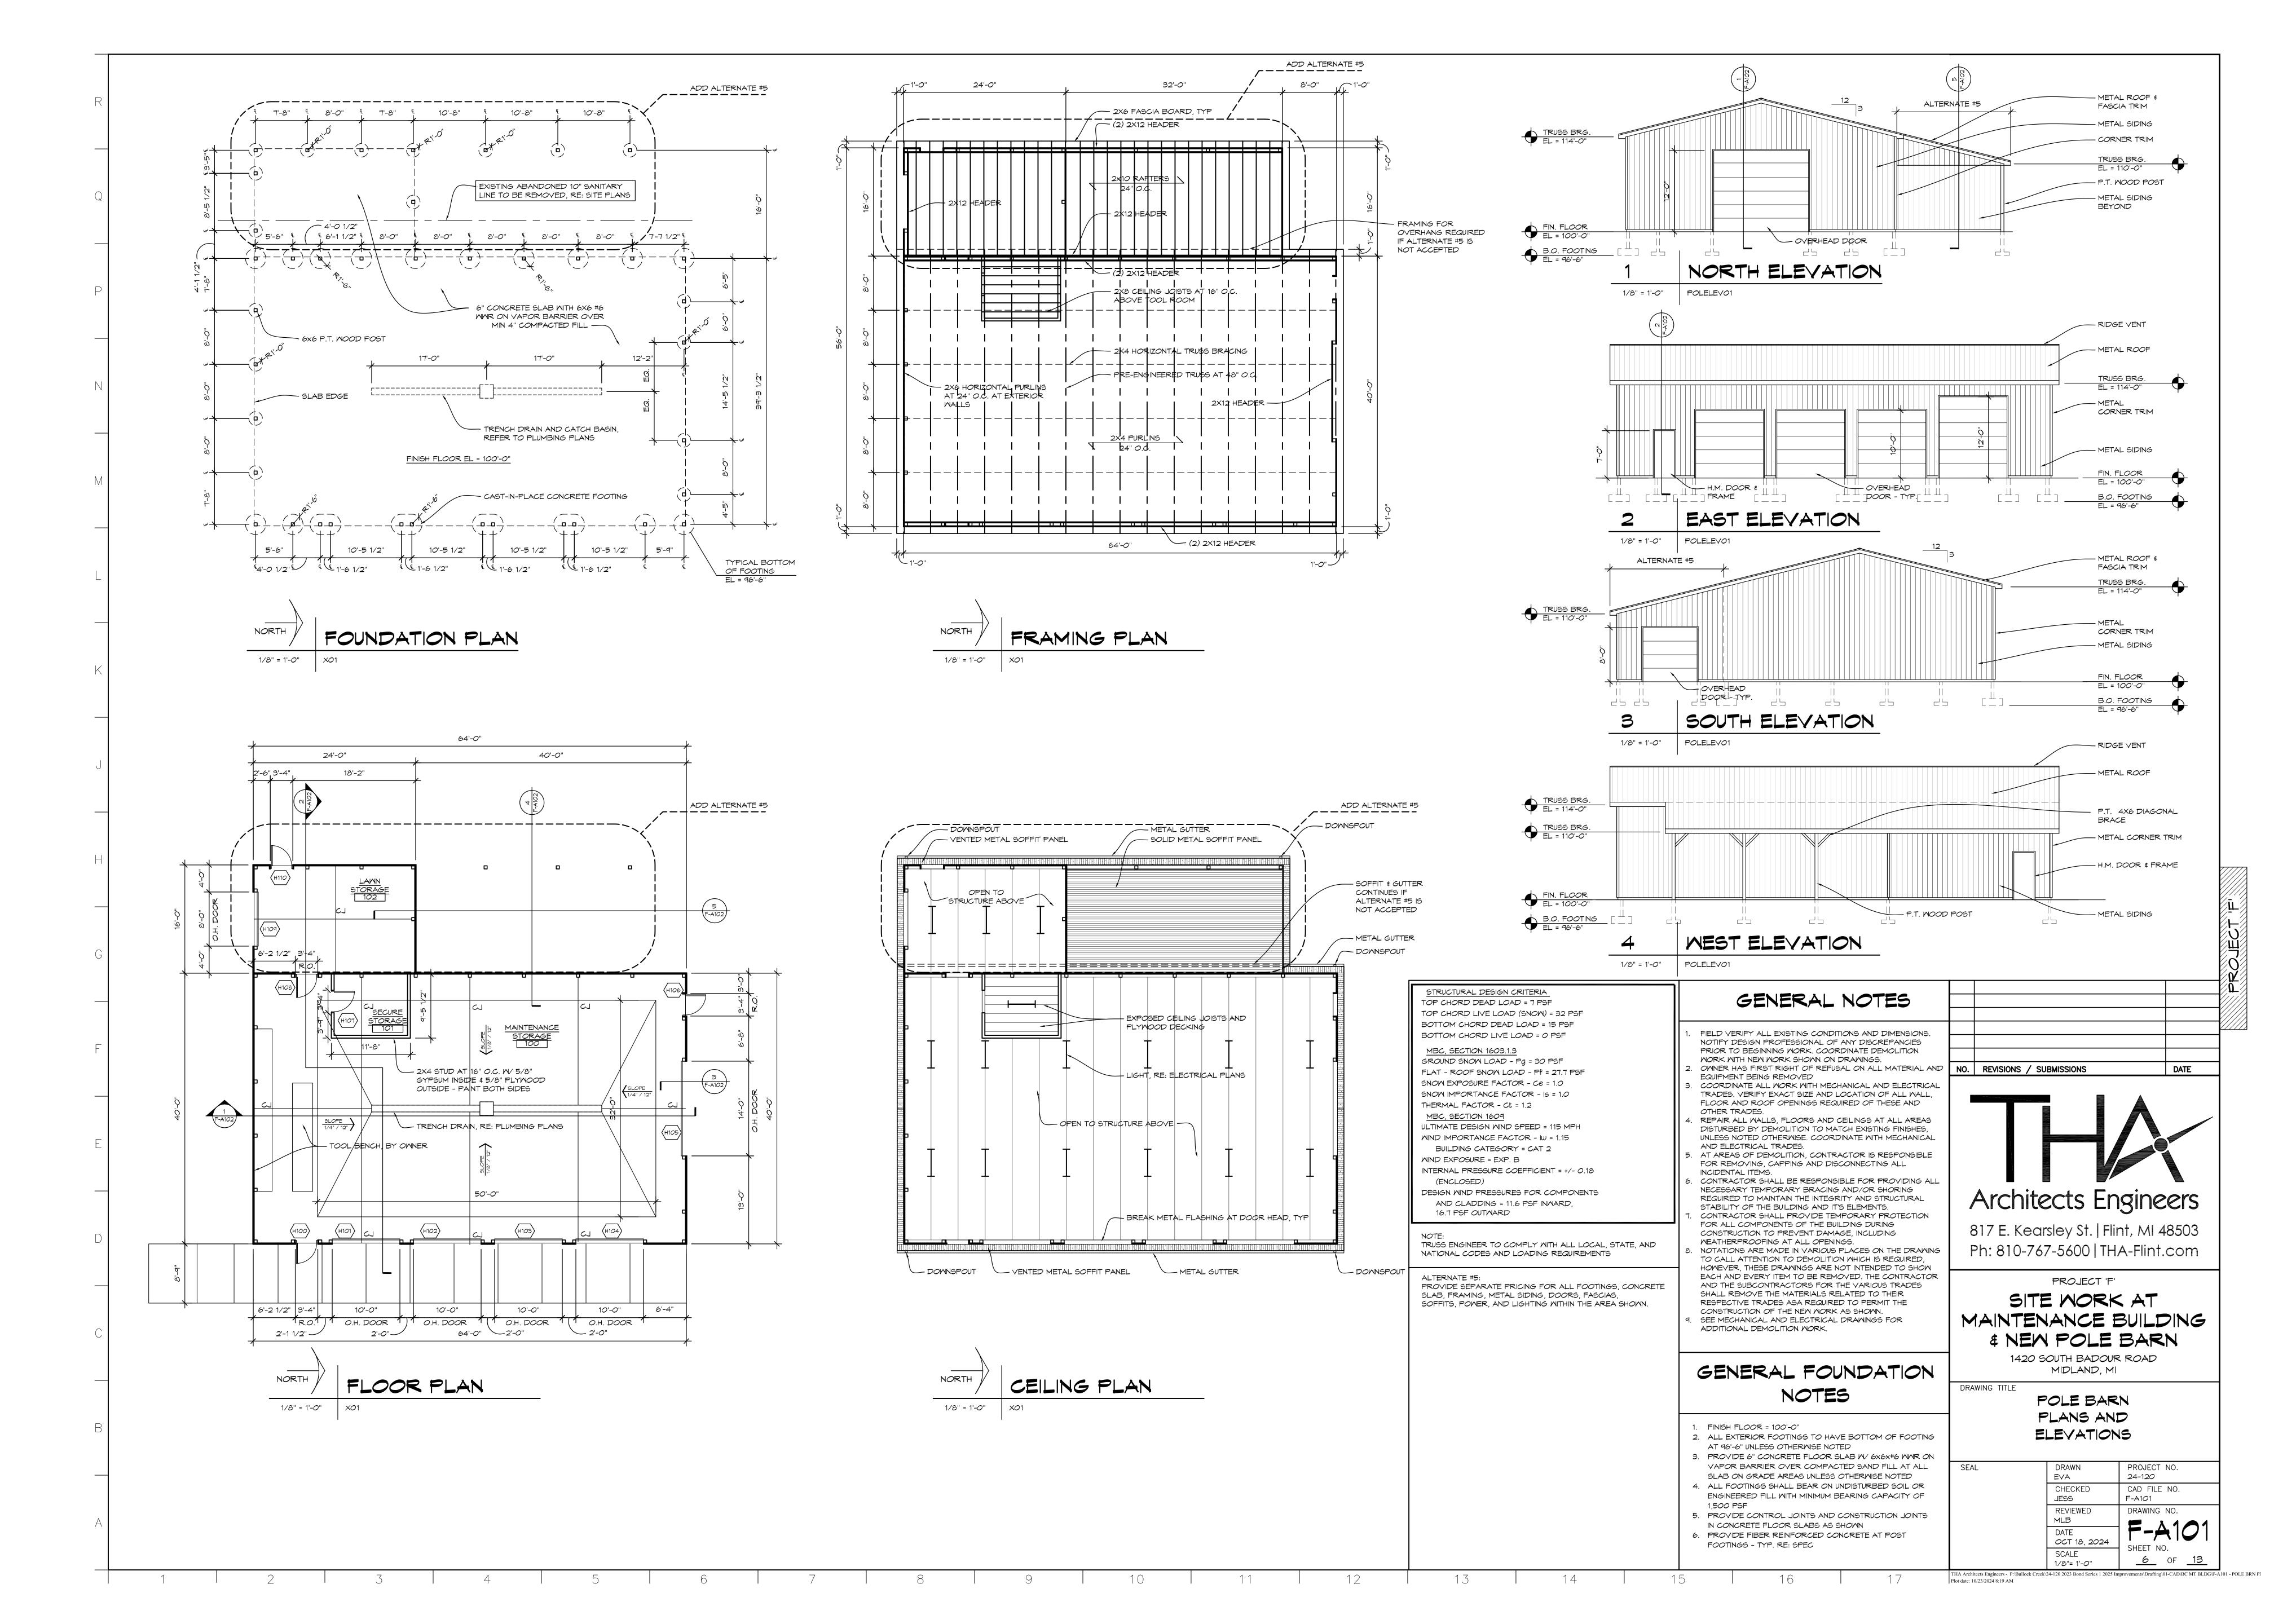


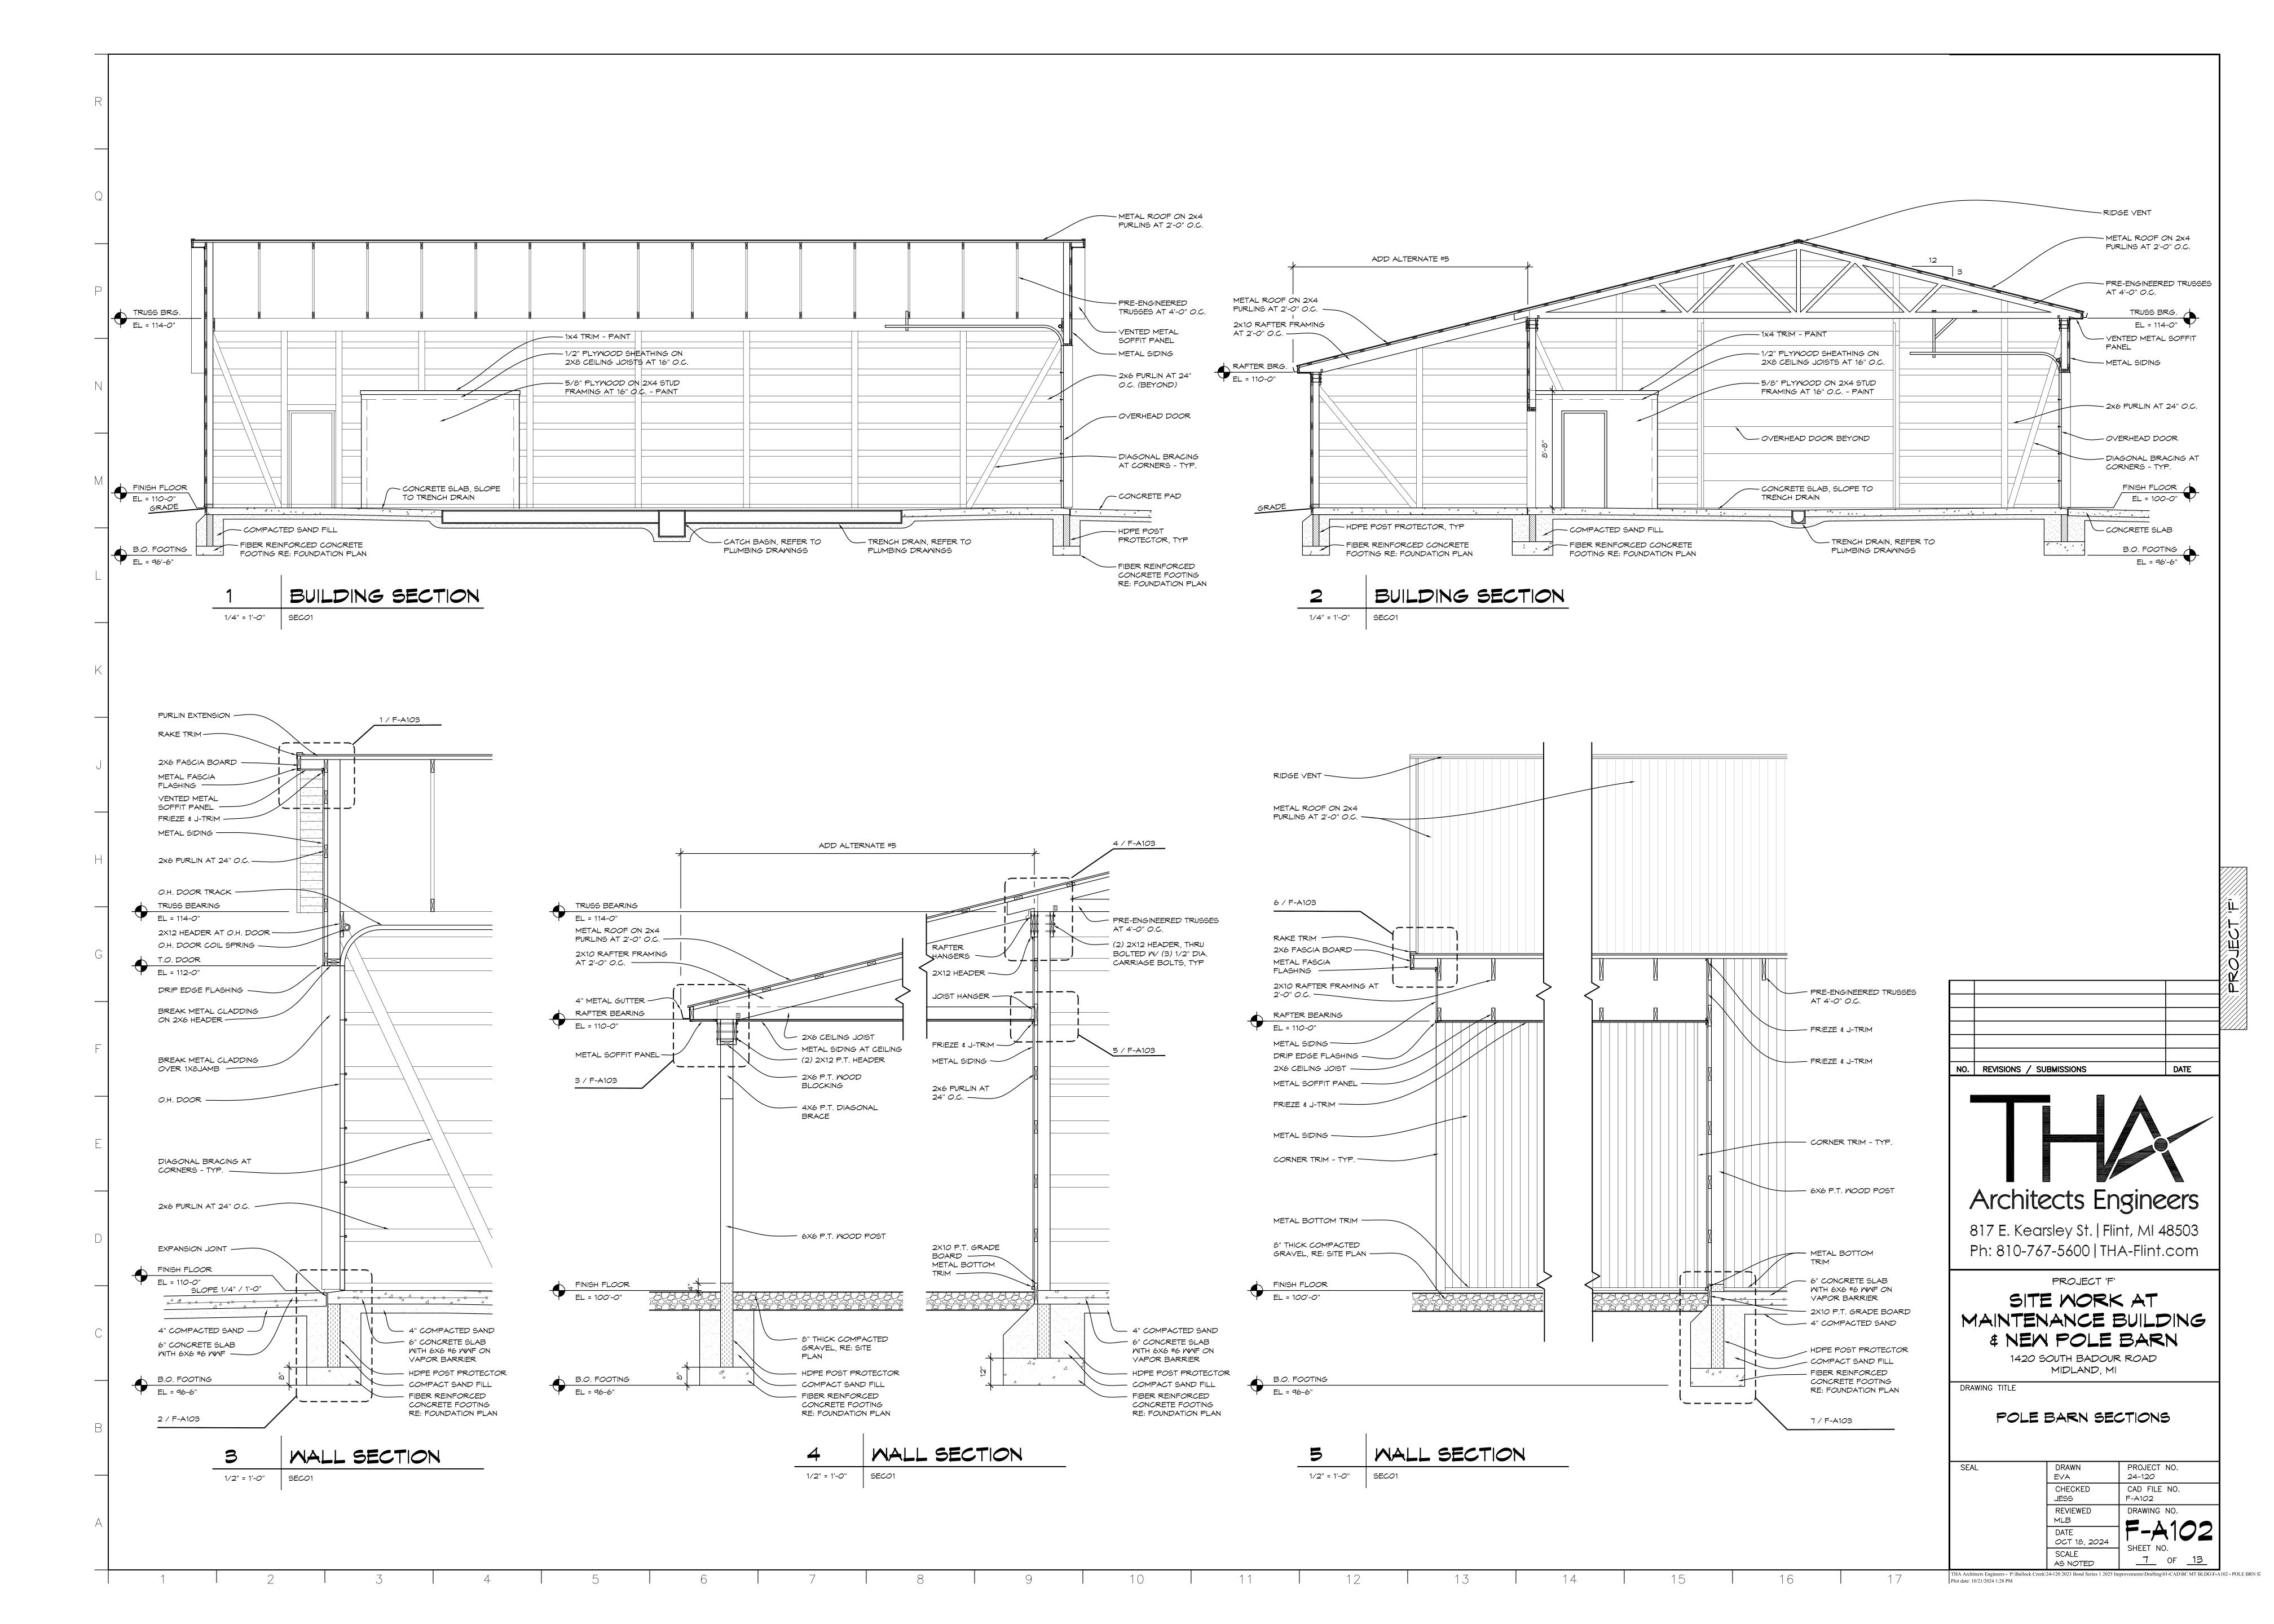PARTIAL
DEMOLITION PLAN

1/8" = 1'-0" XO1

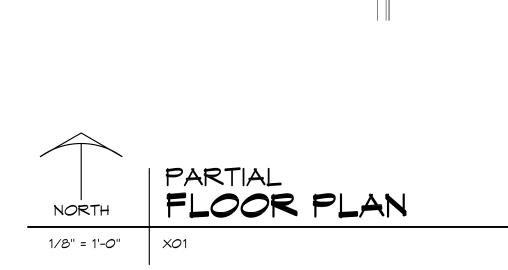

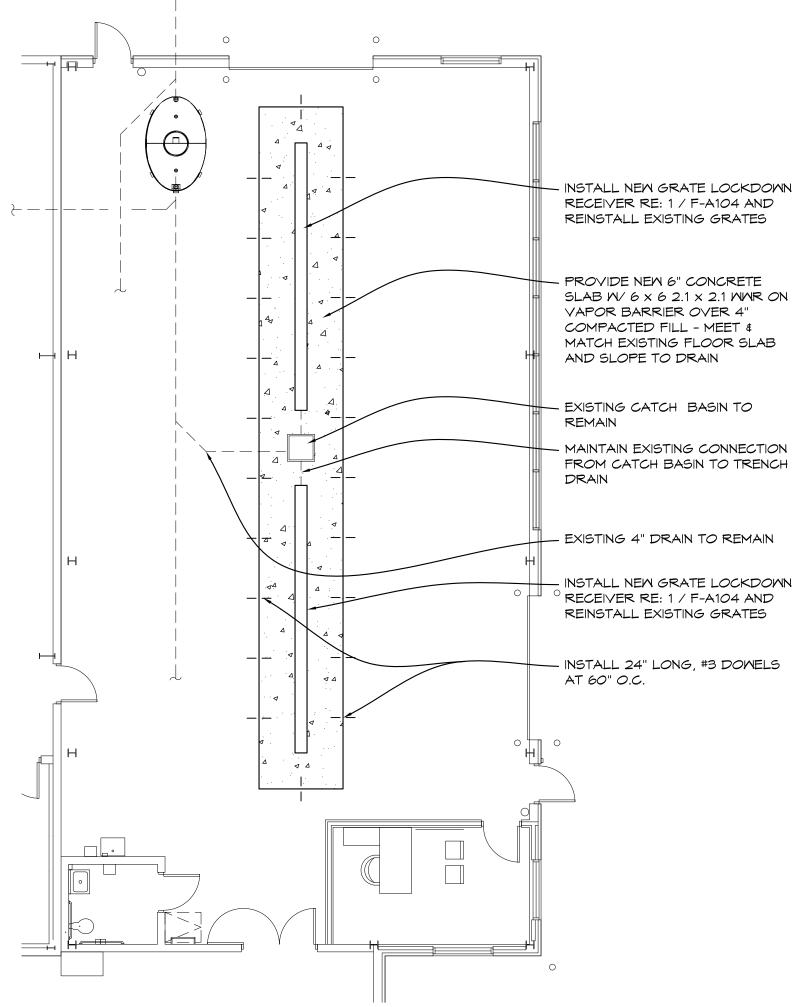

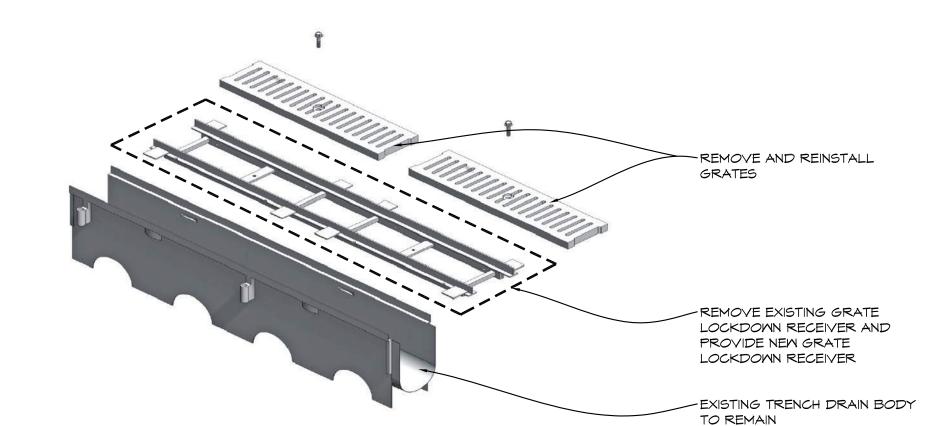

1 TRENCH DRAIN DETAIL

N.T.S.

GENERAL NOTES

- FIELD VERIFY ALL EXISTING CONDITIONS AND
 DIMENSIONS. NOTIFY DESIGN PROFESSIONAL OF ANY
 DISCREPANCIES PRIOR TO BEGINNING WORK.
 COORDINATE DEMOLITION WORK WITH NEW WORK SHOWN
- ON DRAWINGS.

 2. OWNER HAS FIRST RIGHT OF REFUSAL ON ALL MATERIAL AND EQUIPMENT BEING REMOVED

 3. COORDINATE ALL WORK WITH MECHANICAL AND
- ELECTRICAL TRADES. VERIFY EXACT SIZE AND LOCATION
 OF ALL WALL, FLOOR AND ROOF OPENINGS REQUIRED
 OF THESE AND OTHER TRADES.
 4. REPAIR ALL WALLS, FLOORS AND CEILINGS AT ALL
- AREAS DISTURBED BY DEMOLITION TO MATCH EXISTING FINISHES, UNLESS NOTED OTHERWISE. COORDINATE WITH MECHANICAL AND ELECTRICAL TRADES.

 AT AREAS OF DEMOLITION, CONTRACTOR IS
- 5. AT AREAS OF DEMOLITION, CONTRACTOR IS
 RESPONSIBLE FOR REMOVING, CAPPING AND
 DISCONNECTING ALL INCIDENTAL ITEMS.
- 6. CONTRACTOR SHALL BE RESPONSIBLE FOR PROVIDING ALL NECESSARY TEMPORARY BRACING AND/OR SHORING REQUIRED TO MAINTAIN THE INTEGRITY AND STRUCTURAL STABILITY OF THE BUILDING AND IT'S ELEMENTS.
- CONTRACTOR SHALL PROVIDE TEMPORARY
 PROTECTION FOR ALL COMPONENTS OF THE BUILDING
 DURING CONSTRUCTION TO PREVENT DAMAGE,
 INCLUDING WEATHERPROOFING AT ALL OPENINGS.
- 8. NOTATIONS ARE MADE IN VARIOUS PLACES ON THE DRAWING TO CALL ATTENTION TO DEMOLITION WHICH IS REQUIRED, HOWEVER, THESE DRAWINGS ARE NOT INTENDED TO SHOW EACH AND EVERY ITEM TO BE REMOVED. THE CONTRACTOR AND THE SUBCONTRACTORS FOR THE VARIOUS TRADES SHALL REMOVE THE MATERIALS RELATED TO THEIR RESPECTIVE TRADES ASA REQUIRED TO PERMIT THE
- CONSTRUCTION OF THE NEW WORK AS SHOWN.

 9. SEE MECHANICAL AND ELECTRICAL DRAWINGS FOR ADDITIONAL DEMOLITION WORK.

NO. REVISIONS / SUBMISSIONS

DATE

Architects Engineers

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PROJECT 'F'

SITE WORK AT MAINTENANCE BUILDING & NEW POLE BARN

1420 SOUTH BADOUR ROAD MIDLAND, MI

MAINTENANCE BUILDING
PARTIAL DEMOLITION PLAN,
PARTIAL FLOOR PLAN,
AND DETAIL

SEAL

DRAWN
EVA

CHECKED
JESS

REVIEWED
MLB

DATE
OCT 18, 2024

SCALE

PROJECT NO.
24-120

CAD FILE NO.
F-A104


DRAWING NO.

F-A104

SHEET NO.

AS NOTED

3 4 5 6 7 8 9 10 11 12 13 14 15 16

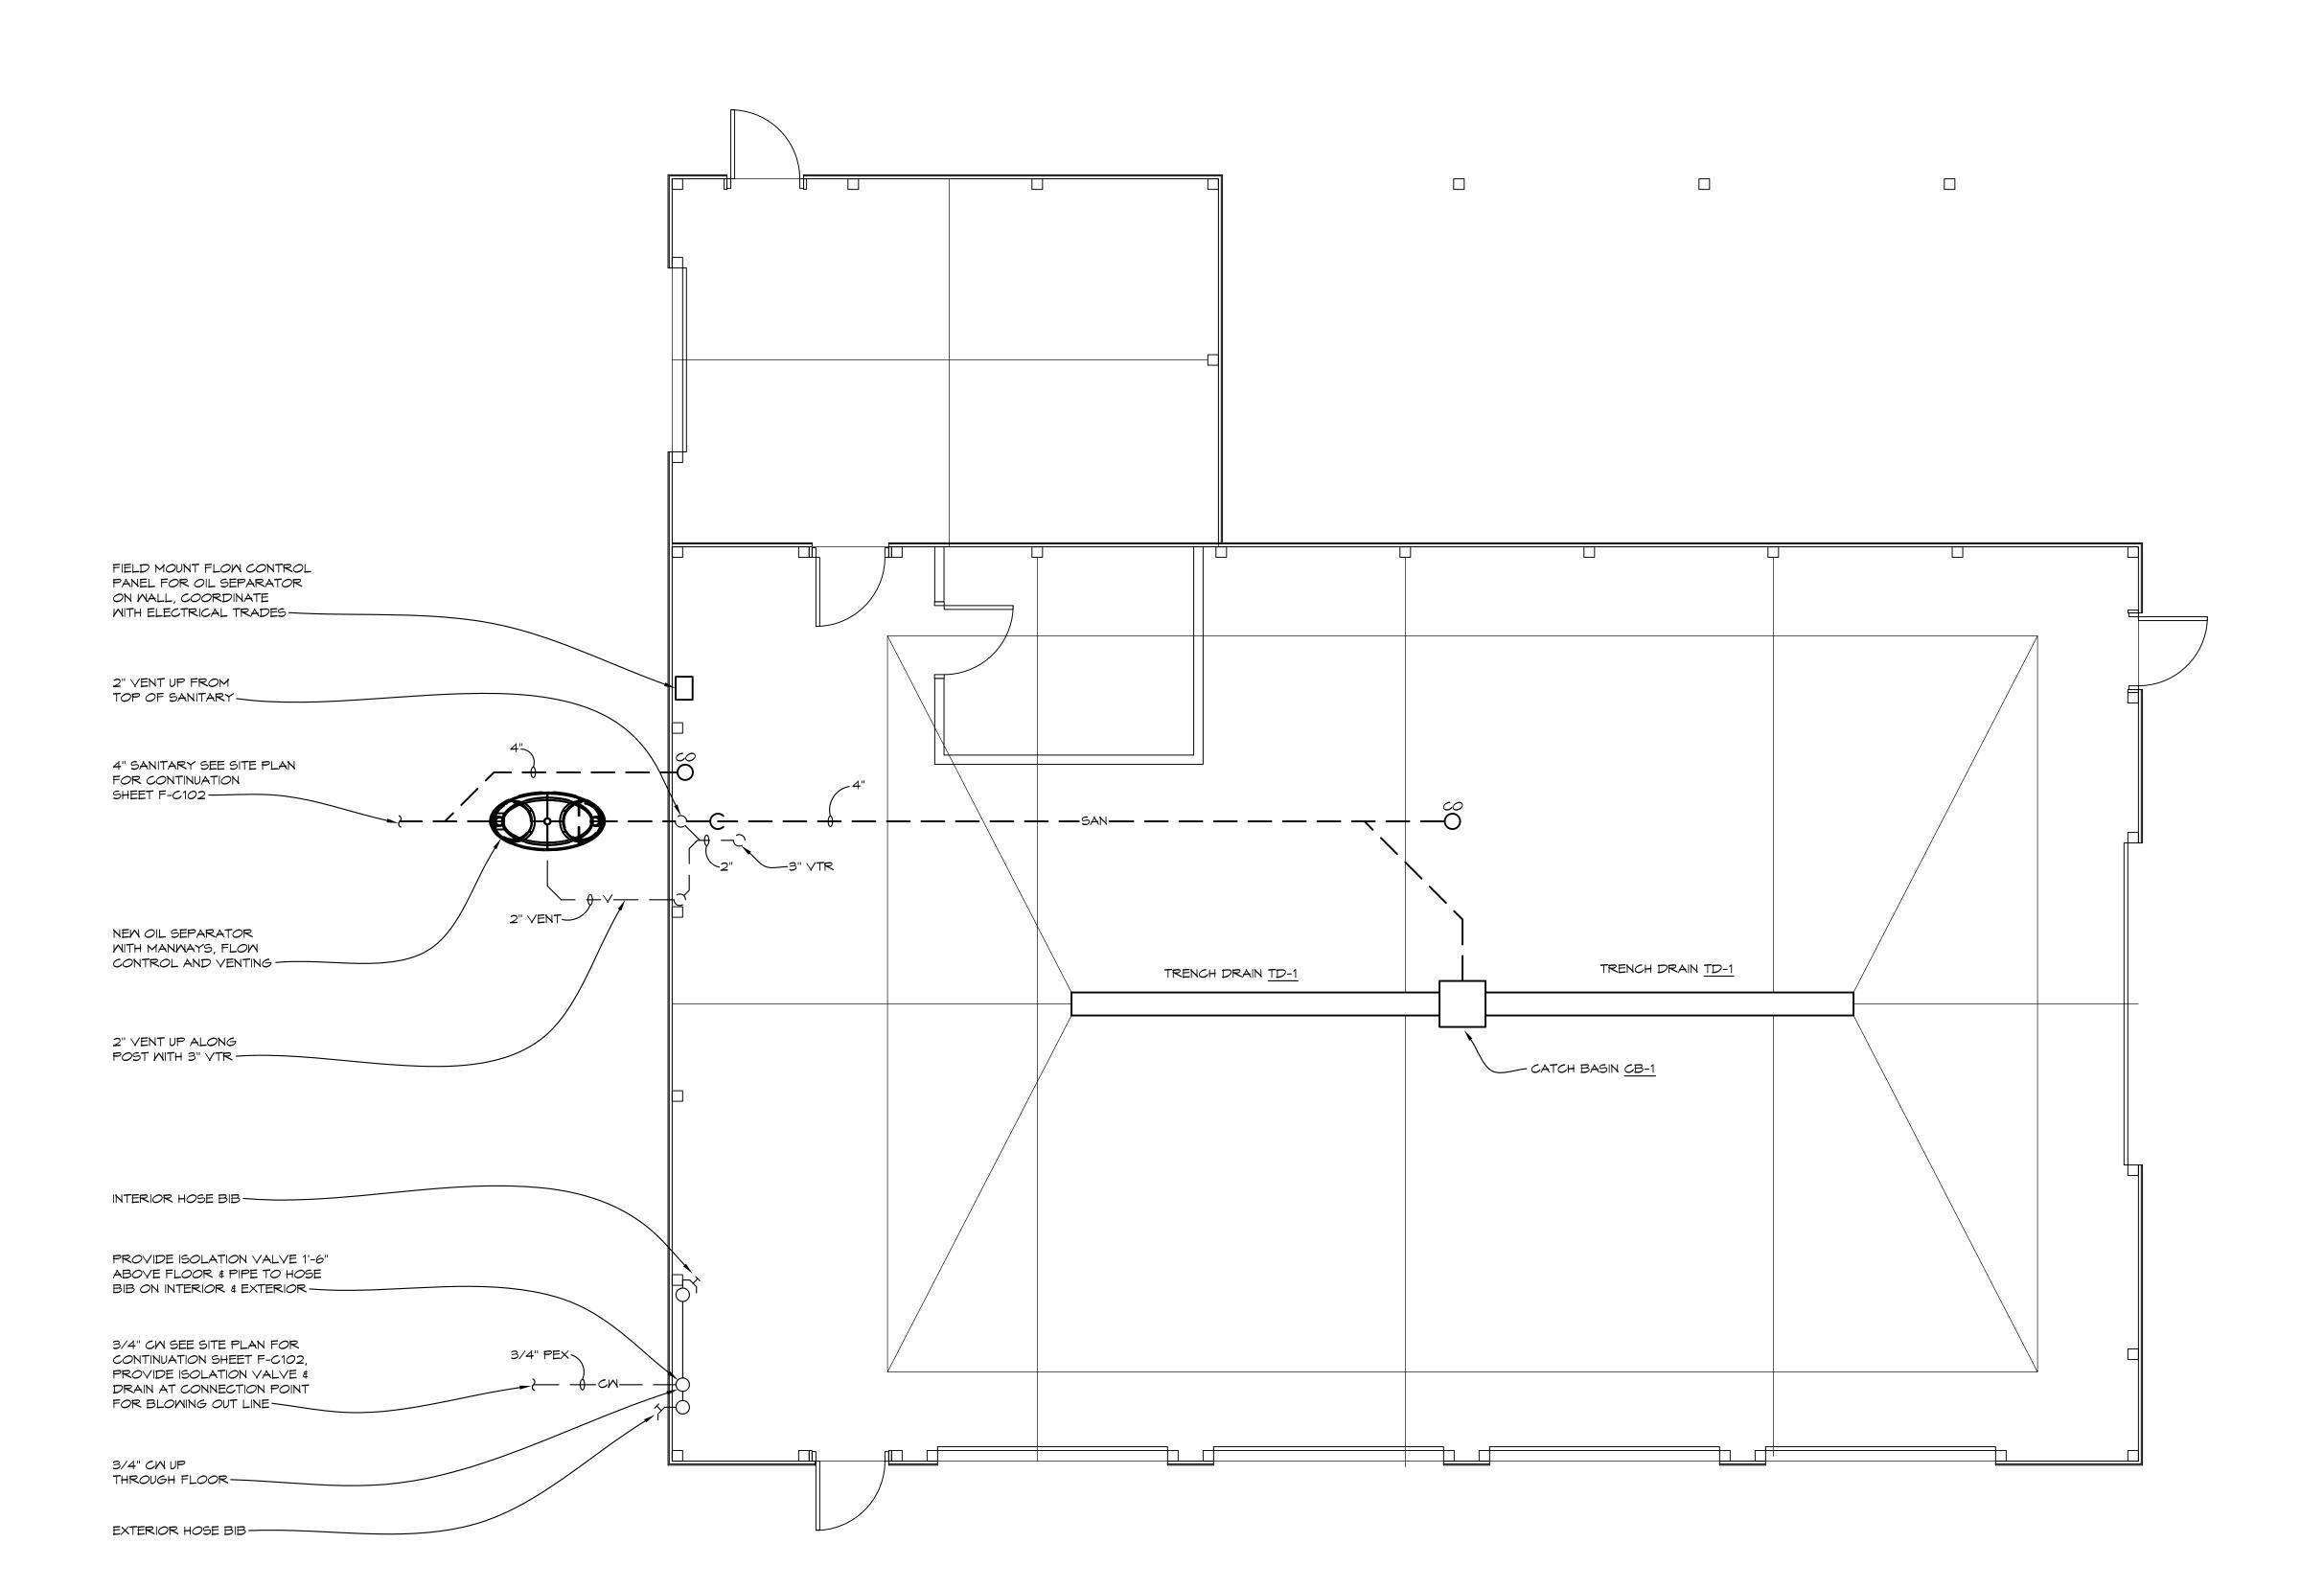



PLUMBING EQUIPMENT SCHEDULE

<u>OIL SEPARATOR</u> OIL INTERCEPTOR ZURN MODEL Z250H, 250 GALLON CAPACITY, 189 GALLON OIL CAPACITY, 48 GALLON OF SOLIDS CAPACITY, 100 GPM RATED WATER FLOW, 4" SCHEDULE 40 PVC INLET AND OUTLET, TWO 20" H-20 RATED FIBERGLASS BOLTED AND GASKETED FRAMES AND COVERS, TWO 3'-0" × 20" EXTENSION COLLARS, FIELD MOUNTED FLOW CONTROL, PROVIDE WITH ANTI-FLOAT TIE DOWNS AND DEAD MAN PER MANUFACTURES RETIREMENTS.


TRENCH DRAIN AND CATCH BASINS


ZURN PRE-SLOPED TRENCH DRAINS, CATCH BASIN WITH SEDIMENT BASKETS. SEE SPECIFICATION FOR ADDITION REQUIREMENTS

SEE PLUMBING SPECIFICATIONS FOR ADDITIONAL REQUIREMENTS AND LISTED EQUIVALENT MANUFACTURES. PROVIDE NEW TRAPS, STOPS, RISERS, TAIL PIECES, ETC. FOR NEW AND EXISTING FIXTURES FOR COMPLETE

GENERAL PLUMBING NOTES

- SEE ALL PLANS FOR REQUIRED WORK
- 2. OWNER HAS FIRST RIGHT OF REFUSAL, OTHERWISE DISPOSE FROM SITE.
- 3. FIELD VERIFY ALL EXISTING PIPING AND ADJUST PIPING AS REQUIRED FOR NEW WORK.
- 4. ALL WORK SHALL BE SCHEDULE WITH SCHOOL ANY INTERRUPTIONS OF HEATING, GAS, WATER SERVICE, POWER, ETC. SHALL BE COORDINATED TWO WEEK PRIOR TO REQUIRED WORK.
- 5. COORDINATE ALL WORK WITH ARCHITECTURAL AND ELECTRICAL DRAWINGS AND TRADES, VERIFY EXACT SIZES AND LOCATIONS OF ALL WALLS, OPENINGS, EQUIPMENT, ETC REQUIRED OF THESE TRADES.
- 6. AT AREAS OF DEMOLITION, CONTRACTOR IS RESPONSIBLE FOR REMOVING, CAPPING, DISCONNECTING ALL INCIDENTAL ITEMS.
- NOTATIONS ARE MADE IN VARIOUS PLACES ON THE DRAWINGS TO CALL ATTENTION TO DEMOLITION WHICH IS REQUIRED, HOMEVER, THESE DRAWINGS ARE NOT INTENDED TO SHOW EACH AND EVERY ITEM TO BE REMOVED. THE CONTRACTOR AND THE SUBCONTRACTORS FOR THE VARIOUS TRADES SHALL REMOVE THE MATERIALS RELATED TO THEIR RESPECTIVE TRADES AS REQUIRED TO PERMIT THE CONSTRUCTION OF THE NEW MORK AS SHOWN

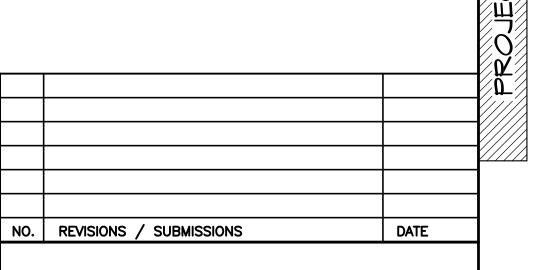

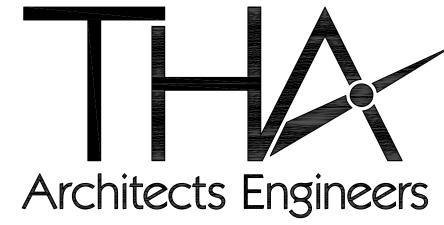

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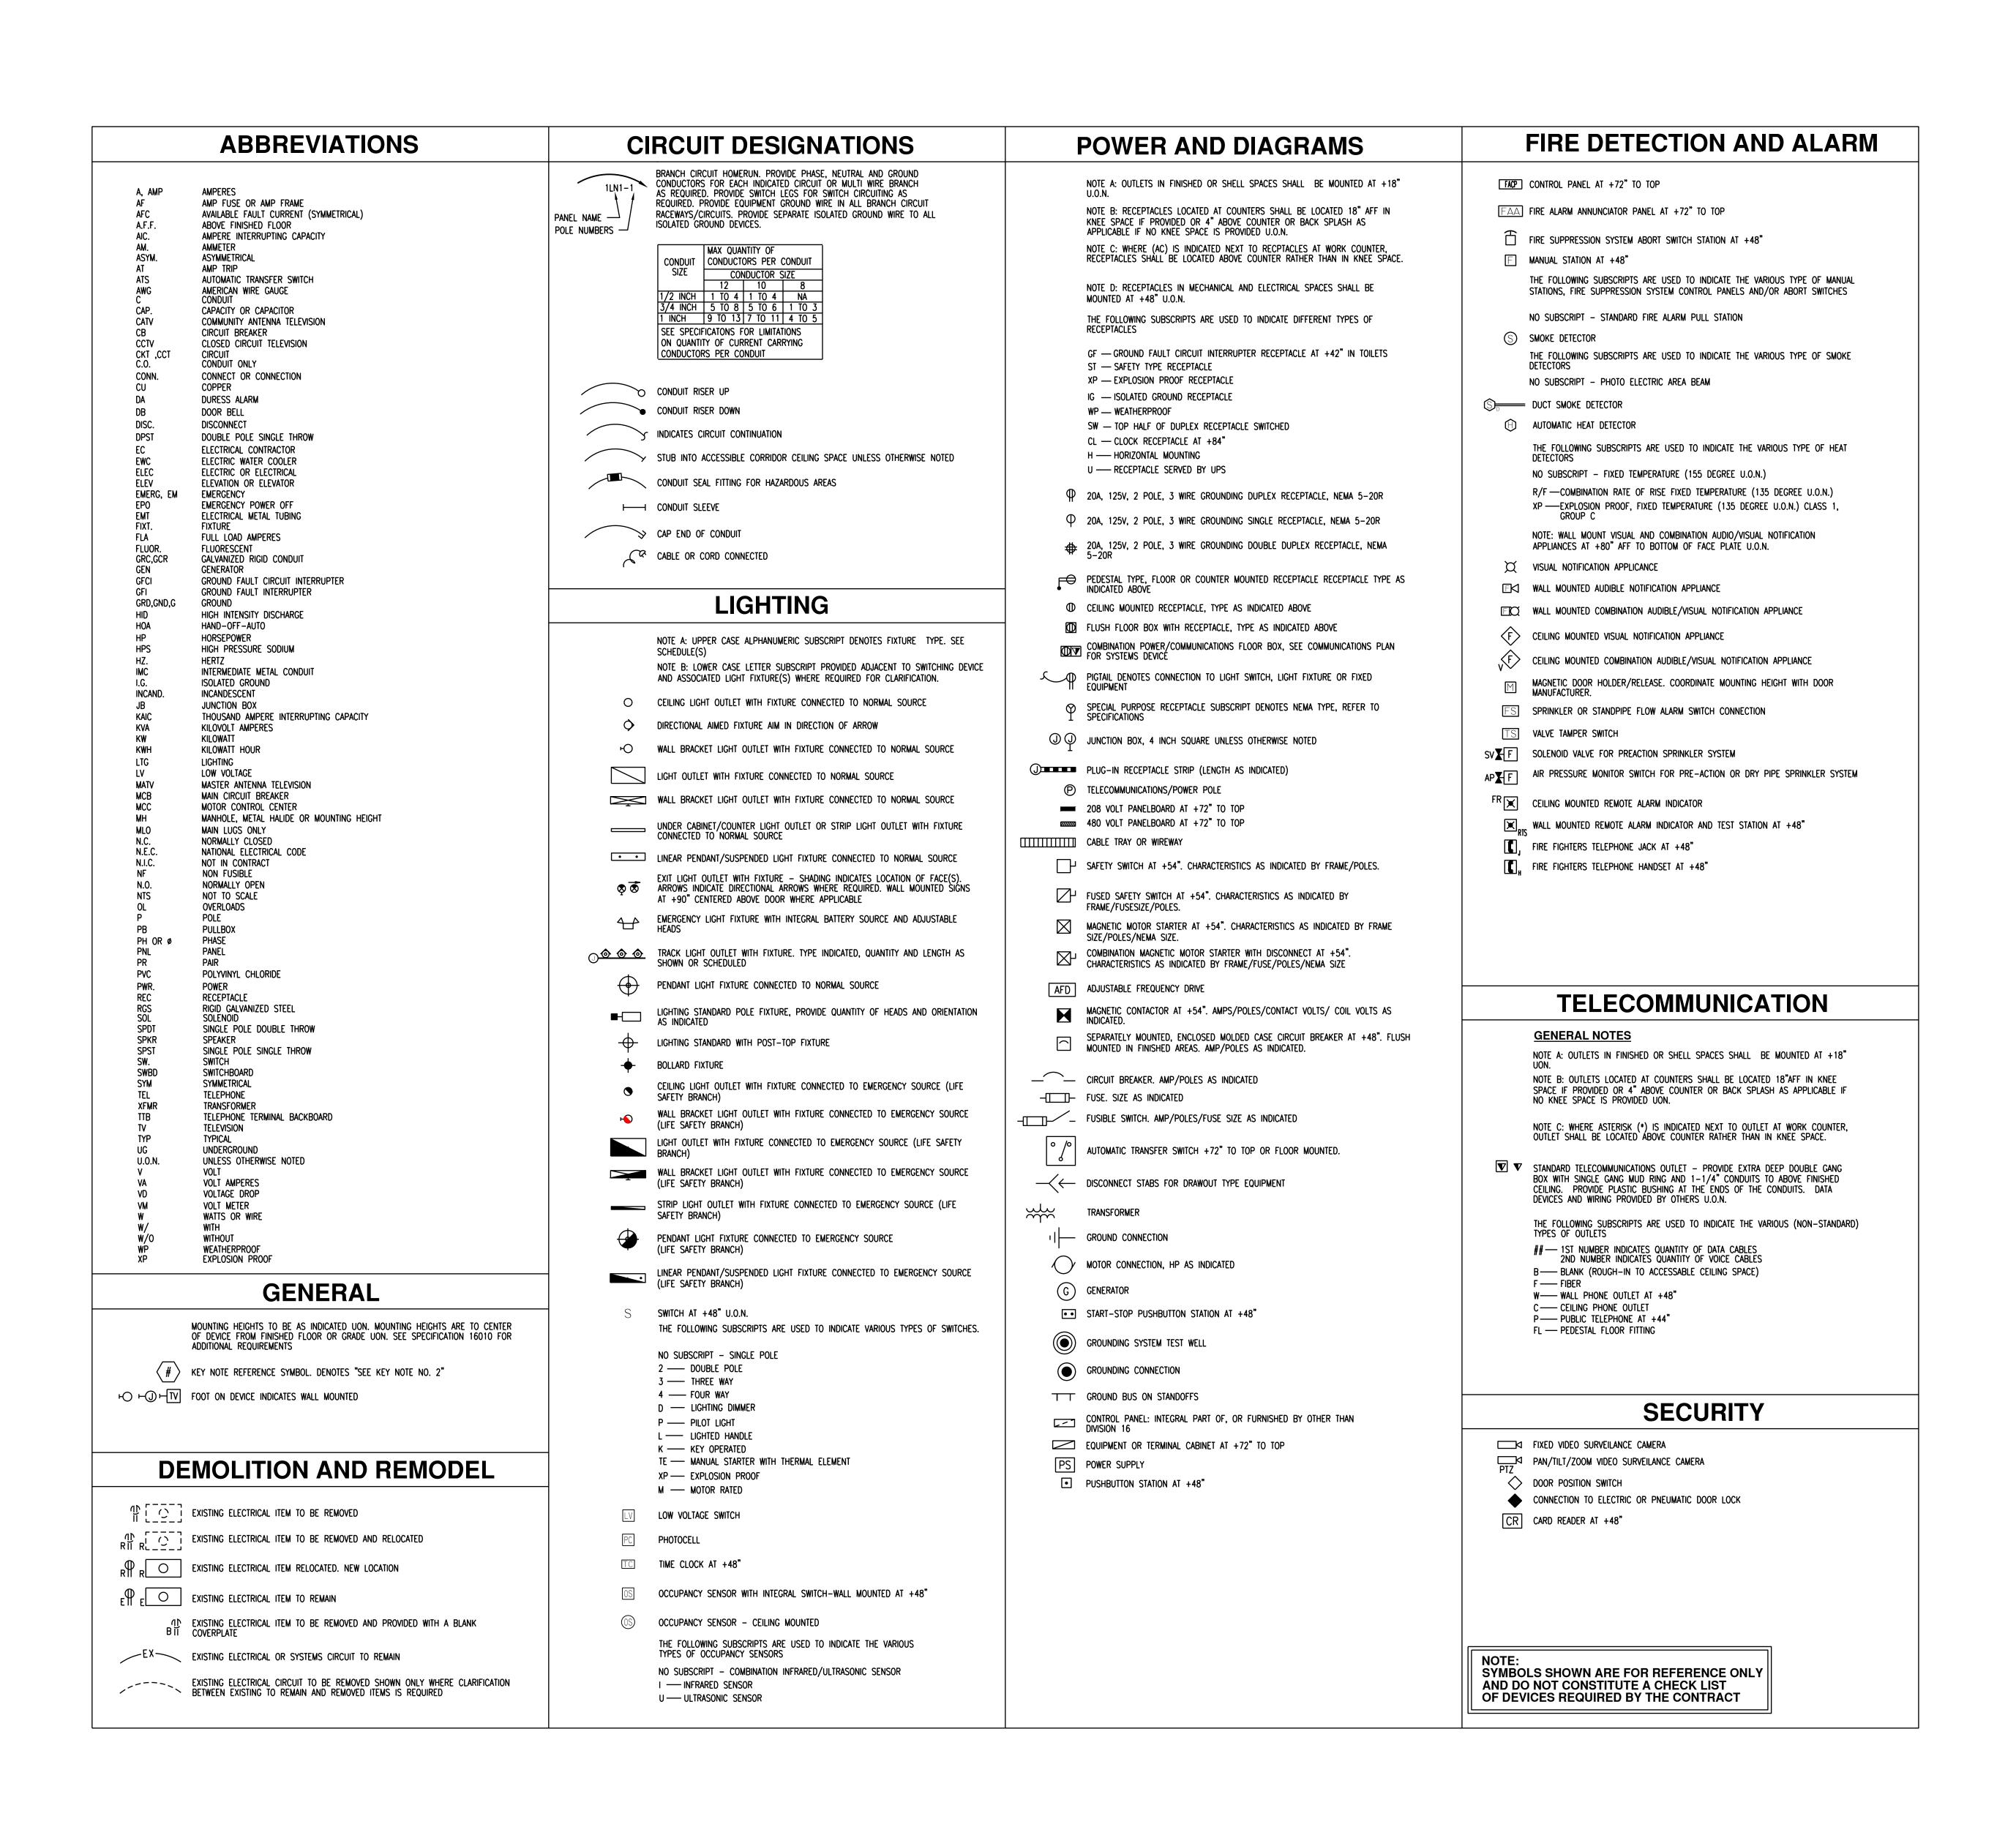
PROJECT 'F'

SITE WORK AT MAINTENANCE BUILDING & NEW POLE BARN

1420 SOUTH BADOUR ROAD MIDLAND, MI

POLE BARN PLUMBING PLAN

SEAL	DRAWN CJV/KLS	PROJECT NO. 24-120							
	CHECKED KLS	CAD FILE NO. F-P101							
	REVIEWED MLB	DRAWING NO.							
	DATE OCT 18, 2024	F-P101							
	SCALE 1/4"= 1'-0"	SHEET NO. _10 OF _13_							



NO. REVISIONS / SUBMISSIONS DATE



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PROJECT 'F'

SITE WORK AT MAINTENANCE BUILDING & NEW POLE BARN

1420 SOUTH BADOUR ROAD

MIDLAND, MI

DRAWING TITLE

Plot date: 10/22/2024 1:32 PM

ELECTRICAL COVER SHEET

DRAWN
TJA

PROJECT NO.
24-120

CHECKED
RCH

REVIEWED
REVIEWED
DATE
OCT 18, 2024

SCALE
AS NOTED

PROJECT NO.
24-120

CAD FILE NO.
F-E000

DRAWING NO.
F-E000

SHEET NO.
11 OF 13

AS NOTED

THA Architects Engineers - F-E000 ELECTRICAL COVER SHEET

